


CITY OF BRIDGEPORT PLAN

FOR THE

PEQUONNOCK RIVER TRAIL EXTENSION

IN THE CITY OF

BRIDGEPORT

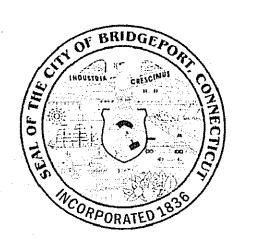

DESIGN S GENERAL PLANS: 1 IN. = 20 FT.


SCALES TYPICAL SECTIONS: 1 IN. = 2 FT.

OTHER SCALES AS NOTED

CTDOT PROJECT NO.: 15-374

FEDERAL AID PROJECT NO.: (PEDS) 221

	LIST OF DRAWINGS	
SHEET NO.	DRAWING TITLE	DRAWING NO.
1	COVER SHEET	
2	ESTIMATE OF QUANTITIES	ES-01
3	GENERAL NOTES AND LEGEND	GNL-01
4-5	SURVEY CONTROL PLANS	SC-01 TO SC-02
6-12	TYPICAL SECTIONS	TS-01 TO TS-07
13-43	CONSTRUCTION PLANS	CP-01 TO CP-31
44-51	MISCELLANEOUS DETAILS	MD-01 TO MD-08
52	SEDIMENTATION AND EROSION CONTROL	SEC-01
53	MISCELLANEOUS TABLES	MT-01
54-59	MAINTENANCE AND PROTECTION OF TRAFFIC	MPT-01 TO MPT-06
60	PROFILE	PR-01
	SECTIONS	

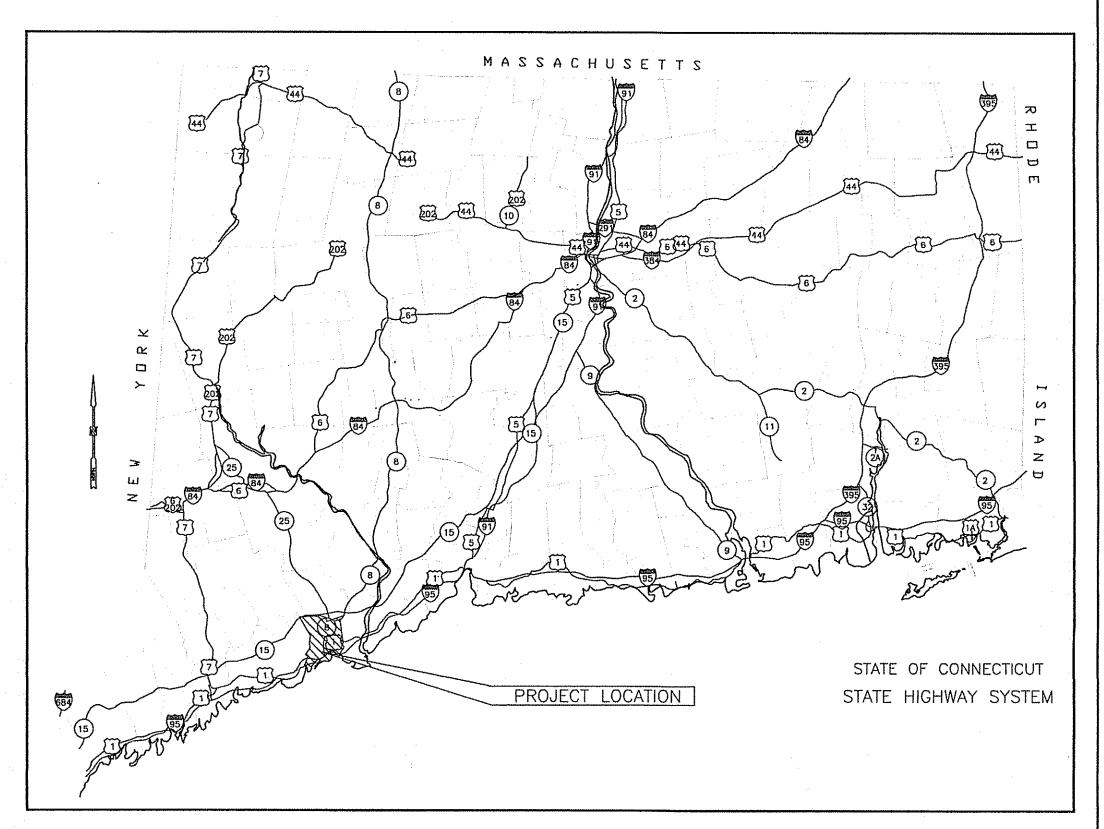

SPECIFICATIONS FORM 817 GOVERN, INCLUDING ALL SUPPLEMENTS THERETO DATED JANUARY 2019 AND TECHNICAL SPECIFICATIONS (SPECIAL PROVISIONS).

ALL ELEVATIONS ON THIS PROJECT BASED ON NAVD88 COORDINATES BASED ON NORTH AMERICAN DATUM (NAD 1983)

PROJECT NO.: 15-374 F.A.P. NO.: (PEDS) 221

APPROVED BY:

JON URQUIDI, P.E., ENGINEERING DEPARTMENT, CITY OF BRIDGEPORT

DATE:

SUBMITTED BY:

DATE: 6/4/20

STEPHEN NORMANDIN, P.E., NV5 - CT PE LIC. No. 22270

DESIGNED BY:

63 UNQUOWA ROAD, 2ND FL FAIRFIELD, CT 06824 P: 203.956.0515 WWW.NV5


																										F	ROADWA	Y ITEMS	;																											
ITEM NUMBER	0201225A	0202000	0202529	0205003	0207000	0219003	0219050	0304002	0406171	0406172	0406236	0507006	0507010	0507014	0507094	0507201	0507224	0507105	0507316	0507567	0507682	0507701	0507721	0507748	0507758	0507899	0601365 0601445A	0651010	0651051	0651719	0813041	0913862	0921001	0921005	0921013	0921039	0922001	0923001	0944000	9000960	0969062A	0970007	4880C001	1003910A	1208931A	1210101	1210102	1210103	1210105	1210106	1210114	1211001	1303202A	0201001	0971106A	0980001
ITEM DESCRIPTION	REMOVE AND RELOCATE IRRIGATION CONTROL BOX	EARTH EXCAVATION	CUT BITUMINOUS CONCRETE PAVEMENT	TRENCH EXCAVATION (0' - 10' DEEP)			CATCH BASIN SEDIMENT FILTER	PROCESSED AGGREGATE BASE	HMA S0.50	HMA S0.375	MATERIAL FOR TACK COAT	TYPE "C" CATCH BASIN TOP	TYPE "C-L" CATCH BASIN FRAME AND GRATE	TYPE "C" CATCH BASIN - FRAME AND GRATE	SPECIAL TYPE CATCH BASIN	TYPE 'C-L' CATCH BASIN	TYPE "C-L" CATCH BASIN TOP	CATCH BASIN	TYPE "C-L" CATCH BASIN DOUBLE GRATE - TYPE II TOP (MODIFIED)	MANHOLE FRAME AND COVER	MANHOLE - 5' DIAMETER	RESET TYPE "C" CATCH BASIN	YPE "C-L" CATCH BASIN	RESET TYPE "C-L" CATCH BASIN DOUBLE GRATE - TYPE II	RESET MANHOLE (STORM)	OFFSET CATCH BASIN	CONCRETE PAD EMBANKMENT WALL (SITE NO. 1)	10" CONCRETE PIPE	12" R.C. PIPE CLASS V	12" DUCTILE IRON PIPE	6" X 18" GRANITE STONE CURBING	20' CHAIN LINK SLIDING GATE, 6' HIGH	CONCRETE SIDEWALK	CONCRETE SIDEWALK RAMPS	CONCRETE DRIVEWAY APRON	DETECTABLE WARNING STRIP	BITUMINOUS CONCRETE SIDEWALK	BITUMINOUS CONCRETE FOR PATCHING	FURNISHING AND PLACING TOPSOIL	TURE ESTABLISHMENT	CONSTRUCTION FIELD OFFICE, MEDIUM	TRAFFICPERSON (UNIFORMED FLAGGER)	\circ	BALLAST)	SIGN FACE - SHEET ALUMINUM (17PE IX REFLECTIVE SHEETING)	4" WHITE EPOXY RESIN PAVEMENT MARKINGS	4" YELLOW EPOXY RESIN PAVEMENT MARKINGS	6" WHITE EPOXY RESIN PAVEMENT MARKINGS	EPOXY RESIN PAVEMENT MARKINGS, SYMBOLS AND LEGENDS	12" WHITE EPOXY RESIN PAVEMENT MARKINGS	6" YELLOW EPOXY RESIN PAVEMENT MARKINGS	REMOVAL OF PAVEMENT MARKINGS	INSTALL FIRE HYDRANT ASSEMBLY	CLEARING & GRUBBING	MAINTENANCE AND PROTECTION OF TRAFFIC	CONSTRUCTION STAKING
UNIT	LS	CY	LF	CY CY	, L	.F E	A CY	/ TON	N TC	N GA	L E	EA E	EA E	ΞA F	<u> </u>	A EA	. E	:A	EA	EA	EA E	EA E	A	EA E	EA E	A CY	LS	LF	LF	LF	LF	EA	SF	SF	SF	EA	SY TO	ON S	Y SY	МО	HR	R EA	E	\	SF L	LF I	LF L	LF	SF	LF	LF S	SF E	EA LS	S LS	3 LS	LS
SUBTOTAL			2,850				5 290			5 18		2		2	1	2	1 1		1	1	1	2	1	1	1	2 3	1	4			2,180		14,90			20 4		0 75									3,76			,610			4 1	1 1	1 1	1
UNASSIGNED QUANTITES	0			20 20		30) 10			0	0		0	0	0 0		0	0	0	0	0	0	0	0	0 0	0	0			120		800		150				0 60			0 0			40 50		⁷ 20 46			90				0 0	0 0	0
TOTAL	1			375 300			5 310			5 19		2	3	2	1	2		12	1	1	1	2	1	1	1	2 3	1	4	36		2,300		15,70			20 4		10 81												,700			4	1 1	1 1	1

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REV.	DATE	DESCRIPTION	SHEET. NO.
		REVISIONS	

DESIGNER: M. BORST

DRAFTER: M. BORST

CHECKED BY: S. NORMANDIN

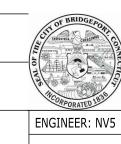

CITY OF BRIDGEPORT



PEQUONNOCK RIVER TRAIL **EXTENSION**

TOWN:	
	CITY OF BRIDGEPORT

DRAWING TITLE:

DRAWING NO.:

ES-1 **ESTIMATE** SHEET NO.:

DOT PROJ: 15-374

APPROVED BY:

DATE: JUNE 3, 2020

GENERAL CONSTRUCTION NOTES:

- 1. THERE SHALL BE A MANDATORY PRE-CONSTRUCTION MEETING BETWEEN THE CONTRACTOR AND ALL AFFECTED UTILITY COMPANIES AND THE CITY OF BRIDGEPORT PRIOR TO CONSTRUCTION.
- 2. THE CITY OF BRIDGEPORT RESERVES THE RIGHT TO ALTER THE LINE, GRADE, PLANS, FORM, DIMENSIONS, MATERIALS OR ANY PART THEREOF IF THE EXISTING CONDITIONS WARRANT.
- 3. ALL MATERIALS AND METHODS OF CONSTRUCTION SHALL CONFORM TO THE LATEST EDITION OF THE STATE OF CONNECTICUT DEPARTMENT OF TRANSPORTATION STANDARD SPECIFICATIONS FOR ROADS, BRIDGES AND INCIDENTAL CONSTRUCTION, FORM 817, AS AMENDED BY THE CITY OF BRIDGEPORT.
- 4. THE CONTRACTOR SHALL OBTAIN A STREET OPENING PERMIT FROM THE CITY OF BRIDGEPORT PRIOR TO CONSTRUCTION. COMPLIANCE WITH THE PERMIT CONDITIONS IS THE RESPONSIBILITY OF THE CONTRACTOR.
- 5. TOPOGRAPHIC AND EXISTING CONDITIONS SHOWN ON THE PLANS ARE BASED ON SITE SURVEY MAPS PREPARED BY FREEMAN COMPANIES.
- 6. ALL DIMENSIONS AND ELEVATIONS SHALL BE VERIFIED IN THE FIELD PRIOR TO CONSTRUCTION. ANY DISCREPANCIES SHALL BE BROUGHT TO THE ATTENTION OF THE ENGINEER.
- 7. THE PLANS REQUIRE A CONTRACTOR'S WORKING KNOWLEDGE OF LOCAL, MUNICIPAL, WATER AUTHORITY AND STATE CODES FOR UTILITY SYSTEMS. ANY CONFLICTS BETWEEN MATERIALS AND LOCATIONS SHOWN, AND LOCAL REQUIREMENTS SHALL BE BROUGHT TO THE ATTENTION OF THE ENGINEER PRIOR TO THE EXECUTION OF THE WORK. THE CITY WILL NOT BE HELD LIABLE FOR COSTS INCURRED TO IMPLEMENT OR CORRECT WORK WHICH DOES NOT CONFORM TO A LOCAL CODE.
- 8. INFORMATION REGARDING THE LOCATION OF EXISTING UTILITIES HAS BEEN BASED UPON AVAILABLE INFORMATION AND MAY BE INCOMPLETE. AND WHERE SHOWN SHOULD BE CONSIDERED APPROXIMATE. THE LOCATION OF ALL EXISTING UTILITIES SHALL BE CONFIRMED PRIOR TO BEGINNING OF CONSTRUCTION. THE CONTRACTOR SHALL CONTACT THE "CALL BEFORE YOU DIG" LOCATING SERVICE AT 1-800-922-4455 AT LEAST 48 HOURS PRIOR TO THE START OF CONSTRUCTION. ALL UTILITY LOCATIONS THAT DO NOT MATCH THE VERTICAL OR HORIZONTAL CONTROL SHOWN OF THE PLANS SHALL IMMEDIATELY BE BROUGHT TO THE ATTENTION OF THE ENGINEER FOR RESOLUTION.
- 9. THE CONTRACTOR SHALL BE RESPONSIBLE FOR THE PROTECTION OF ALL ADJACENT PROPERTIES, FACILITIES AND UTILITIES IN ACCORDANCE WITH FORM 817 SECTION 1.07.03. THE CONTRACTOR SHALL COORDINATE HIS WORK WITH WORK PERFORMED BY THE UTILITY COMPANIES. EXISTING UTILITY SERVICES WHICH ARE TO BE RELOCATED OR REMOVED WILL BE SO RELOCATED OR REMOVED BY OTHERS AT NO EXPENSE TO THE CONTRACTOR.

- 10. EXCAVATION OF ANY TYPE SHALL BE ACCOMPLISHED IN SUCH MANNER THAT UNDERGROUND UTILITIES OR STRUCTURES ARE NOT DAMAGED. IT SHALL BE THE CONTRACTOR'S SOLE RESPONSIBILITY FOR ANY DAMAGE INCURRED DURING EXCAVATION OPERATIONS. ALL COSTS RELATED TO THE REPAIR OF DAMAGED UTILITIES SHALL BE BOURNE BY THE CONTRACTOR AT NO ADDITIONAL COST TO THE CITY.
- 11. NEW PEDESTRIAN CONCRETE SIDEWALK AND RAMPS SHALL CONFORM TO THE LATEST "AMERICAN WITH DISABILITIES" ACT REQUIREMENTS.
- 12. LIMIT OF CONSTRUCTION (SLOPE LIMITS) SHALL BE AS SHOWN ON THE PLANS. WHERE NO SLOPE LIMIT IS SHOWN, IT SHALL BE TAKEN TO BE ONE (1') FOOT BEHIND THE BACK OF WALK OR CO-INCIDENT WITH THE BACK OF WALK WHERE ADJACENT TO EXISTING RETAINING WALLS OR OTHER STRUCTURES.
- 13. THE CONTRACTOR SHALL MAKE AN EFFORT TO MINIMIZE DISTURBANCE TO ALL AREAS OUTSIDE THE LIMITS OF CONSTRUCTION. ANY AREAS DISTURBED SHALL BE RESTORED TO AS NEAR ORIGINAL CONDITION AS POSSIBLE, INCLUDING THE RESTORATION OR REPLACEMENT OF SHRUBS OR BUSHES (IF ANY). ALL VEGETATED AREAS SHALL RECEIVE A MINIMUM OF SIX (6") INCHES OF TOPSOIL AND BE SEEDED WITH GRASS, OR SODDED, AS SHOWN ON THE PLANS OR AS DIRECTED BY THE ENGINEER.
- 14. STREET SIGNS AND TRAFFIC SIGNS SHALL BE INSTALLED AS SHOWN ON THE PLANS OR AS DIRECTED BY THE CITY OF BRIDGEPORT TRAFFIC ENGINEER.
- 15. SIGN POST SLEEVES SHALL BE INSTALLED FOR ALL NEW OR RE-INSTALLED TRAFFIC SIGNS ALONG ALL SIDEWALK AREAS OR AS DIRECTED BY THE ENGINEER.
- 16. ALL DRAINAGE, SEDIMENTATION AND EROSION CONTROLS INSTALLED DURING CONSTRUCTION ARE THE RESPONSIBILITY OF THE CONTRACTOR AND SHALL COMPLY WITH ALL FEDERAL, STATE AND LOCAL REGULATIONS.
- 17. THE SITE SHALL BE KEPT CLEAN OF LOOSE DEBRIS LITTER, AND BUILDING MATERIALS SUCH THAT NONE OF THE ABOVE ENTERS STREAMS OR WETLANDS.
- 18. ALL DEWATERING WASTEWATERS SHALL BE DISCHARGED IN A MANNER WHICH MINIMIZES DISCOLORATION OR POLLUTION OF THE RECEIVING WATERS.
- 19. ALL FUEL, OIL, PAINT OR OTHER HAZARDOUS MATERIALS SHALL BE STORED IN A SECONDARY CONTAINER AND REMOVED TO A LOCKED INDOOR AREA WITH AN IMPERVIOUS FLOOR DURING NON-WORK HOURS.
- 20. A COPY OF ALL PLANS, INCLUDING REVISIONS, SHALL BE MAINTAINED ON-SITE AT ALL TIMES DURING CONSTRUCTION.
- 21. ALL ELEVATIONS ON THIS PROJECT BASED ON NORTH AMERICAN GEODETIC VERTICAL DATUM 1988 (NAVD 88).
- 22. HORIZONTAL DATUM IS BASED ON CONNECTICUT COORDINATE SYSTEM (NAD 83).

DESIGNER: M. BORST

DRAFTER: M. BORST

CHECKED BY: S. NORMANDIN

- 23. TEMPORARY PAVEMENT PATCHING FOR ALL UTILITY TRENCHES IN ROADWAY OR SIDEWALK AREAS SHALL BE (2) 2" LIFTS OF HMA SO.5 TRAFFIC LEVEL 2 AND 12" PROCESSED AGGREGATE BASE. TEMPORARY ASPHALT PATCHING TO BE PAID FOR UNDER ITEM 0923001.
- 24. ENGINEER MAY ORDER TEMPORARY PATCHING OF ANY PAVEMENT SURFACES OR PEDESTRIAN WALKWAY THAT HAS BEEN DAMAGED OR BECOME UNUSABLE. THIS WORK SHALL BE PAID FOR UNDER ITEM NO 0923001 BITUMINOUS CONCRETE FOR PATCHING.
- 25. THE CONTRACTOR SHALL CONFORM TO THE MANUAL ON UNIFORM TRAFFIC CONTROL DEVICES (MUTCD).
- 26. CONTRACTOR SHALL COORDINATE WITH APPROPRIATE UTILITY REGARDING ALL UTILITY MANHOLES, GATES, BOXES AND FRAMES ETC. AFFECTED BY THE PROPOSED CONSTRUCTION ACTIVITIES.
- 27. THE CONTRACTOR IS ADVISED THE DOWNTOWN INTERMODAL URBAN DESIGN ENHANCEMENT PROJECT - WATER STREET (ROUTE 130) MAY BE UNDER CONSTRUCTION AT THE SAME TIME AS THIS CONTRACT. THE CONTRACTOR SHALL COORDINATE HIS ACTIVITIES WITH THE CITY AND THE DOWNTOWN INTERMODAL URBAN DESIGN ENHANCEMENT PROJECT AT NO ADDITIONAL COST. IN THE EVENT THE INTERMODAL PROJECT HAS NOT BEEN COMPLETED, THE CONTRACTOR UPON WRITTEN DIRECTION FROM THE CITY, SHALL PROCEED WITH WATER STREET "OPTION 1".
- 28. INCREASE THE PROCESSED AGGREGATE BASE THICKNESS OF THE BIKE TRAIL TO 12" IN AREAS OF POOR DRAINAGE OR SOILS CONDITIONS AS DETERMINED BY THE ENGINEER.
- 29. PRUNE ROOTS OUTSIDE THE LIMITS OF GRADING PRIOR TO CLEARING AND GRUBBING OF THE BIKE TRAIL TO PREVENT HEAVES IN THE PAVEMENT STRUCTURE.
- 30. CONTRACTOR IS RESPONSIBLE FOR COORDINATING ALL WORK WITH UTILITIES.

SOIL EROSION CONTROL NOTES:

- 1. THE EROSION AND SEDIMENT CONTROL MEASURES SHOWN SHALL BE CONSIDERED AS MINIMUM.
- 2. ALL EROSION AND SEDIMENT CONTROL MEASURES SHALL BE INSTALLED AND MAINTAINED IN ACCORDANCE WITH THE "CONNECTICUT GUIDELINES FOR SOIL EROSION AND SEDIMENT CONTROL 2002" AVAILABLE FROM CONNECTICUT D.E.E.P.
- 3. ALL AREAS THAT ARE TO BE DISTURBED SHALL BE KEPT TO A MINIMUM, AREAS NOT TO BE PAVED SHALL BE LOAMED, LIMED, FERTILIZED AND SEEDED AS SOON AS PRACTICAL. IF PERMANENT, MULCH STABILIZED UNTIL SUCH SEEDING CAN BE DONE. SLOPES STEEPER THAN 3:1 SHALL BE FURTHER STABILIZED USING JUTE MATTING.
- 4. THE CONTRACTOR SHALL BE RESPONSIBLE FOR INSPECTION AND MAINTENANCE OF ALL SEDIMENT CONTROL DEVICES. EXCESS SEDIMENT SHALL BE REDISTRIBUTED ON THE SITE.
- 5. TOPSOIL SHALL BE STOCKPILED IN COMPACT AREAS. THE PILE(S) SHALL BE STABILIZED USING A TEMPORARY VEGETATIVE COVER OR WITH JUTE MATTING. A CONTINUOUS STAKED BALED HAY CHECK DAM SHALL BE INSTALLED AROUND THE BASE PERIMETER(S).
- 6. ALL EXISTING VEGETATIVE COVER NOT REQUIRED TO BE REMOVED FOR CONSTRUCTION SHALL REMAIN UNDISTURBED.

- 7. PERMANENT VEGETATIVE COVER SHALL CONFORM TO SEEDING SCHEDULES GIVEN IN FIG. PS-3 NO. 1 AND TEMPORARY VEGETATIVE COVER SHALL CONFORM TO TS-2 DOT ALL PURPOSE MIX FOUND IN THE "2002 CONNECTICUT GUIDELINES FOR EROSION & SEDIMENT CONTROL".
- 8. ALL EROSION & SEDIMENT CONTROL MEASURES SHALL BE INSTALLED PRIOR TO THE REMOVAL OF ANY VEGETATION.
- 9. TEMPORARY SEEDING (TS) SHALL BE DONE WITHIN THE FIRST 7 DAYS OF SUSPENDED WORK ON GRADING OPERATIONS THAT EXPOSE ERODIBLE SOILS, WHERE SUCH SUSPENSION IS EXPECTED TO LAST 1 TO 12 MONTHS. SUCH AREAS INCLUDE SOIL STOCKPILES AND OTHER DISTURBED AREAS.

CONNECTICUT DEPARTMENT OF TRANSPORTATION STANDARD SHEETS

HIGHWAY STANDARD SHEETS HW-586-01 HW-586-03 HW-586-06 HW-586-07 HW-586-08 HW-586-10A & C HW-913-02 HW-921-01	TRAFFIC STANDARD SHEETS TR-1208_01 TR-1208_02 TR-1210_04 TR-1210_08 TR-1210_09 TR-1220_01 TR-1220_02
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CONSTRUCTION LEGEND:

PROPOSED FULL DEPTH PAVEMENT AREA

PROPOSED TOPSOIL AND SEED

PROPOSED CONCRETE SIDEWALK

EXISTING RIGHT OF WAY

PROPOSED GRANITE CURB

4.7 .. 7

PROPOSED CATCH BASIN PROPOSED MANHOLE

EXISTING CATCH BASIN

EXISTING MANHOLE

REV. DATE DESCRIPTION SHEET. NO. REVISIONS

ENGINEER: NV5

APPROVED BY:

CITY OF BRIDGEPORT





PEQUONNOCK RIVER TRAIL **EXTENSION**


CITY OF BRIDGEPORT


DRAWING NO.: GN-1


DOT PROJ: 15-374


DRAWING TITLE: GENERAL NOTES AND LEGEND

SHEET NO.:

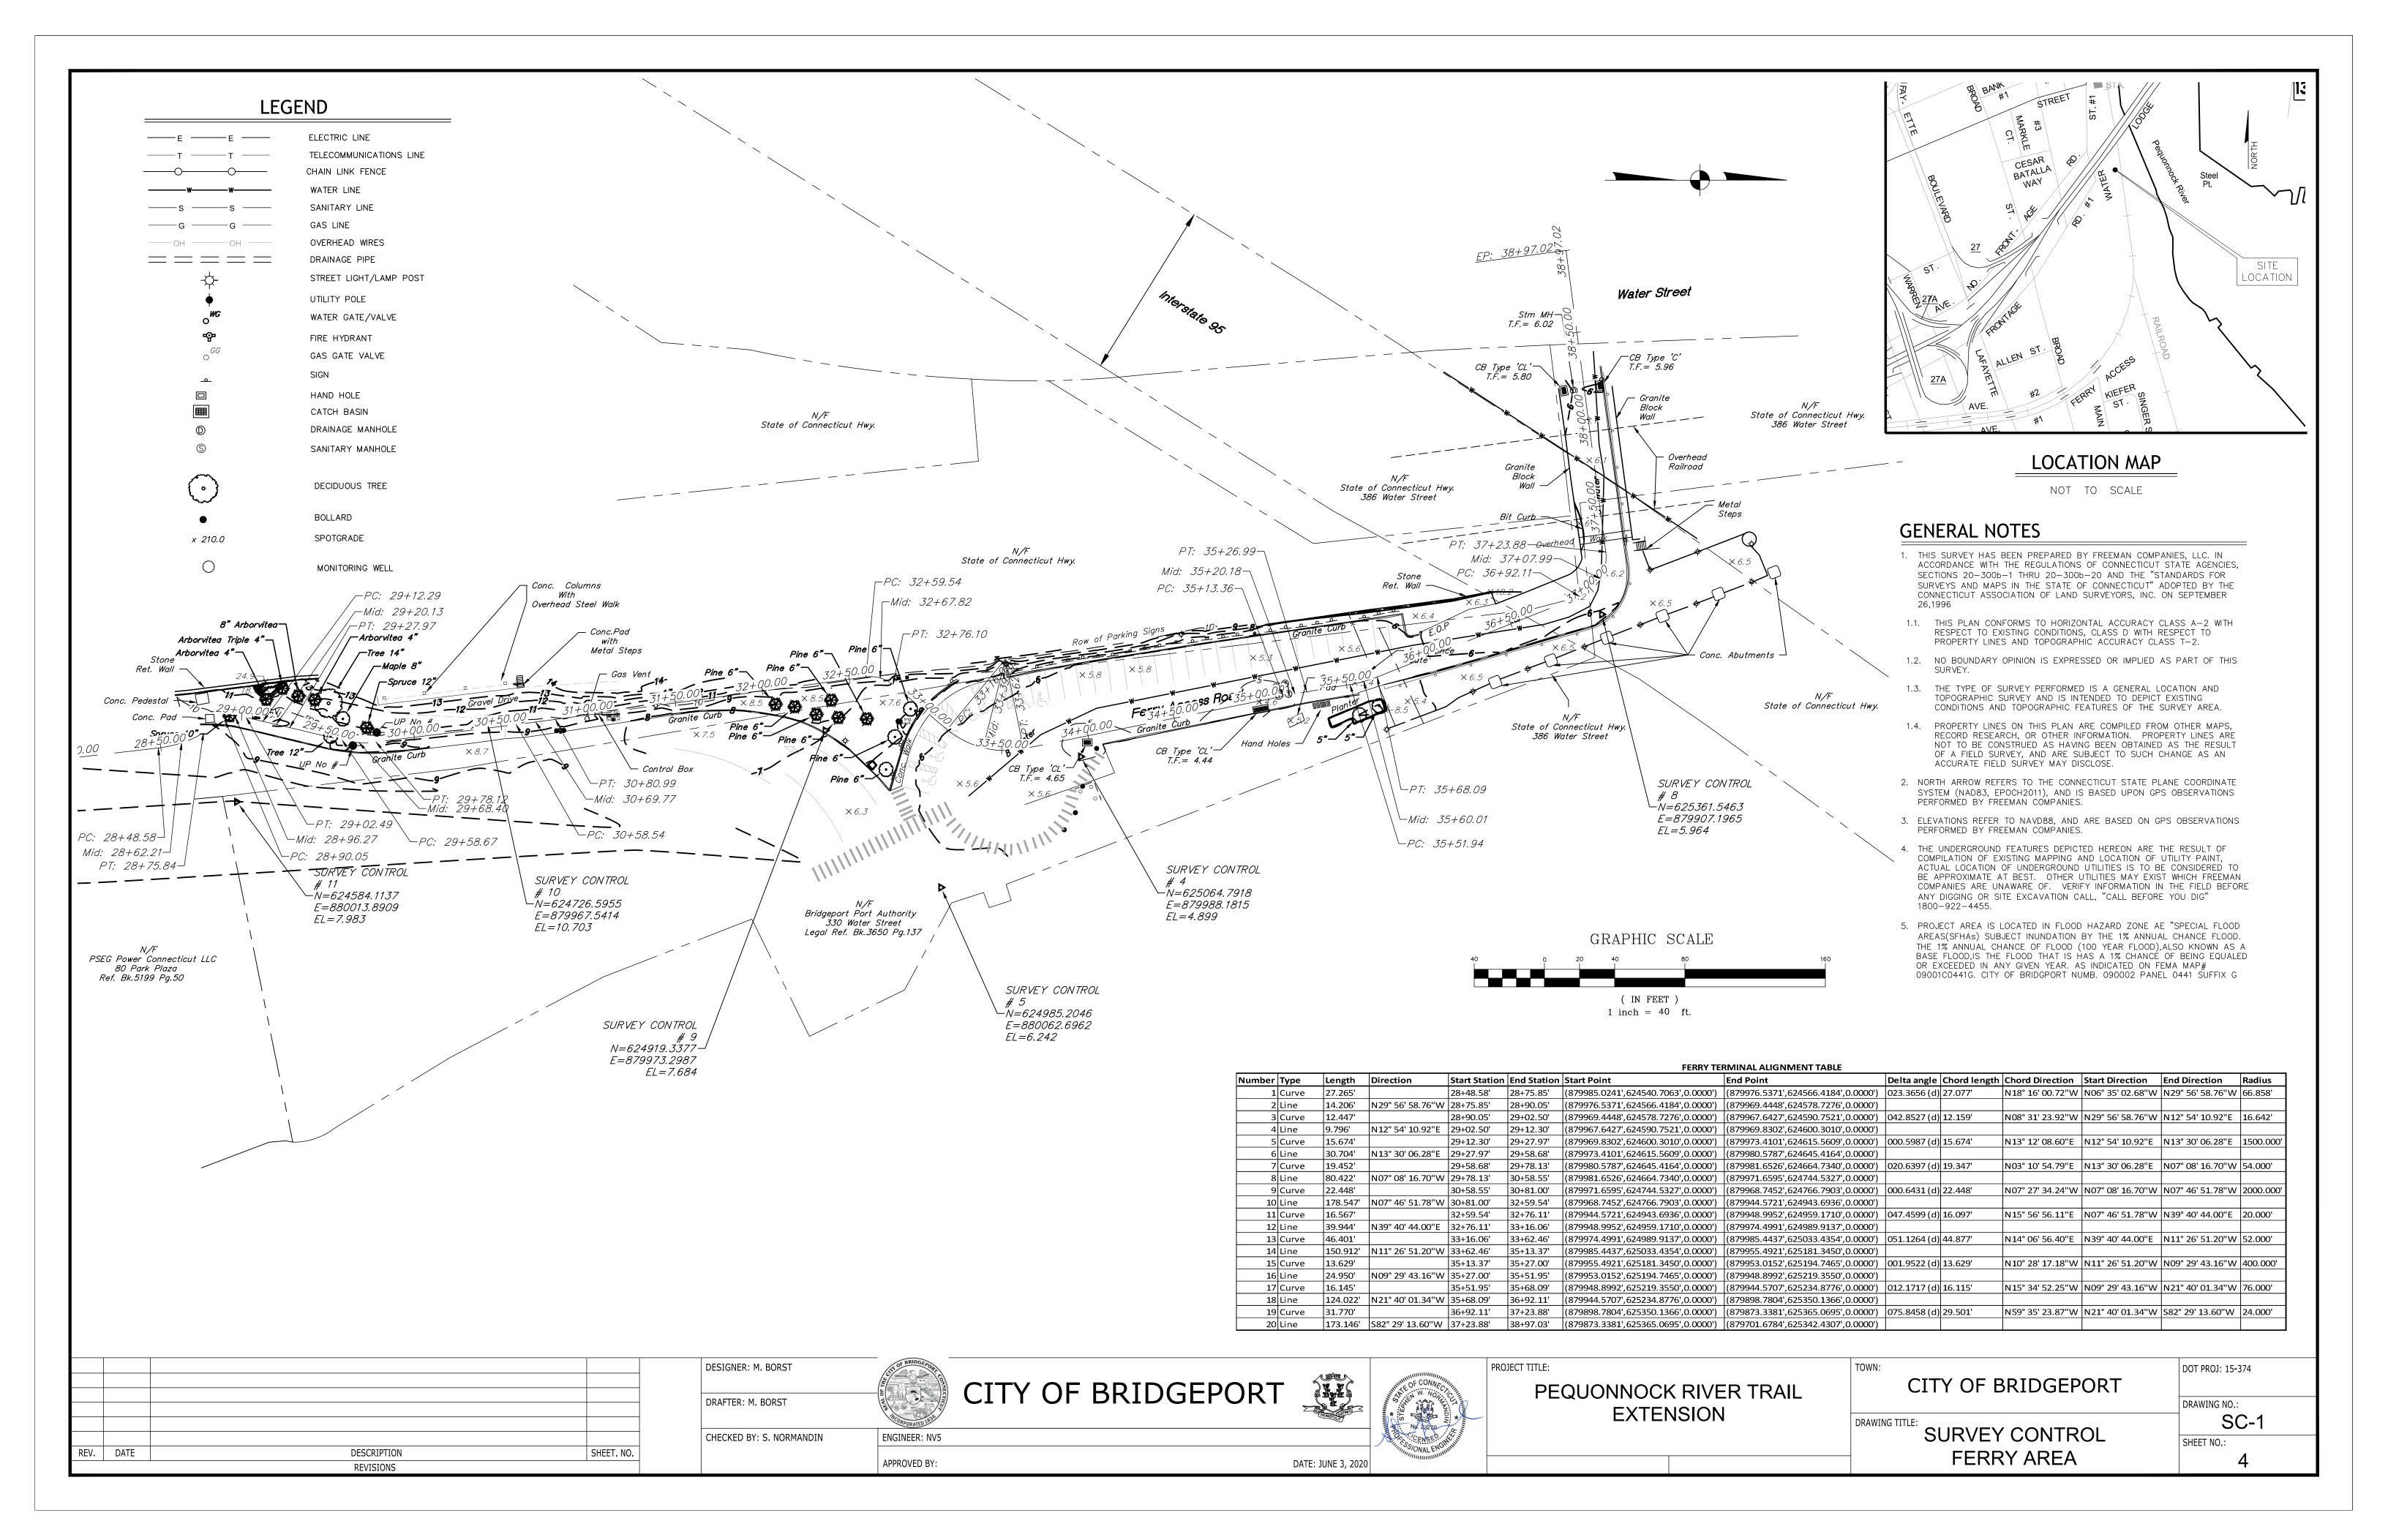

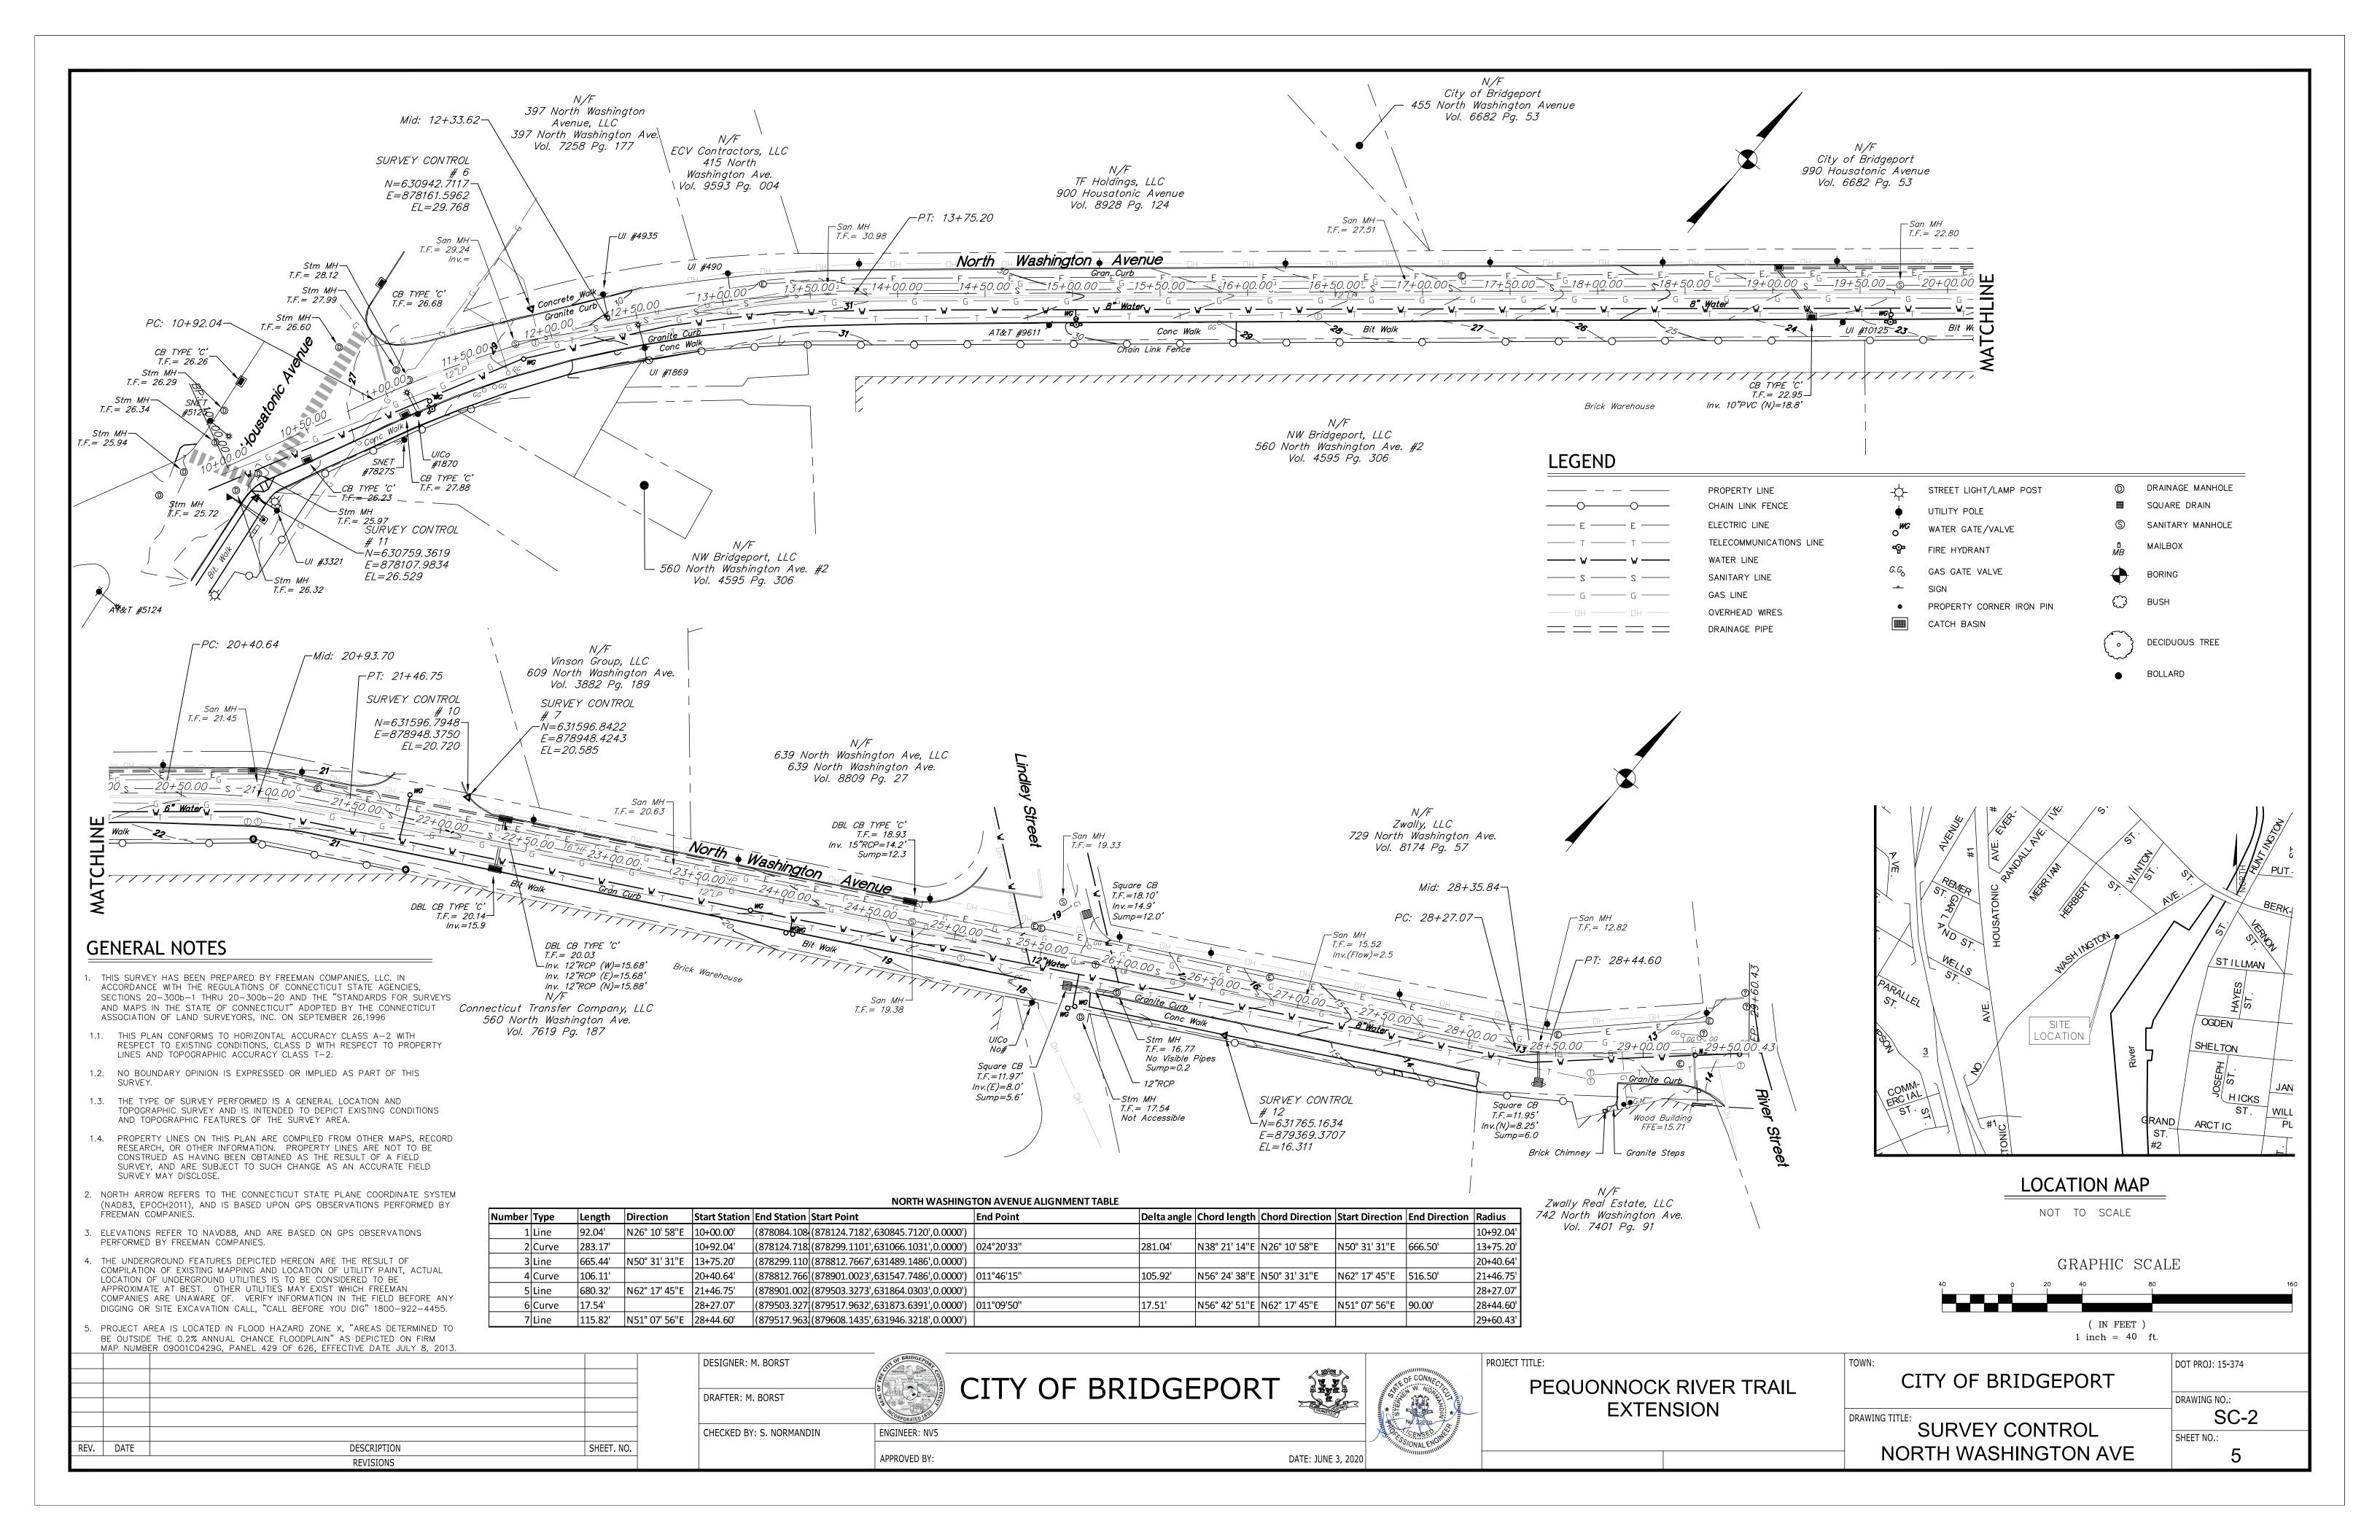

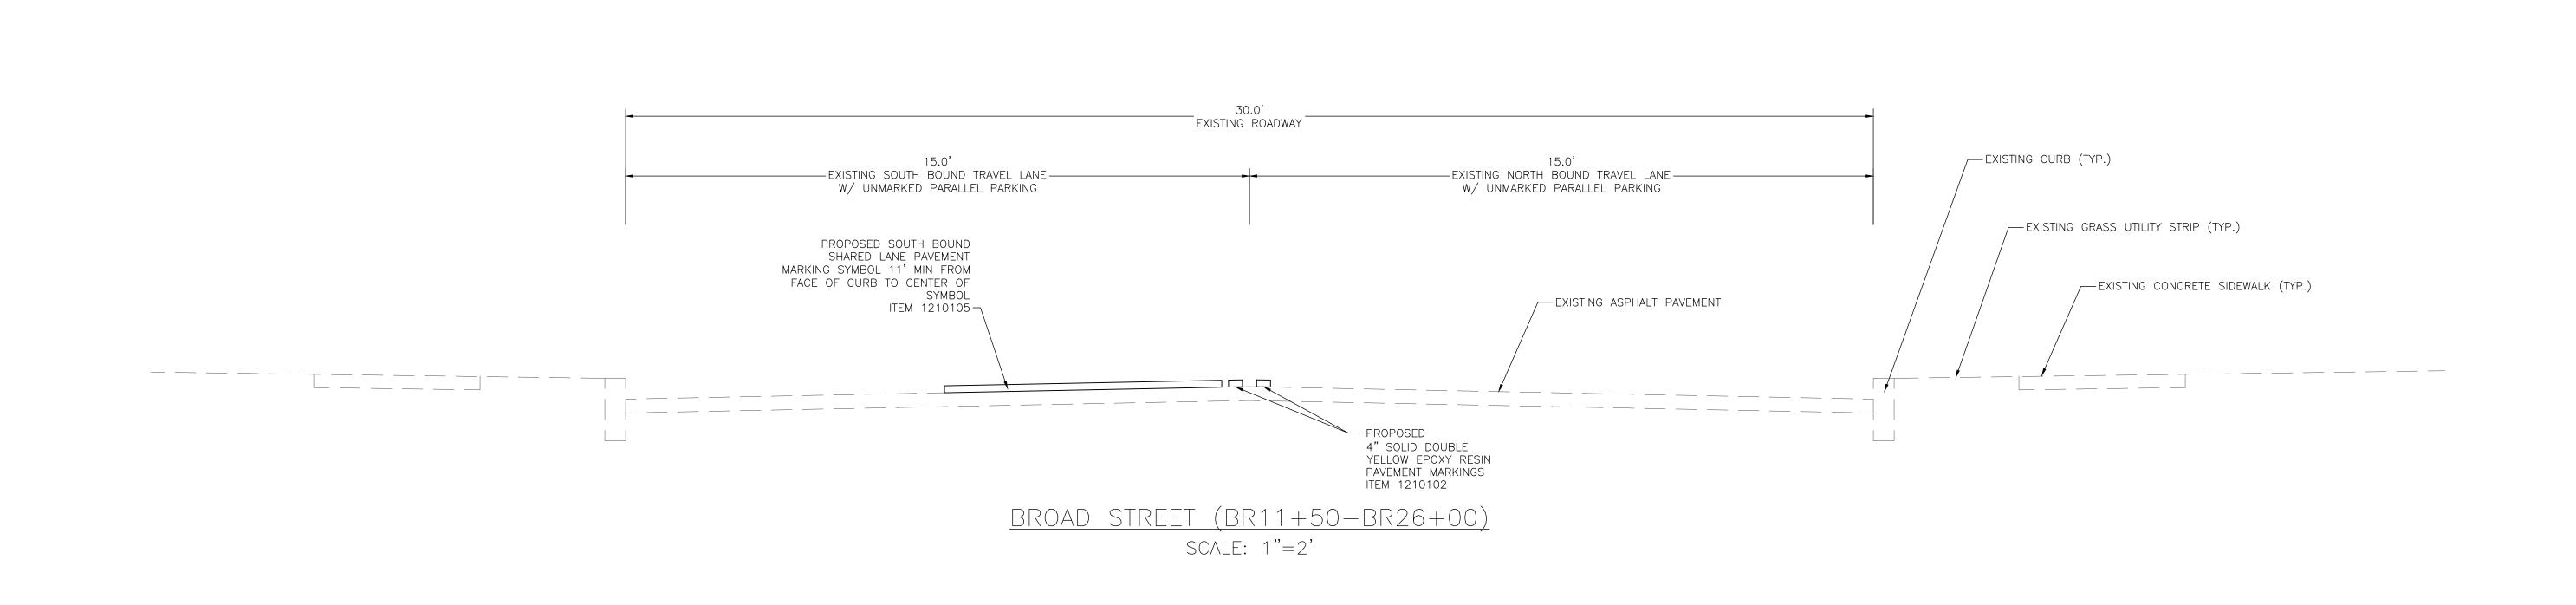

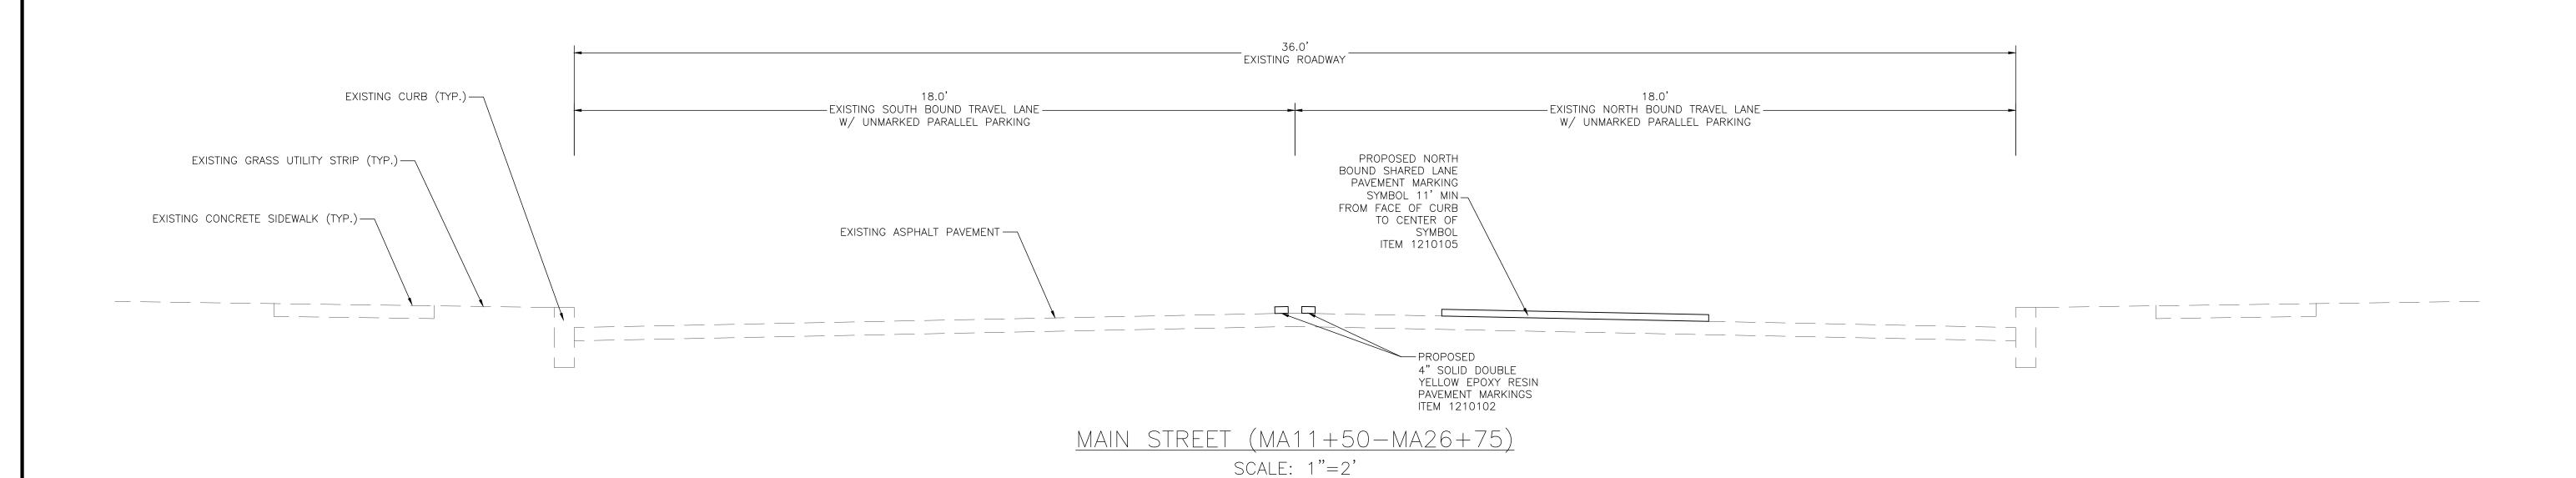

- 1. ALL EXISTING ASPHALT ROADWAY MATERIAL SHOULD BE EXCAVATED AND DISPOSED OF IN ACCORDANCE WITH PROJECT SPECIFICATIONS.
- 2. FORMATION OF COMPACTED SUBGRADE SHALL BE IN ACCORDANCE WITH SECTION 2.09 OF FORM 817. NO SEPARATE PAYMENT SHALL BE MADE FOR THIS WORK. THE COST FOR THIS WORK SHALL BE INCLUDED IN VARIOUS CONTRACT ITEMS.

				1
REV.	DATE	DESCRIPTION	SHEET. NO.]
		REVISIONS		

DESIGNER: M. BORST DRAFTER: M. BORST	TO BRIDGE FOR TO THE CONTROL OF THE	CITY OF BRIDGEPO
CHECKED BY: S. NORMANDIN	ENGINEER: NV5	

APPROVED BY:




PEQUONNOCK RIVER TRAIL EXTENSION


TOWN:	DOT PROJ: 15-374
CITY OF BRIDGEPORT	
	DRAWING NO.:
DRAWING TITLE:	TS-1
TYPICAL SECTIONS - 1	SHEET NO.:

SCALE: 1"=2'


6

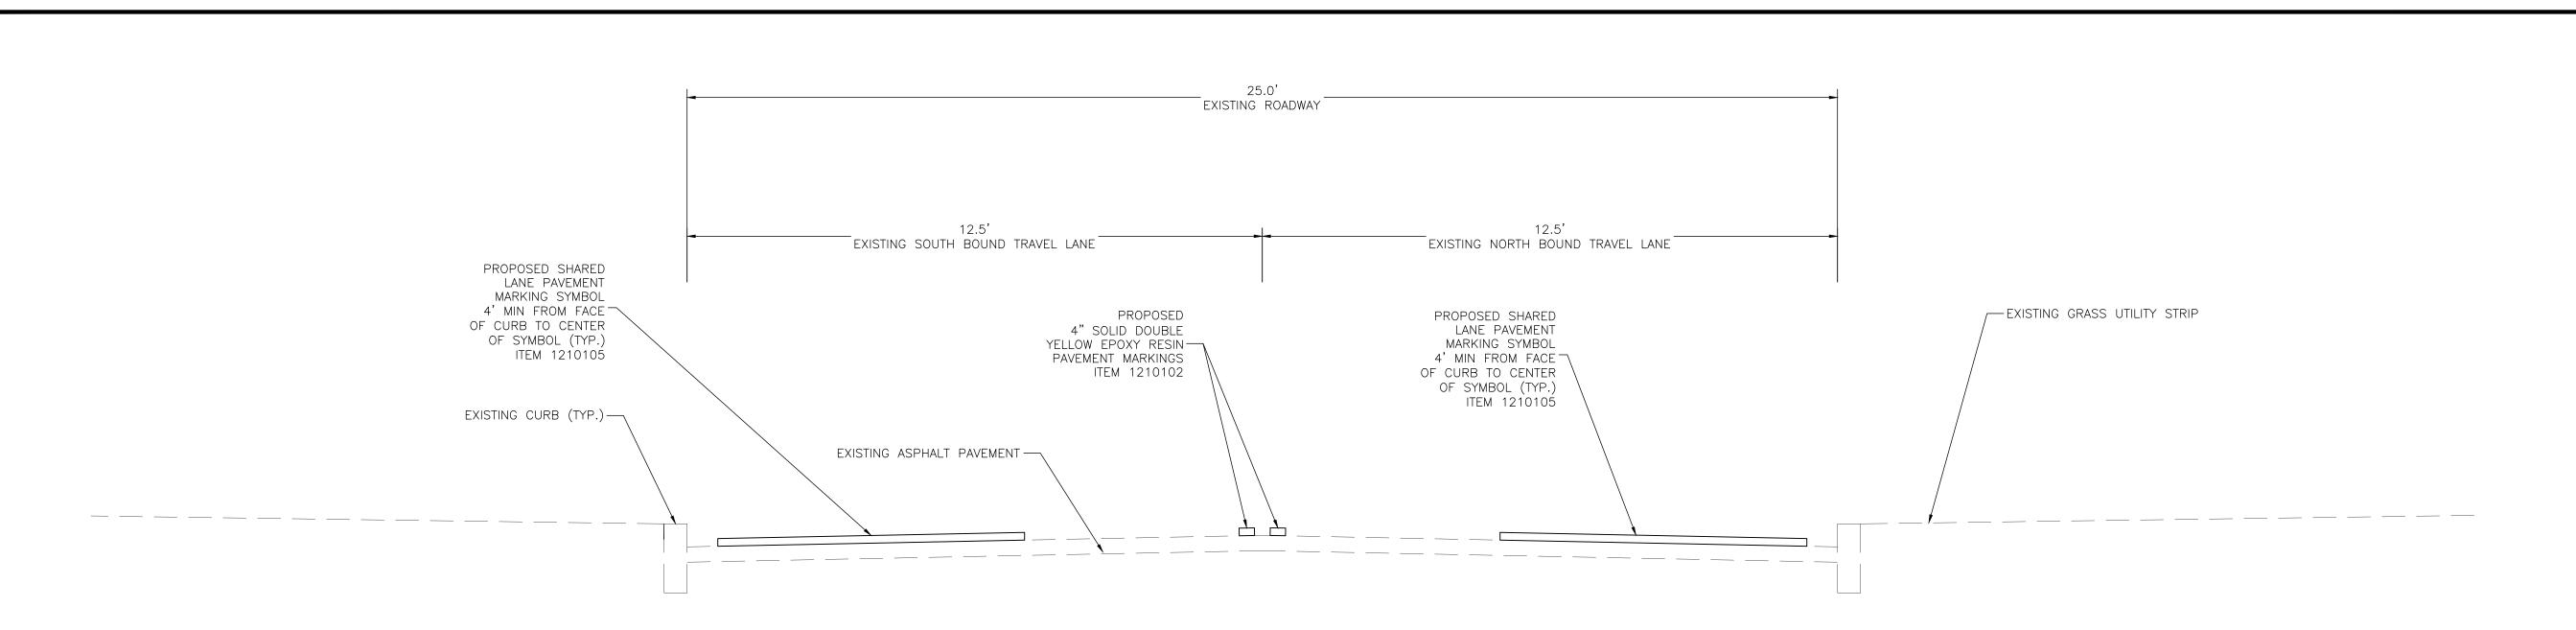

RAILROAD AVENUE/FERRY ACCESS ROAD (FE14+50-FE28+50) SCALE: 1"=2'

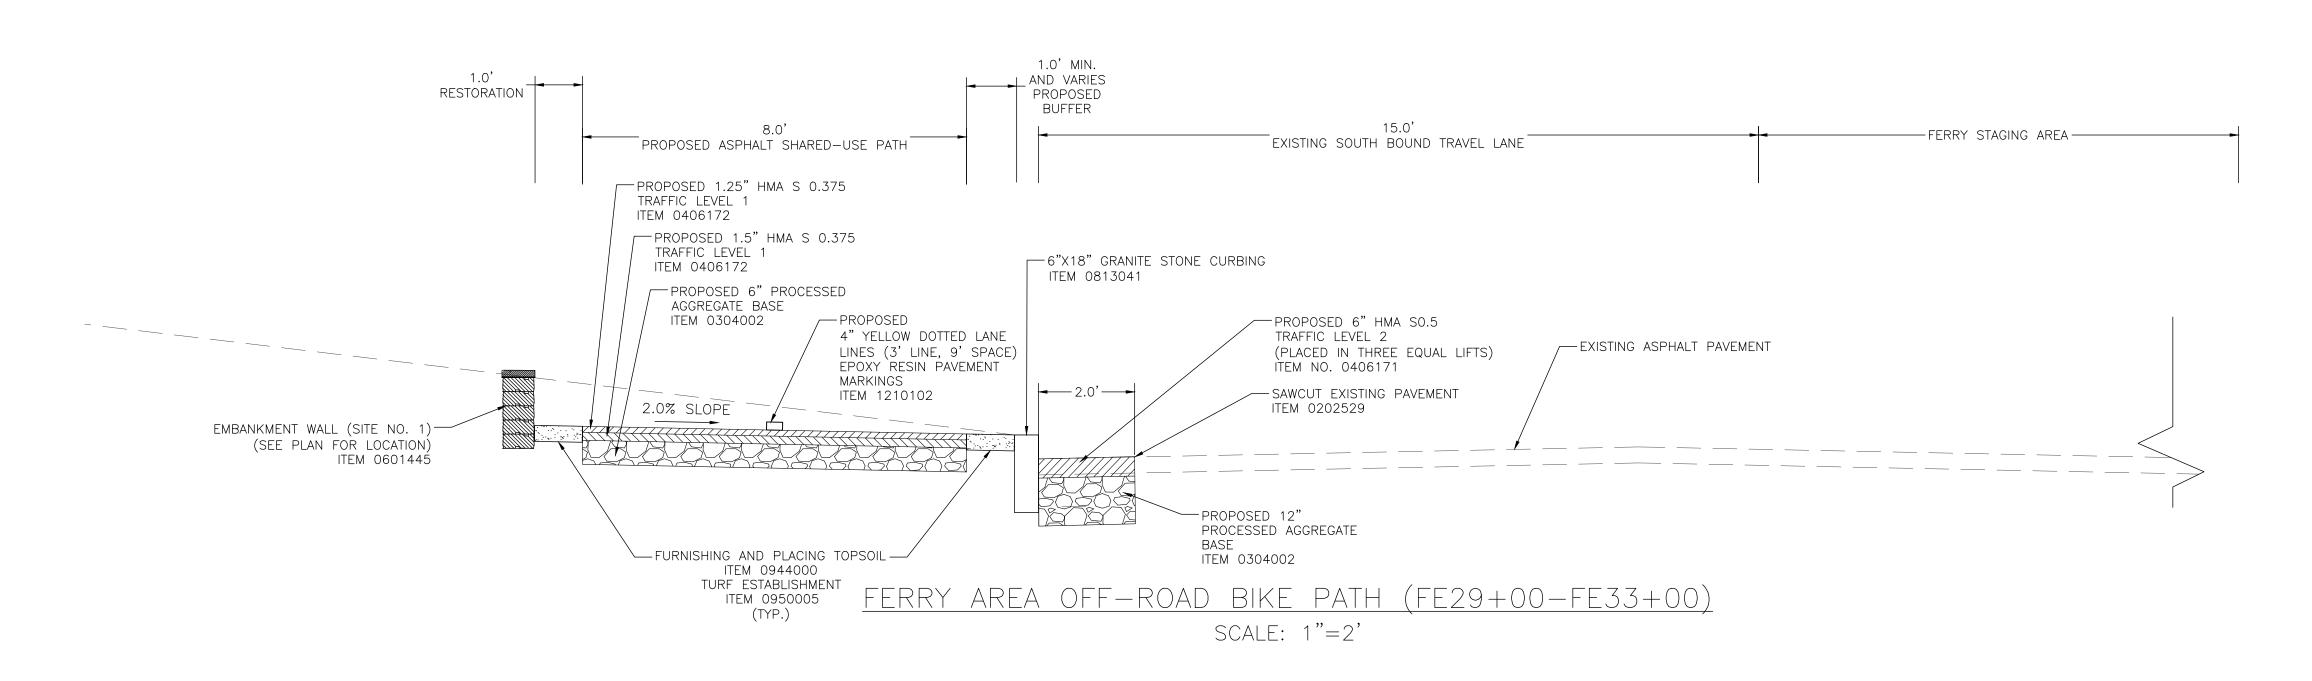

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REV. DATE DESCRIPTION SHEET. NO. REVISIONS

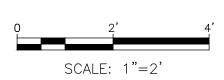DESIGNER: M. BORST DRAFTER: M. BORST CHECKED BY: S. NORMANDIN **ENGINEER: NV5**

APPROVED BY:

CITY OF BRIDGEPORT




PEQUONNOCK RIVER TRAIL **EXTENSION**


CITY OF BRIDGEPORT

DRAWING TITLE: TYPICAL SECTIONS - 2

DRAWING NO.: TS-2 SHEET NO.:

DOT PROJ: 15-374

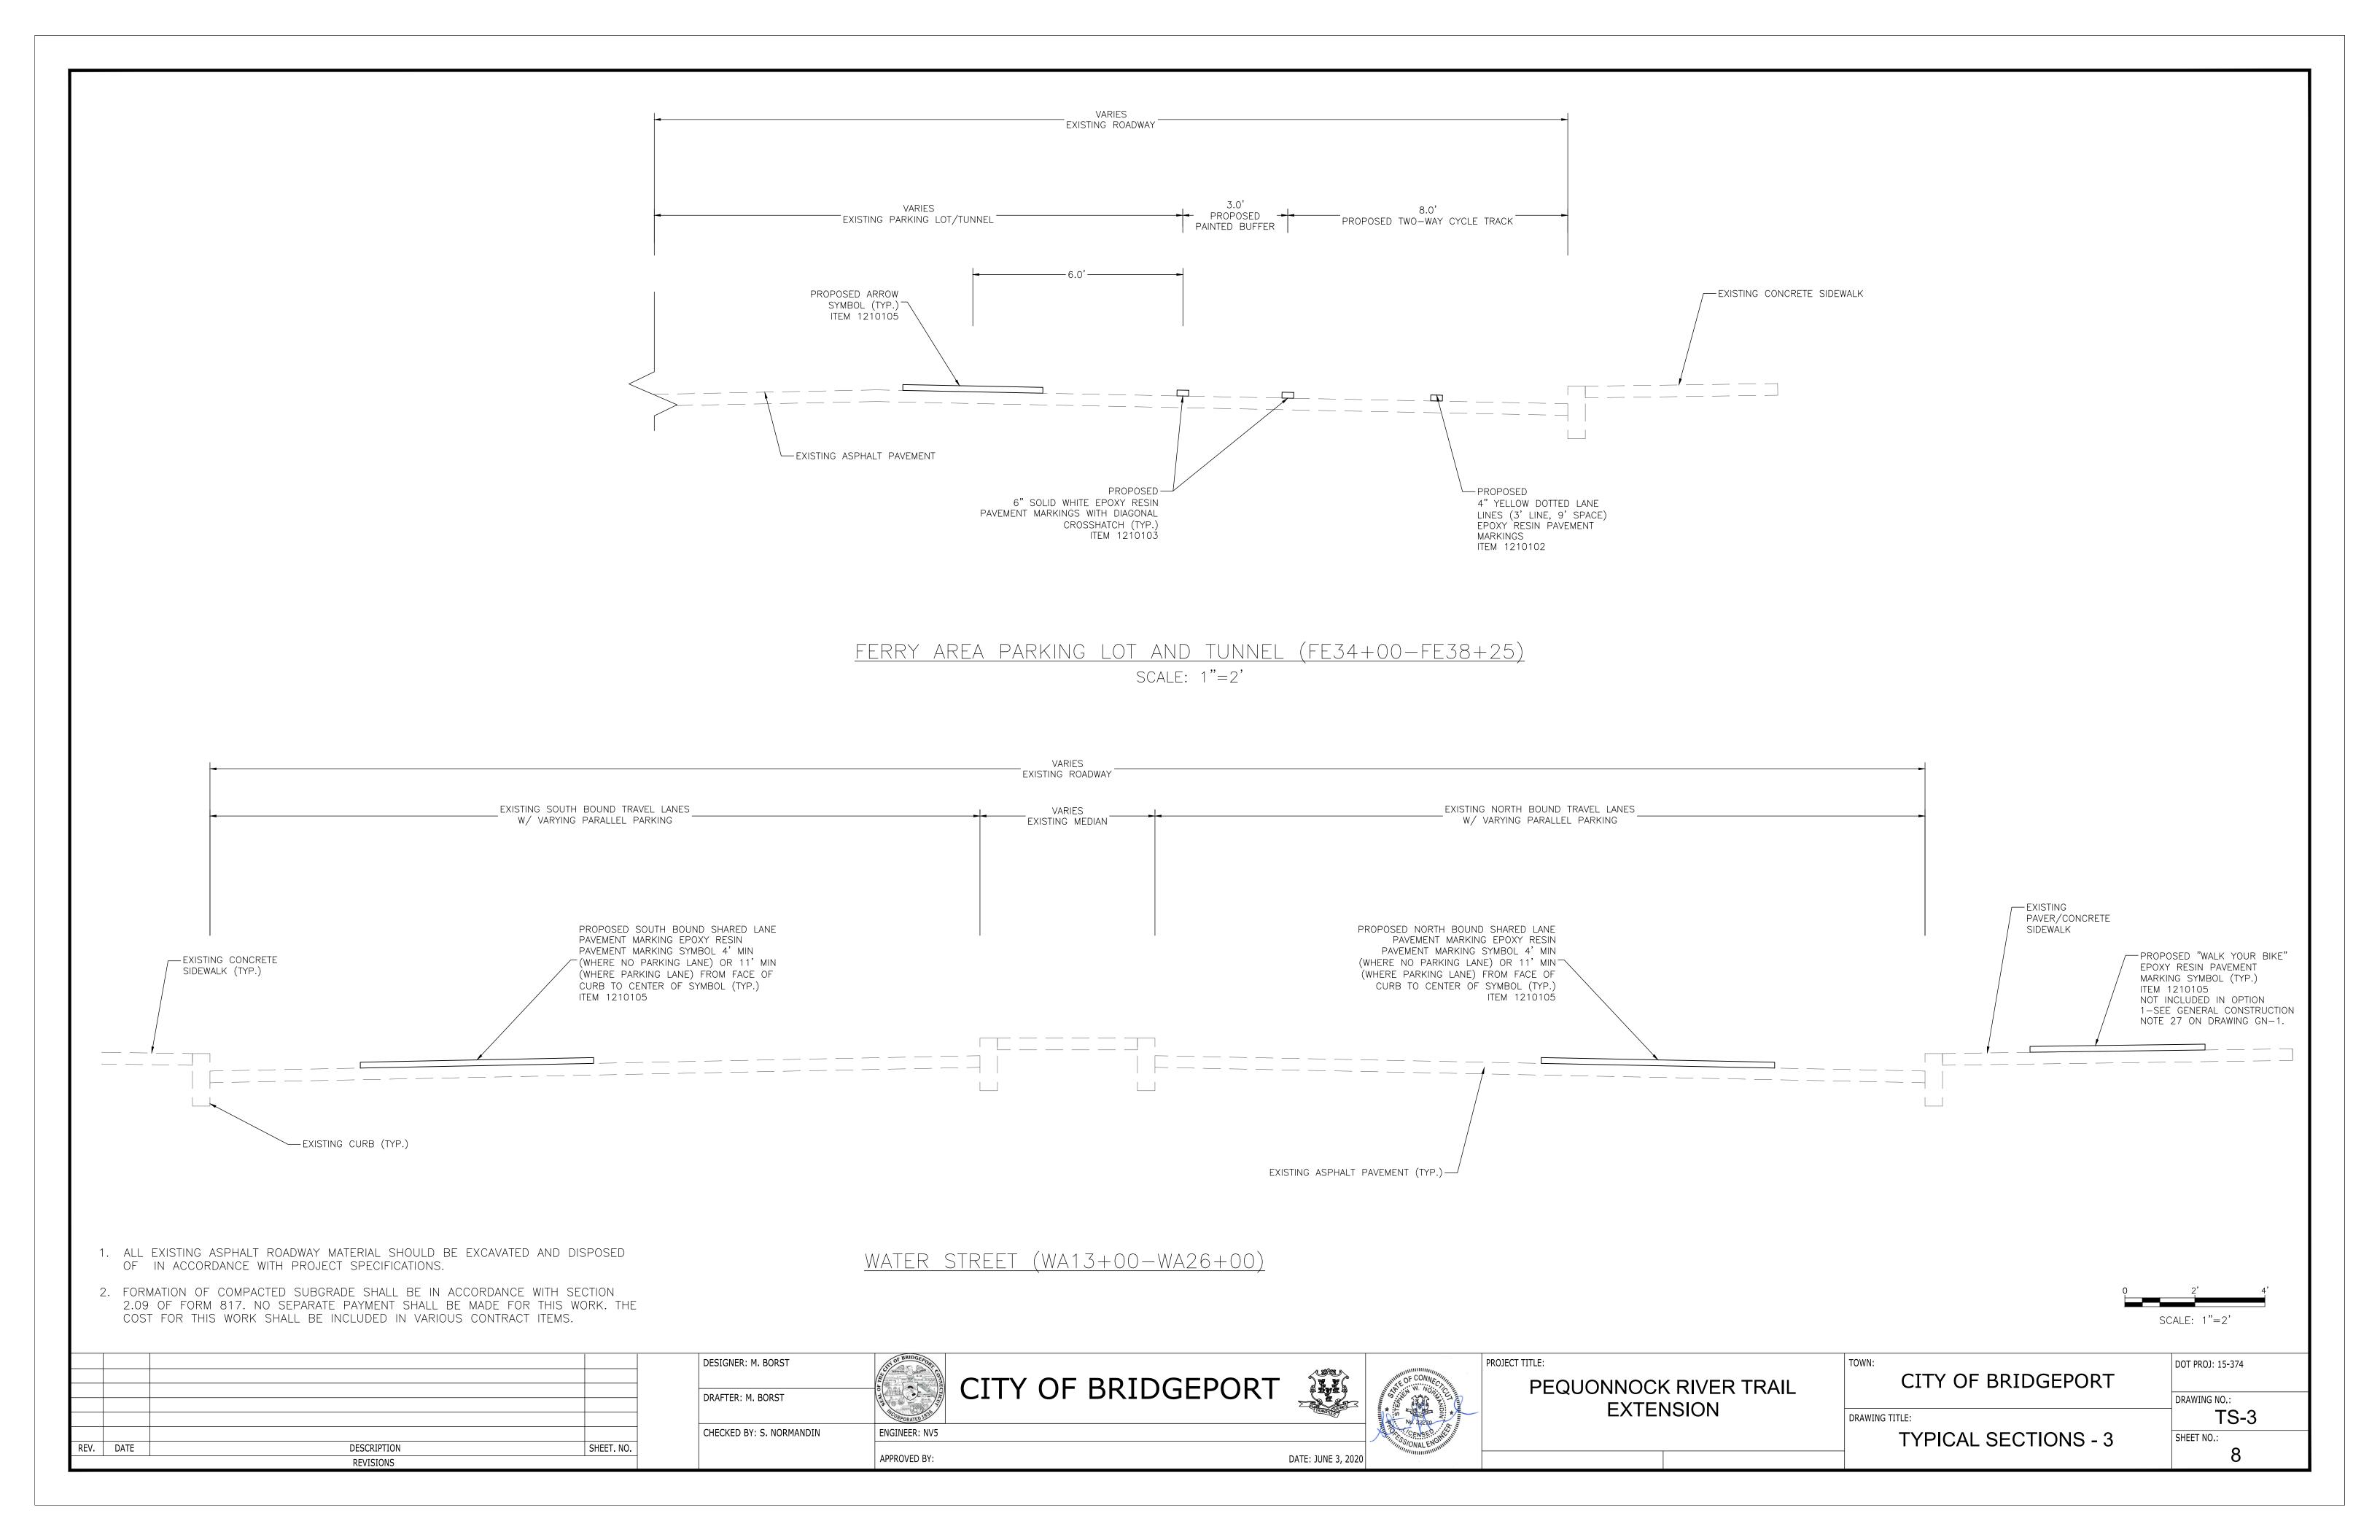

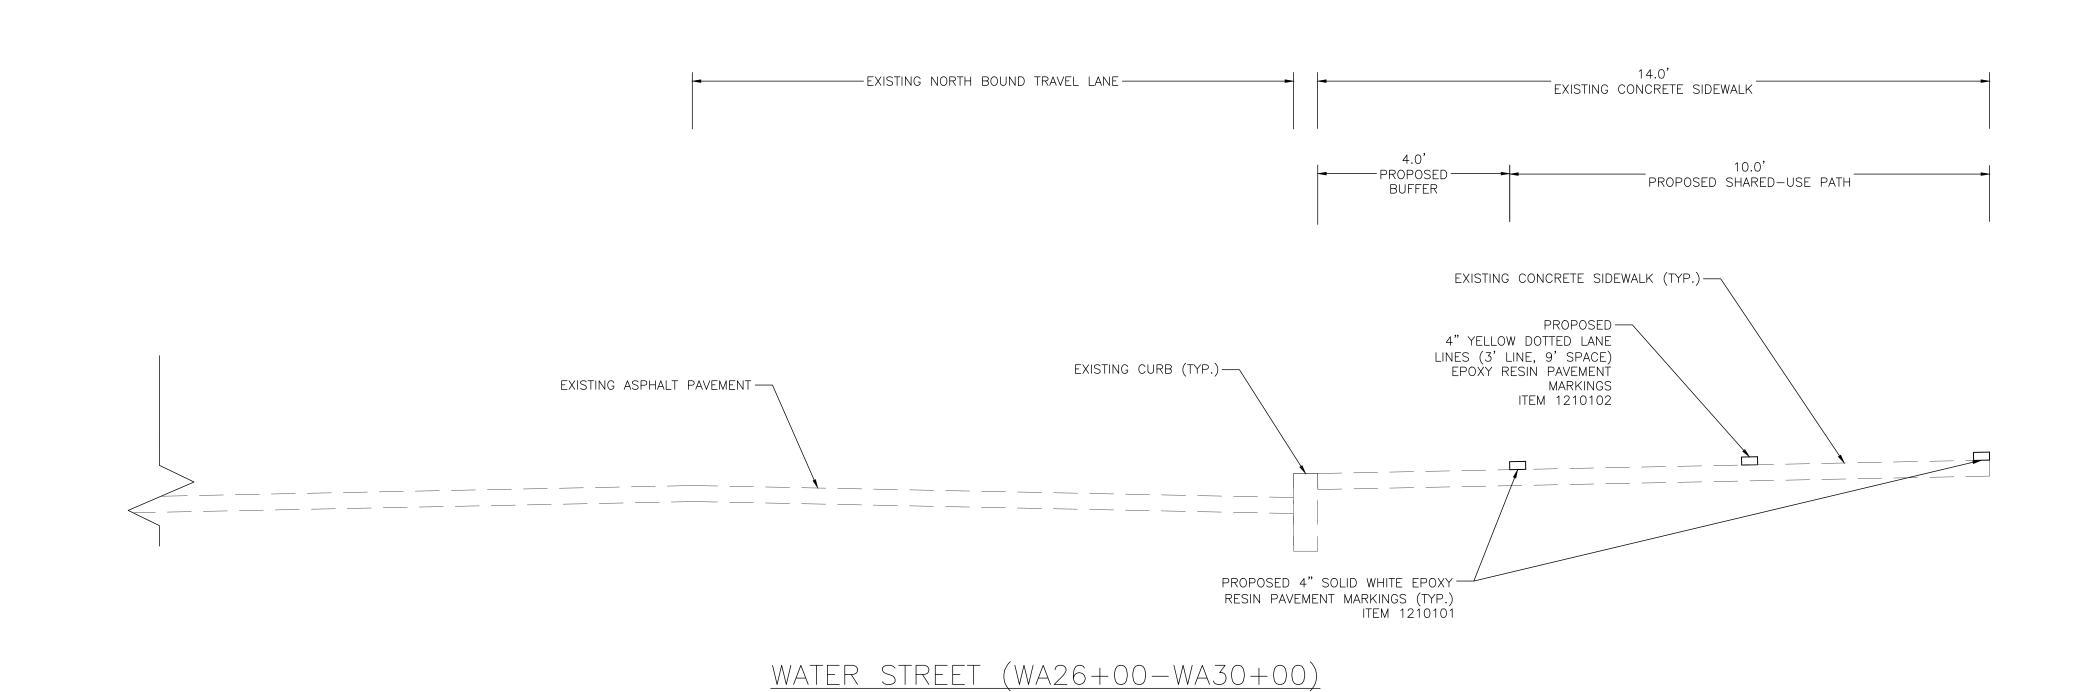

SCALE: 1"=2'


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•		REVISIONS	·

DESIGNER: M. BORST DRAFTER: M. BORST CHECKED BY: S. NORMANDIN ENGINEER: NV5

APPROVED BY:

CITY OF BRIDGEPORT

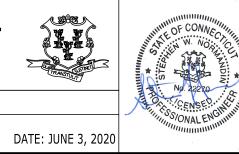



PEQUONNOCK RIVER TRAIL **EXTENSION**


TOWN:	DOT PROJ: 15-374
CITY OF BRIDGEPORT	
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DRAWING TITLE:	TS-4
TYDICAL SECTIONS A	SHEET NO ·

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TYPICAL SECTIONS - 4



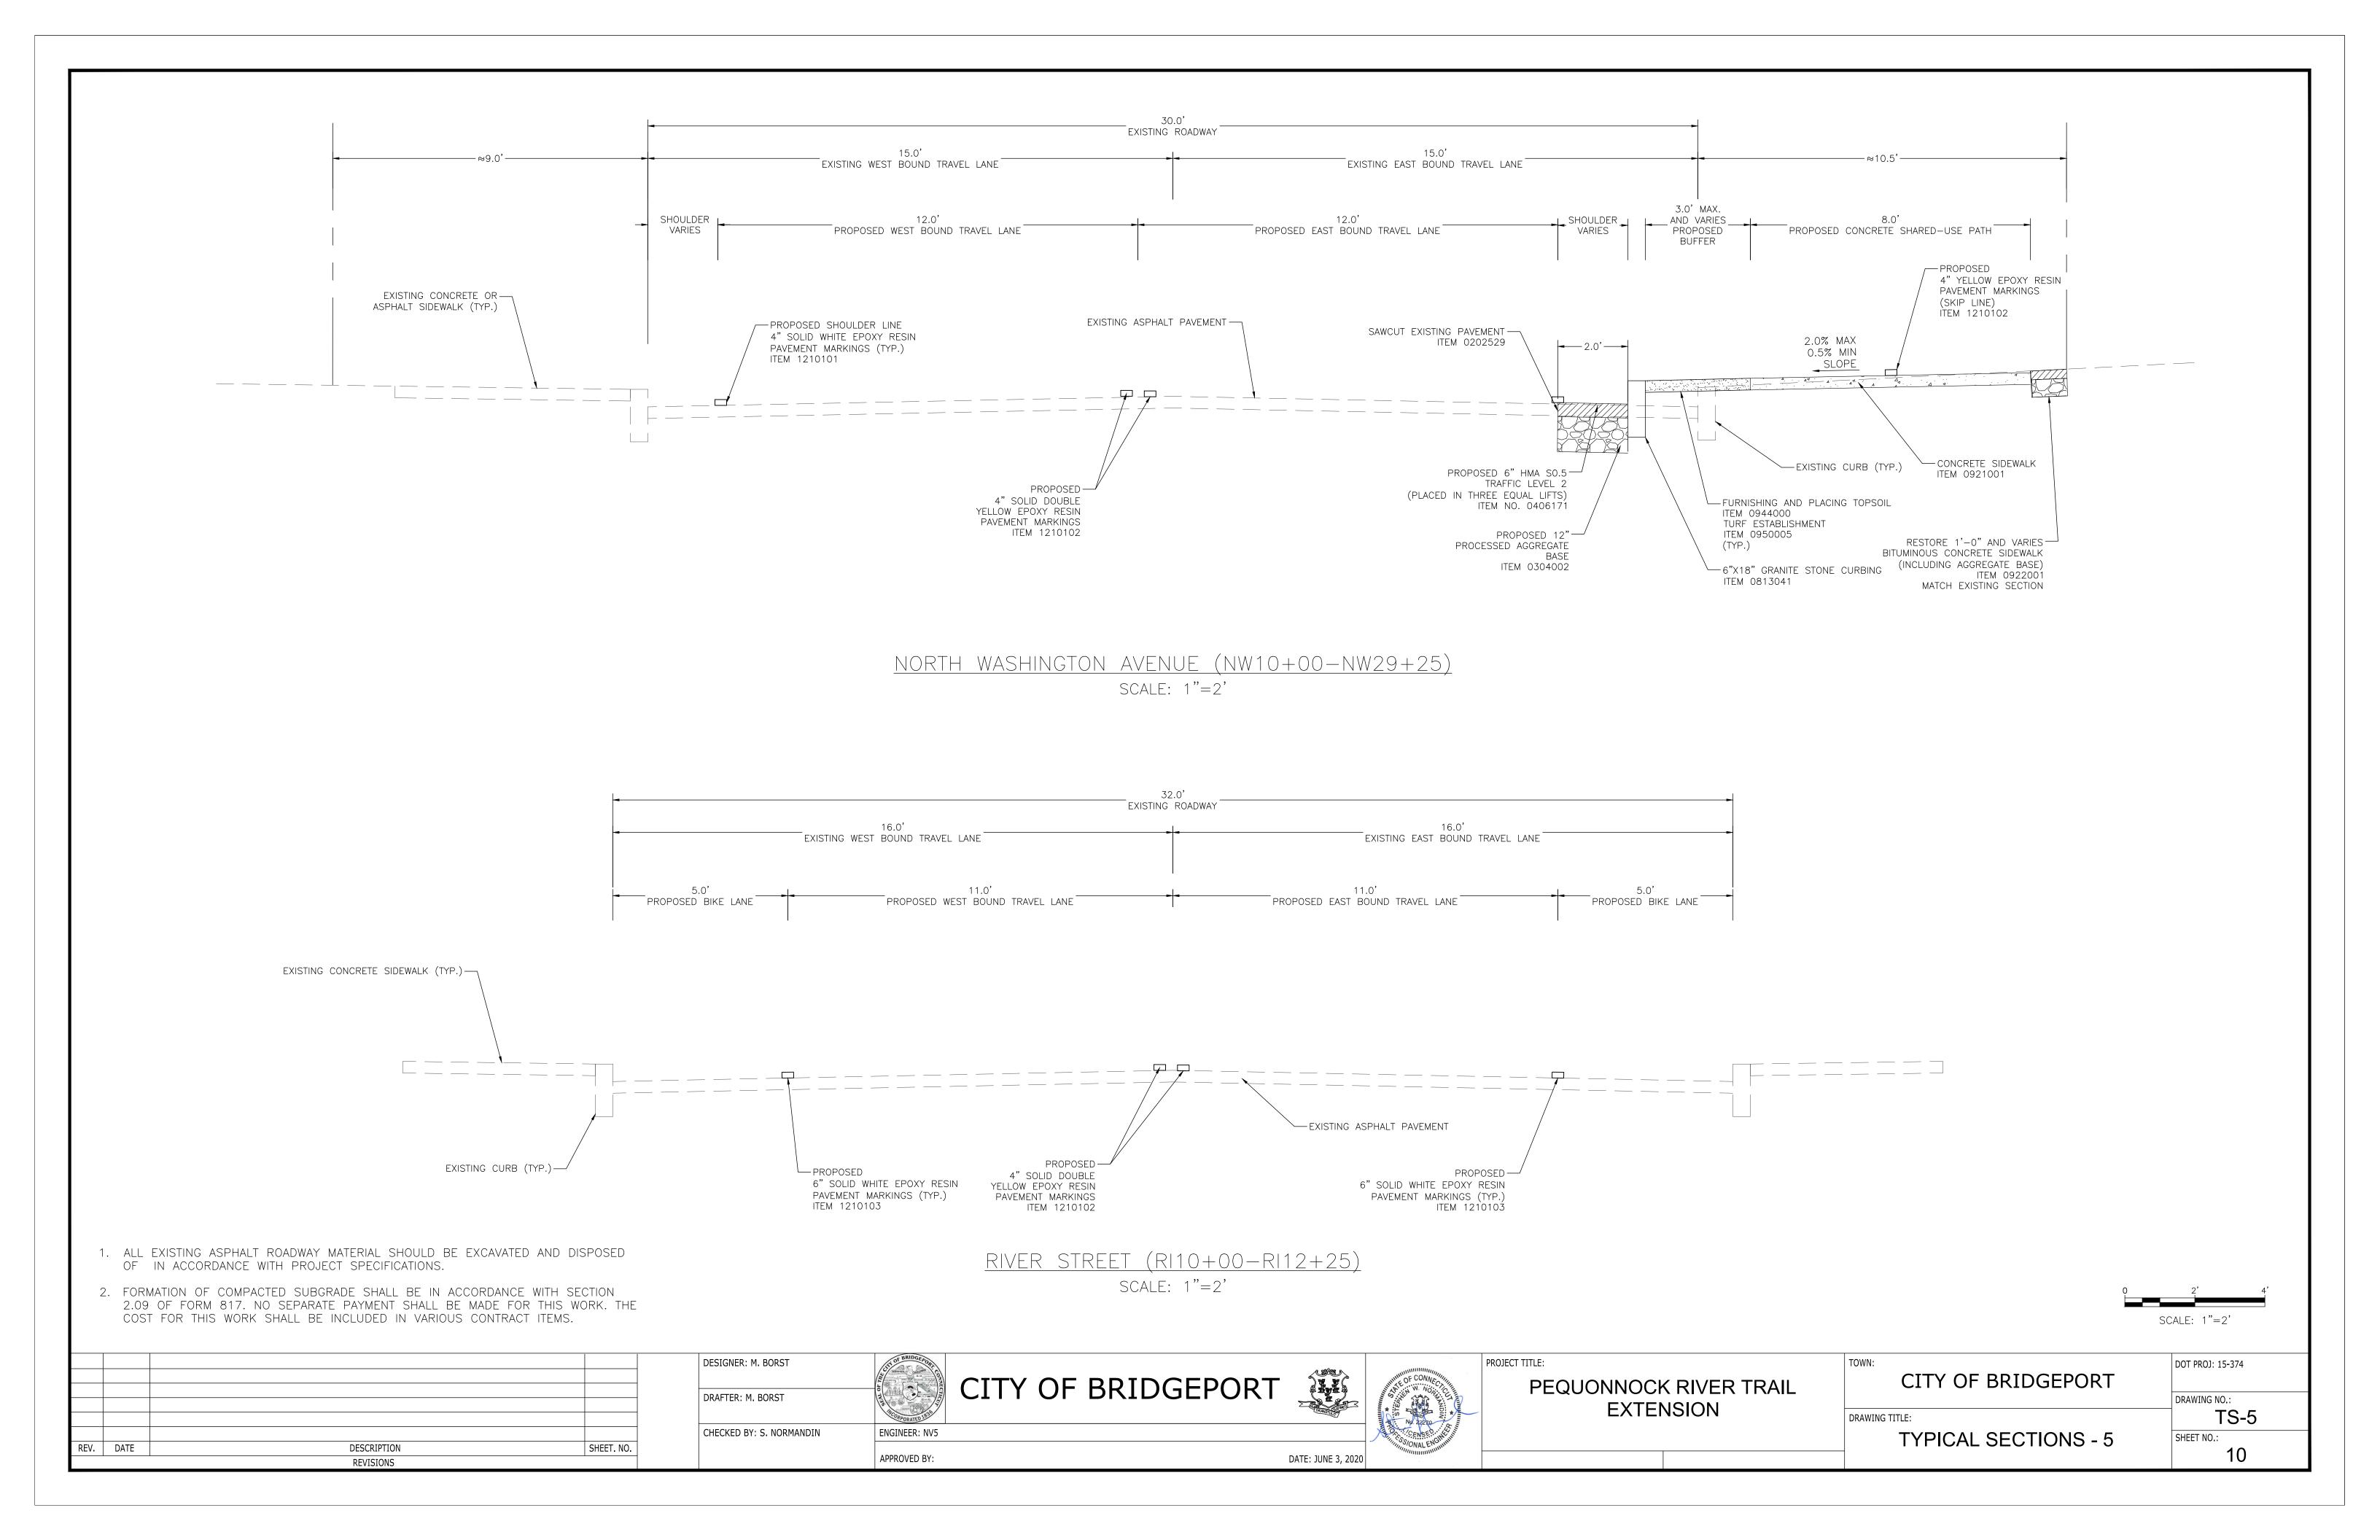


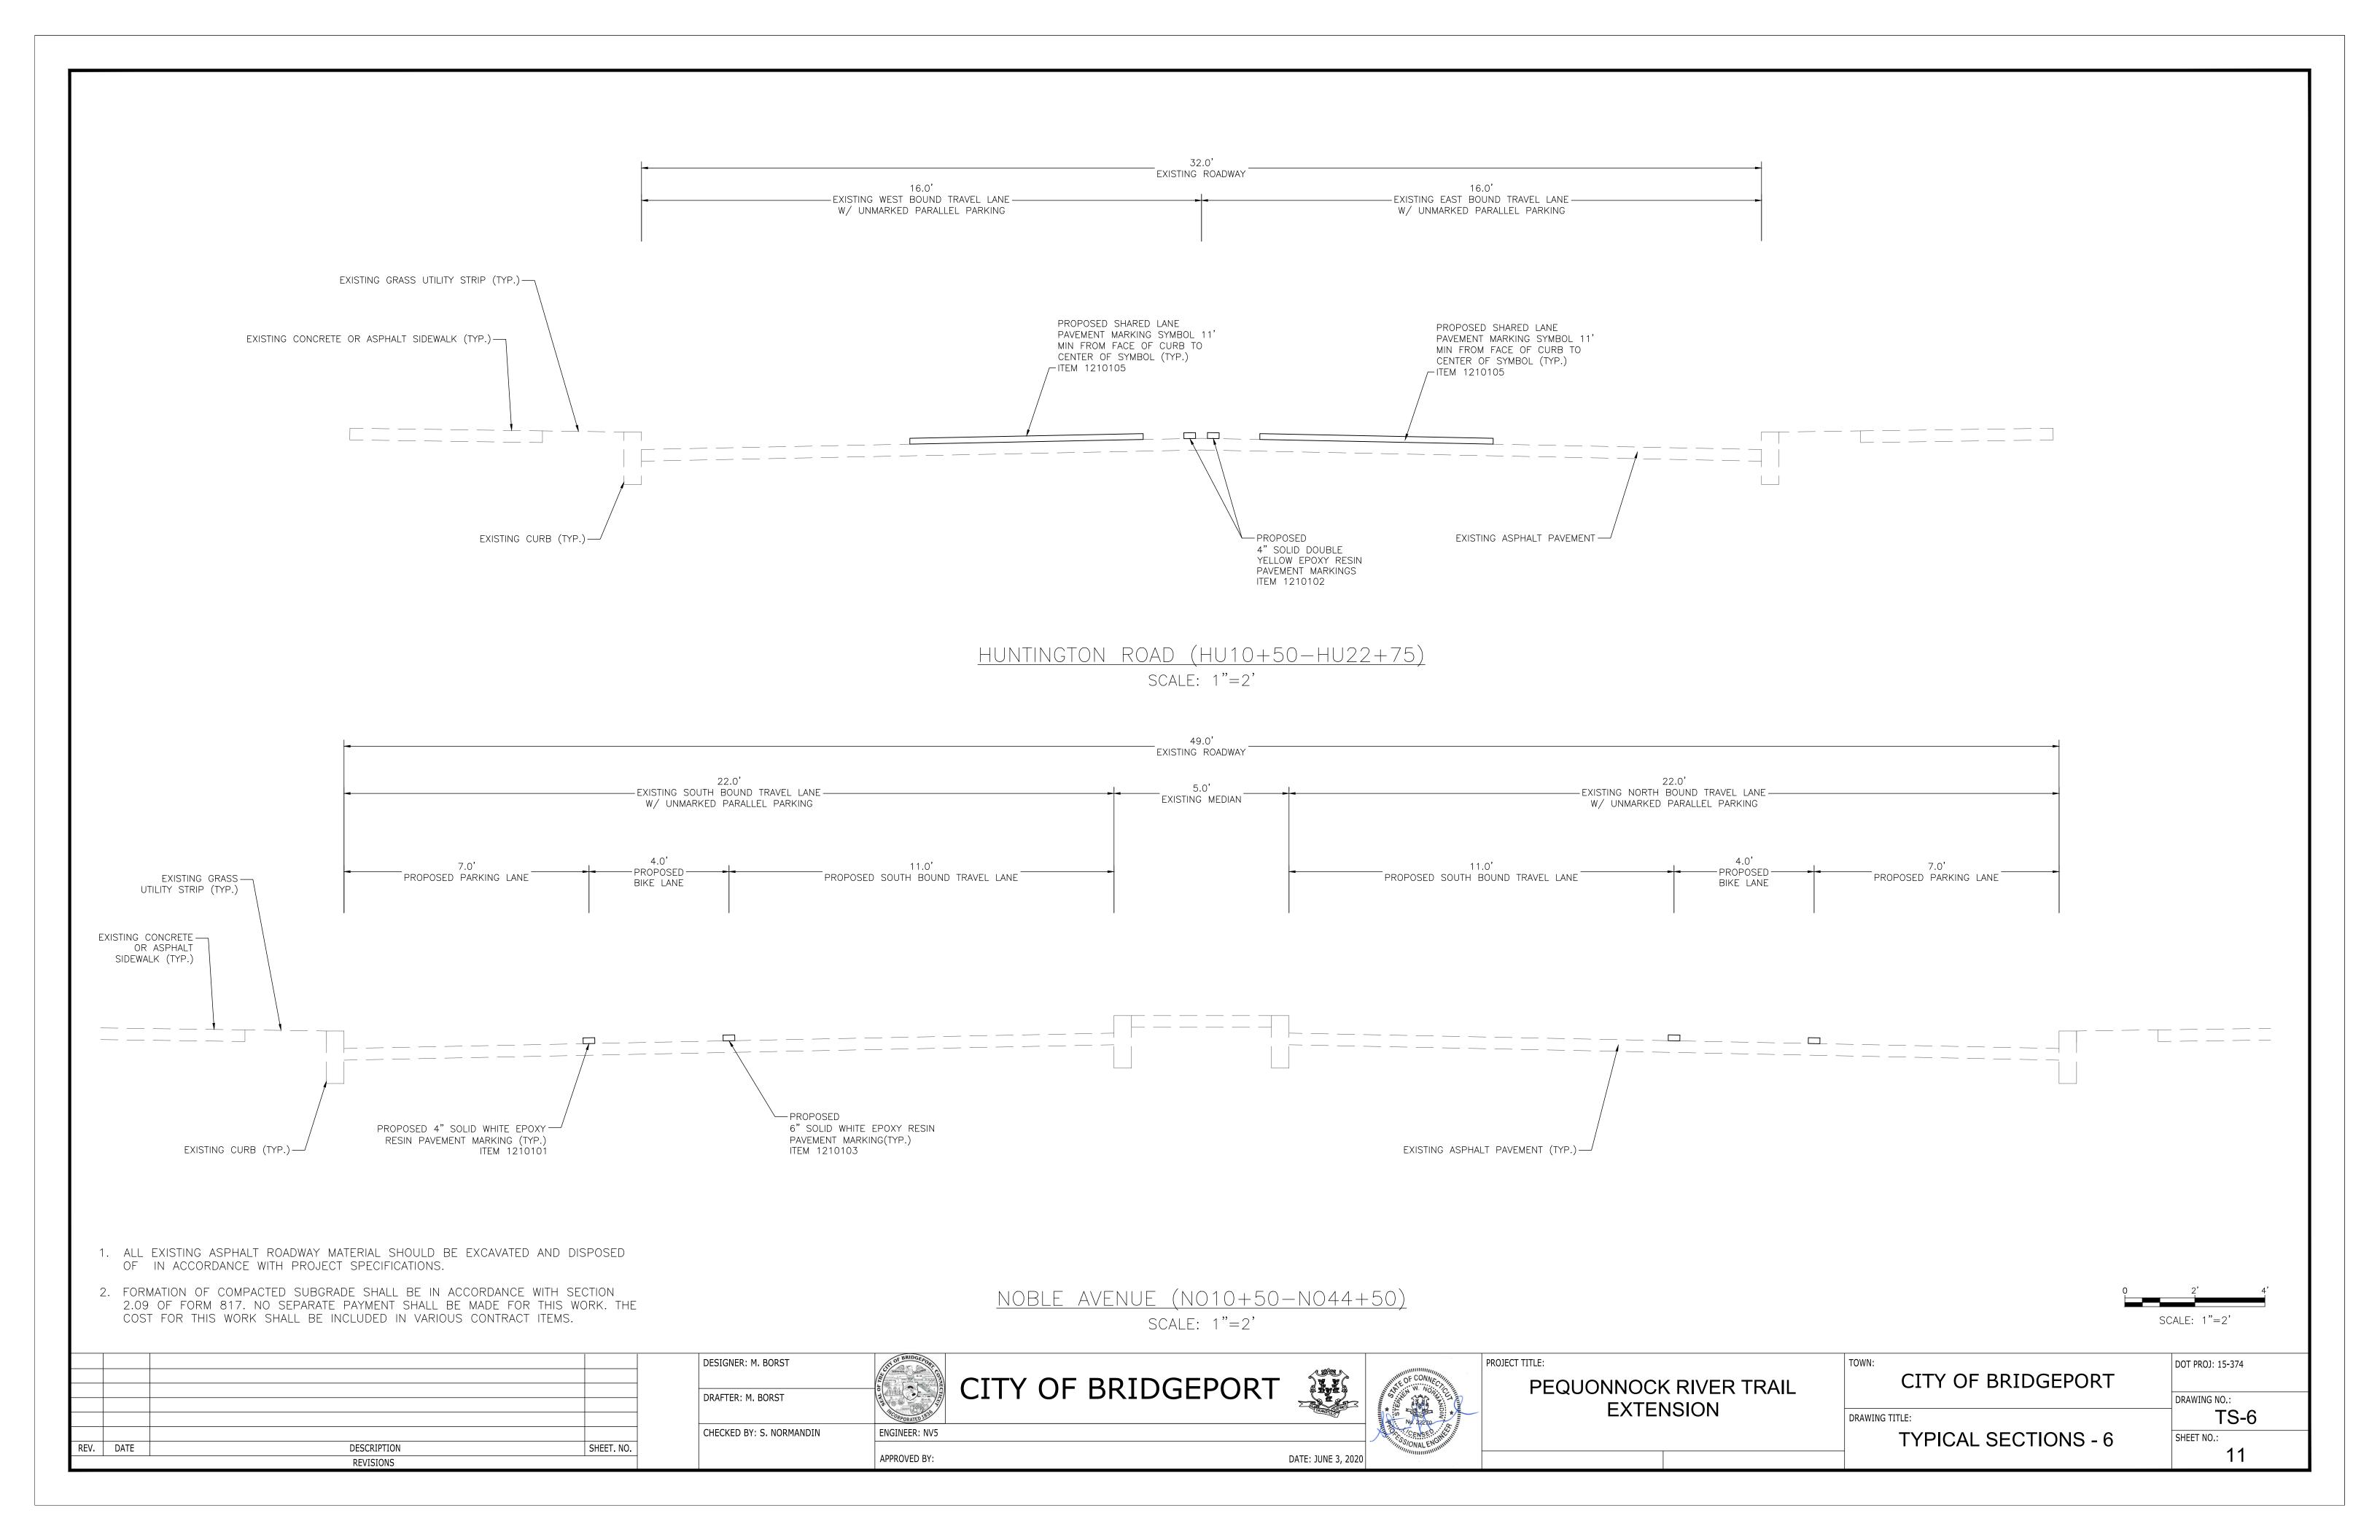
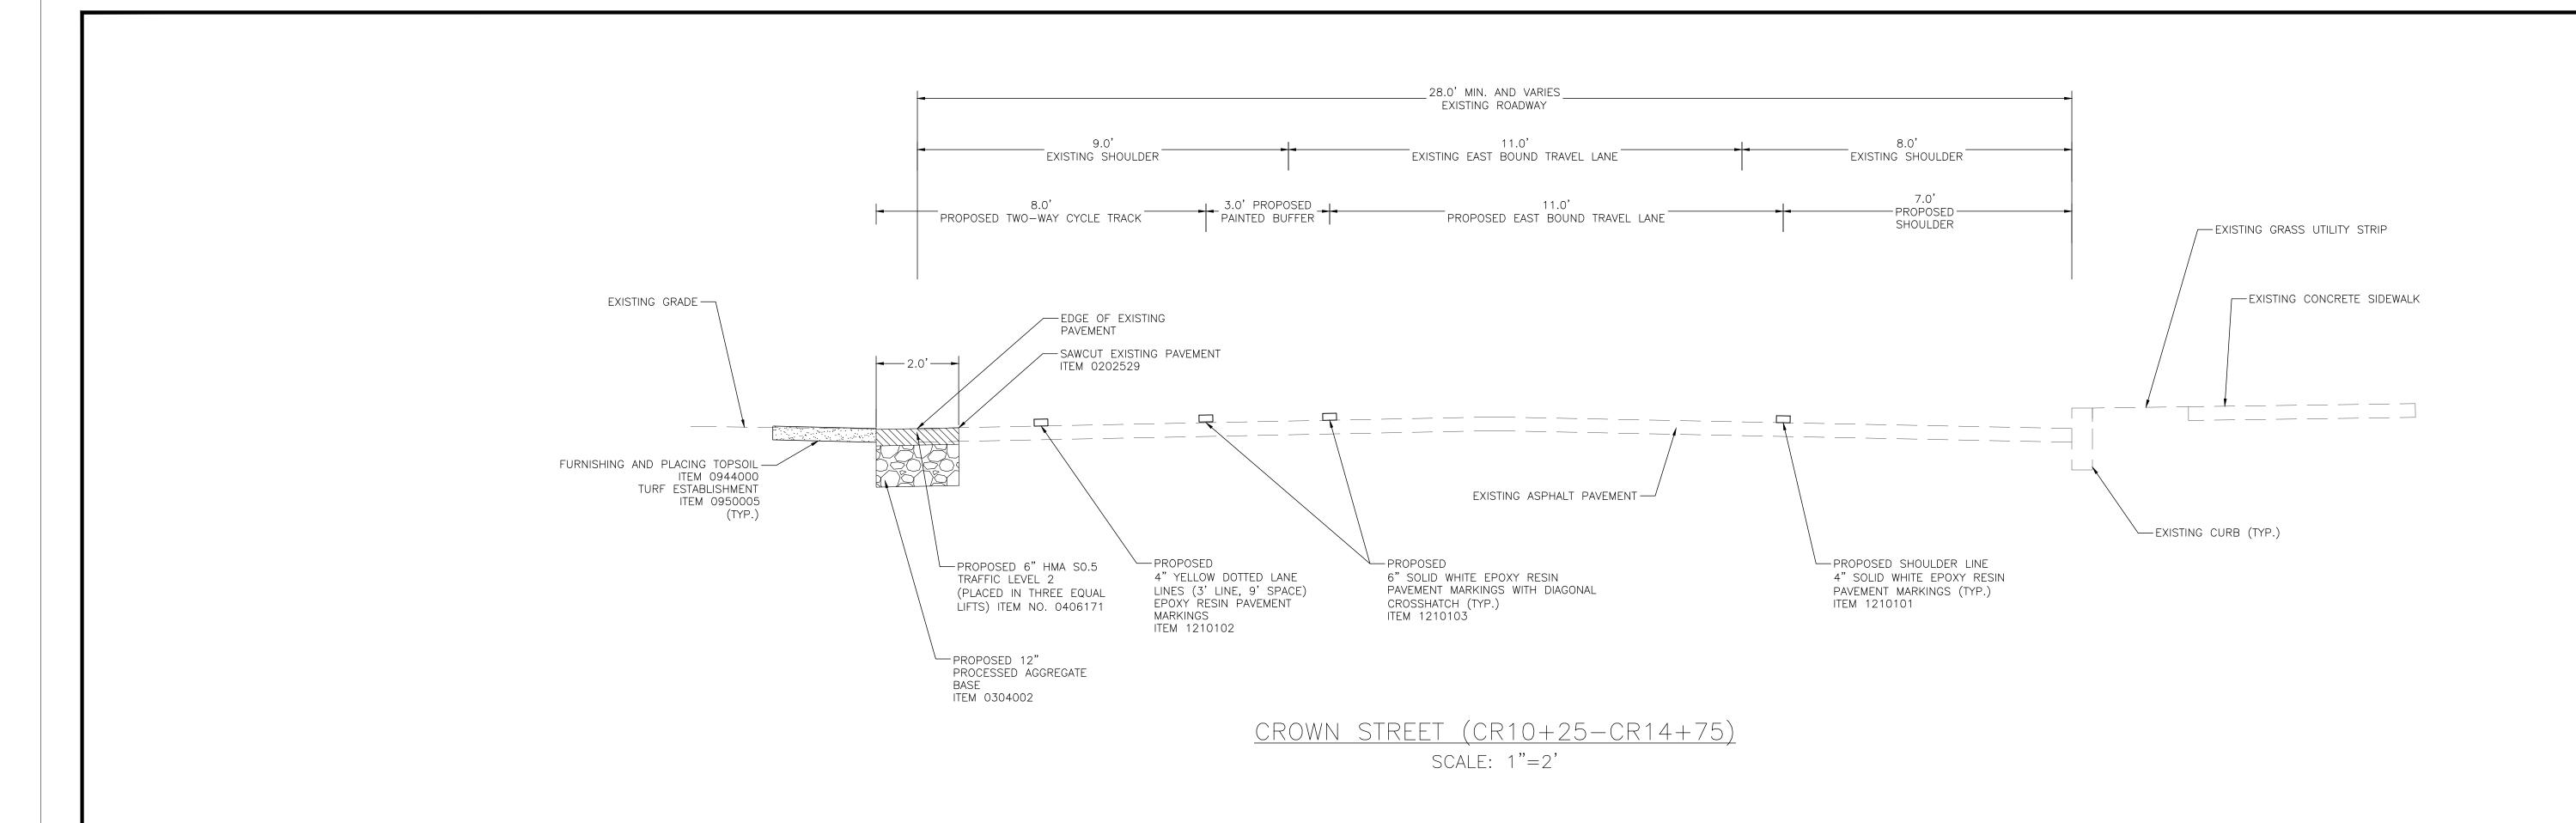
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REV.	DATE	DESCRIPTION	SHEET. NO.
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DESIGNER: M. BORST DRAFTER: M. BORST CHECKED BY: S. NORMANDIN




PEQUONNOCK RIVER TRAIL **EXTENSION**

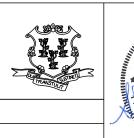TOWN:	DOT PROJ: 15-374
CITY OF BRIDGEPORT	
	DRAWING NO.:
DRAWING TITLE:	TS-7
TYPICAL SECTIONS - 7	SHEET NO.:

12

CITY OF BRIDGEPORT ENGINEER: NV5 APPROVED BY: DATE: JUNE 3, 2020

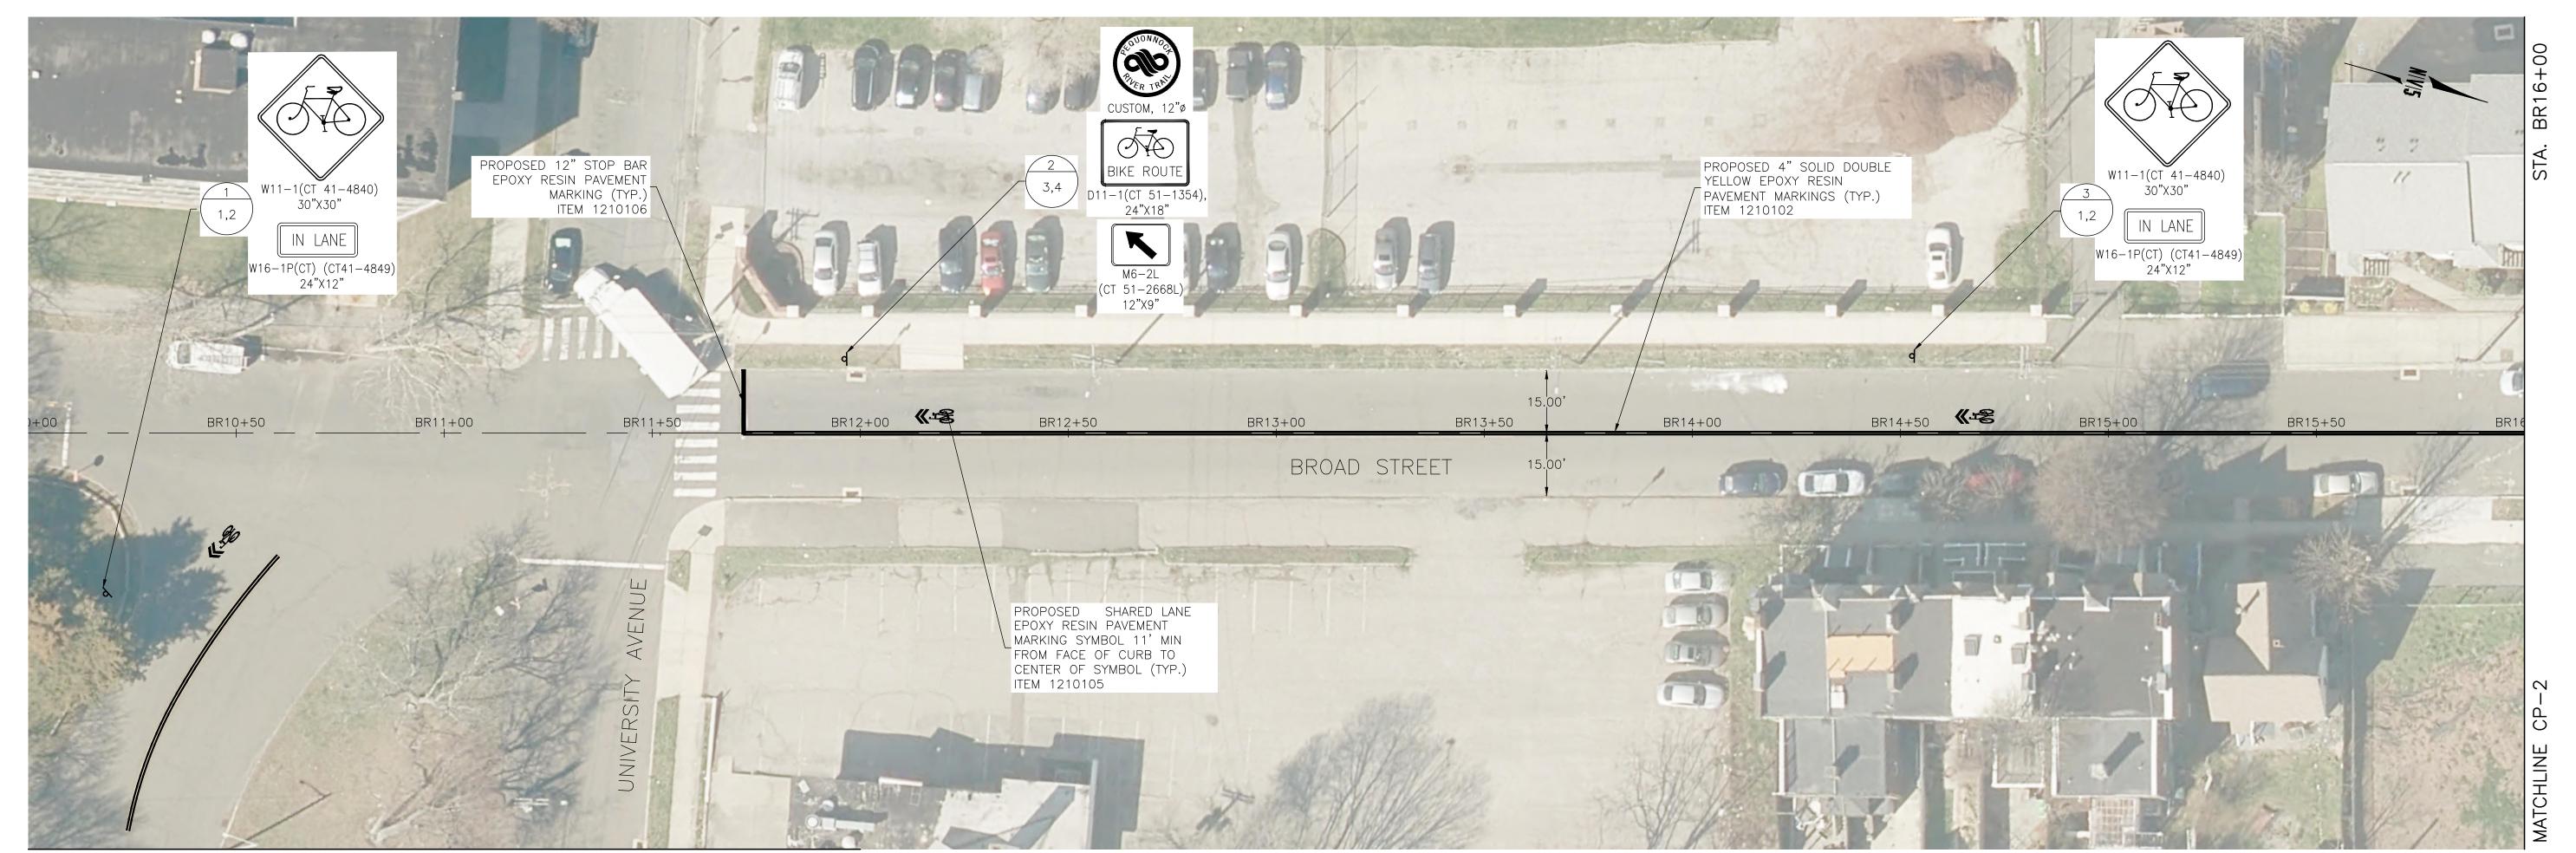


SEE CP-4

NOTE


- 1. FINAL PAVEMENT MARKINGS TO BE EPOXY RESIN UNLESS OTHERWISE NOTED.
- 2. THE CONTRACTOR SHALL REMOVE ANY CONFLICTING EXISTING PAVEMENT MARKINGS WITHIN THE PAVEMENT MARKING LIMITS. THIS WORK SHALL BE PAID UNDER ITEM NO. 1211001—REMOVAL OF PAVEMENT MARKINGS. ALL OTHER EXISTING PAVEMENT MARKINGS TO REMAIN.
- 3. SIGNS SHALL BE INSTALLED PER CONNDOT STANDARD SHEETS "SIGN PLACEMENT AND RETROREFLECTIVE STRIP DETAILS" AND "METAL SIGN POSTS AND SIGN MOUNTING DETAILS" UNLESS OTHERWISE NOTED.
- 4. ALL EXISTING SIGNS WITHIN THE LIMITS OF SIGNING ARE TO REMAIN UNLESS OTHERWISE NOTED OR DIRECTED BY THE ENGINEER. THE CONTRACTOR SHALL REMOVE ANY EXISTING SIGNS CONFLICTING WITH PROPOSED SIGNS WITHIN THE LIMITS OF SIGNING.
- 5. "NO PARKING SIGNS" SHALL BE INSTALLED AT AN ANGLE BETWEEN 30° AND 45° FROM THE ADJACENT TRAVELWAY.
- 6. SIGNS SHOULD BE INSTALLED AT LEAST 10' FROM ALL UTILITY POLES.
- 7. EXACT LOCATIONS OF THE SIGNS TO BE VERIFIED BY THE ENGINEER.
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LEGEND:

SIGN LOCATION #

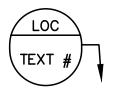


									SCALE: 1"=20'
			DESIGNER: M. BORST	CL Usuma August C	A SECTION	PRO	DECT TITLE:	TOWN:	DOT PROJ: 15-374
			DDAFTED, M. DODCT	CITY OF	F BRIDGEPORT	THE OF CONNECTION	PEQUONNOCK RIVER TRAIL	CITY OF BRIDGEPORT	
			DRAFTER: M. BORST	TCORPORTED BS		NIGNA WILLIAM	EXTENSION	DRAWING TITLE:	DRAWING NO.: CP-1
			CHECKED BY: S. NORMANDIN	ENGINEER: NV5		No. 32270		CONSTRUCTION PLANS	SHEET NO.:
REV. DATE	DESCRIPTION REVISIONS	SHEET. NO.		APPROVED BY:	DATE: JUNE 3, 20	20		BROAD STREET-1	13

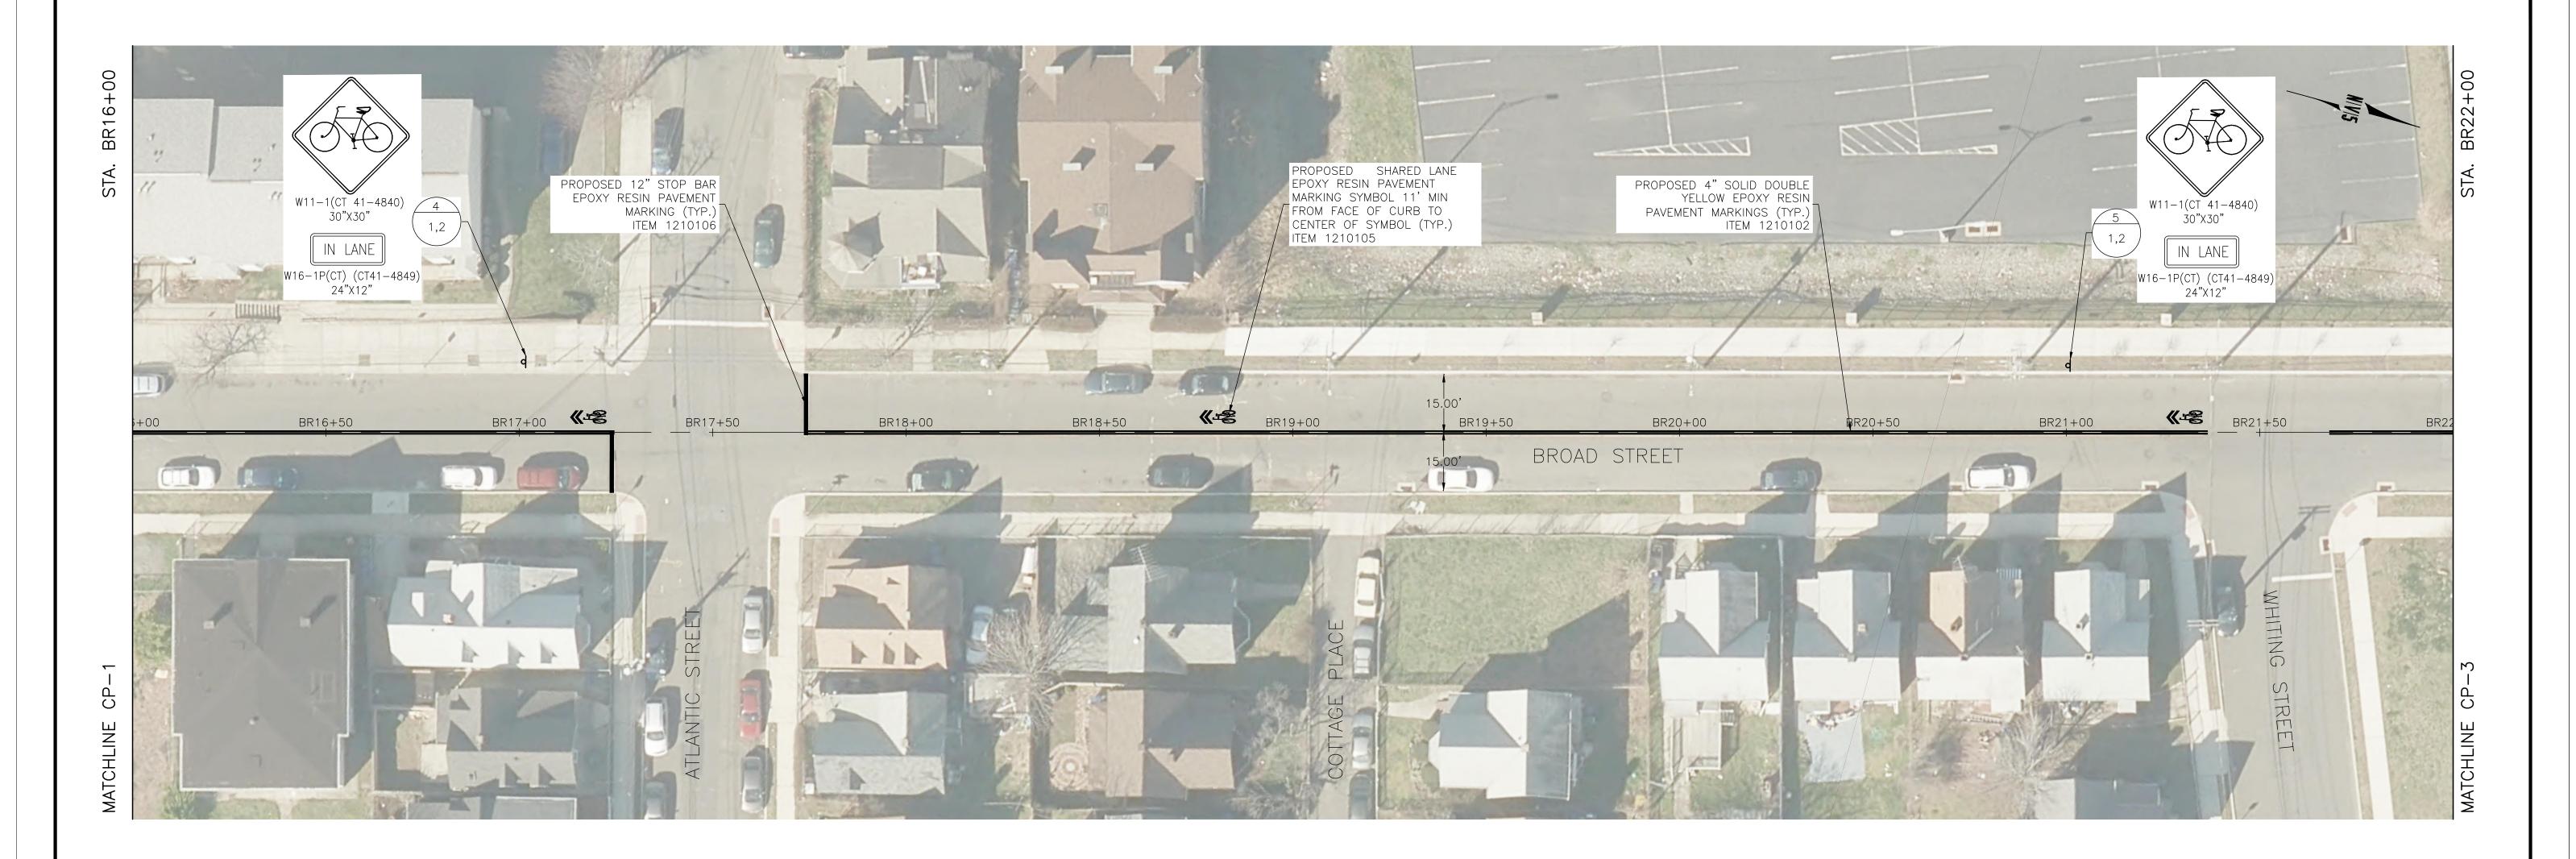


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LEGEND:

SIGN LOCATION #

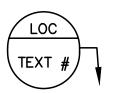

									SCALE: 1"=20'
			DESIGNER: M. BORST	CT OF BRIDGE PORT		mm.	PROJECT TITLE:	TOWN:	DOT PROJ: 15-374
			DRAFTER: M. BORST	CITY C	OF BRIDGEPORT		PEQUONNOCK RIVER TRAIL	CITY OF BRIDGEPORT	DRAWING NO.:
				MCORPORATED 839		* is	EXTENSION	DRAWING TITLE:	CP-2
			CHECKED BY: S. NORMANDIN	ENGINEER: NV5			CENSED MEETING	CONSTRUCTION PLANS	SHEET NO.:
EV. DATE	DESCRIPTION REVISIONS	SHEET. NO.		APPROVED BY:	D	ATE: JUNE 3, 2020	William III III III III III III III III III I	BROAD STREET-2	14

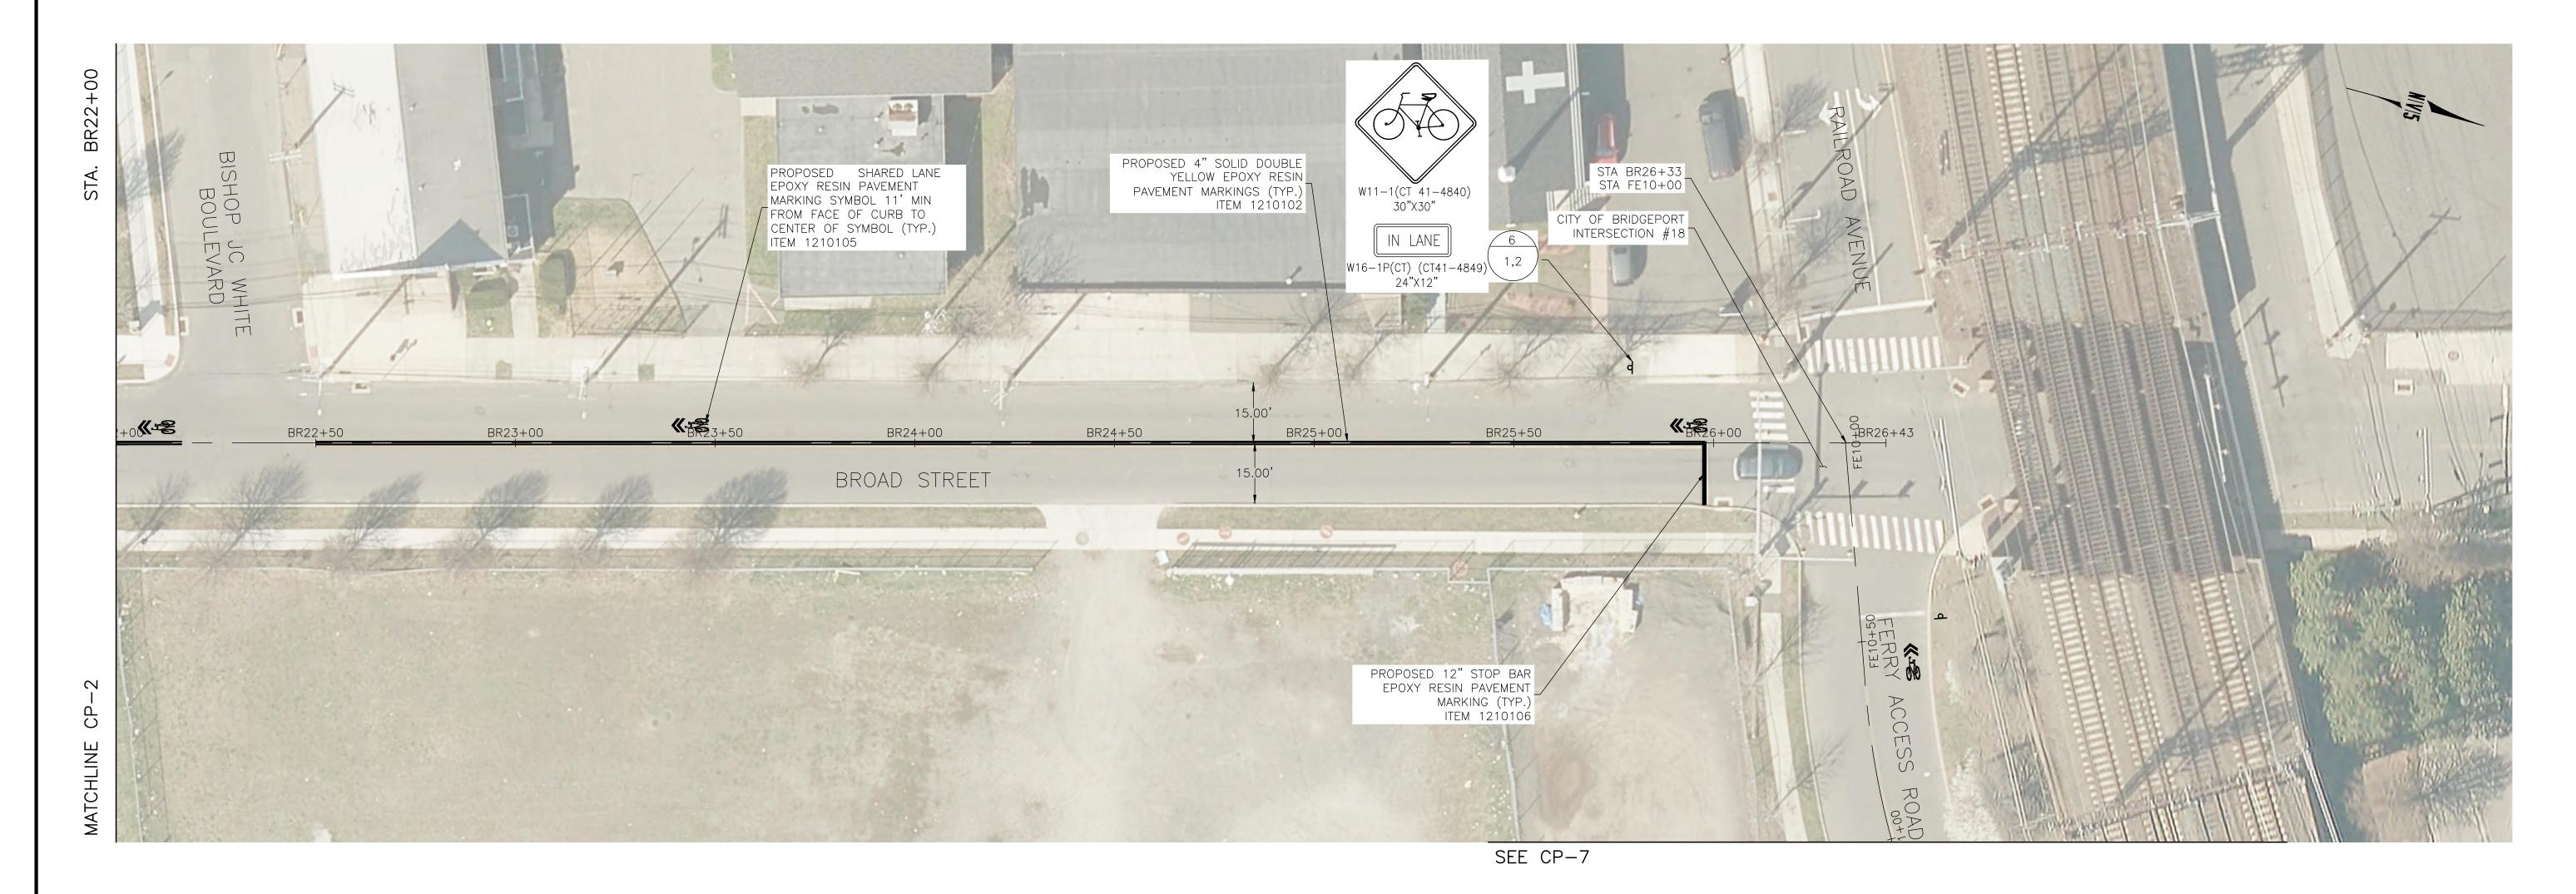


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LEGEND:


SIGN LOCATION #

SIGN #'S

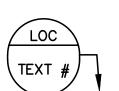

DESIGNER: M. BORST DOT PROJ: 15-374 CITY OF BRIDGEPORT CITY OF BRIDGEPORT PEQUONNOCK RIVER TRAIL DRAFTER: M. BORST DRAWING NO.: **EXTENSION** DRAWING TITLE: CONSTRUCTION PLANS CHECKED BY: S. NORMANDIN **ENGINEER: NV5** SHEET NO.: REV. DATE DESCRIPTION SHEET. NO. 15 **BROAD STREET-3** APPROVED BY: DATE: JUNE 3, 2020 REVISIONS

SEE CP-1

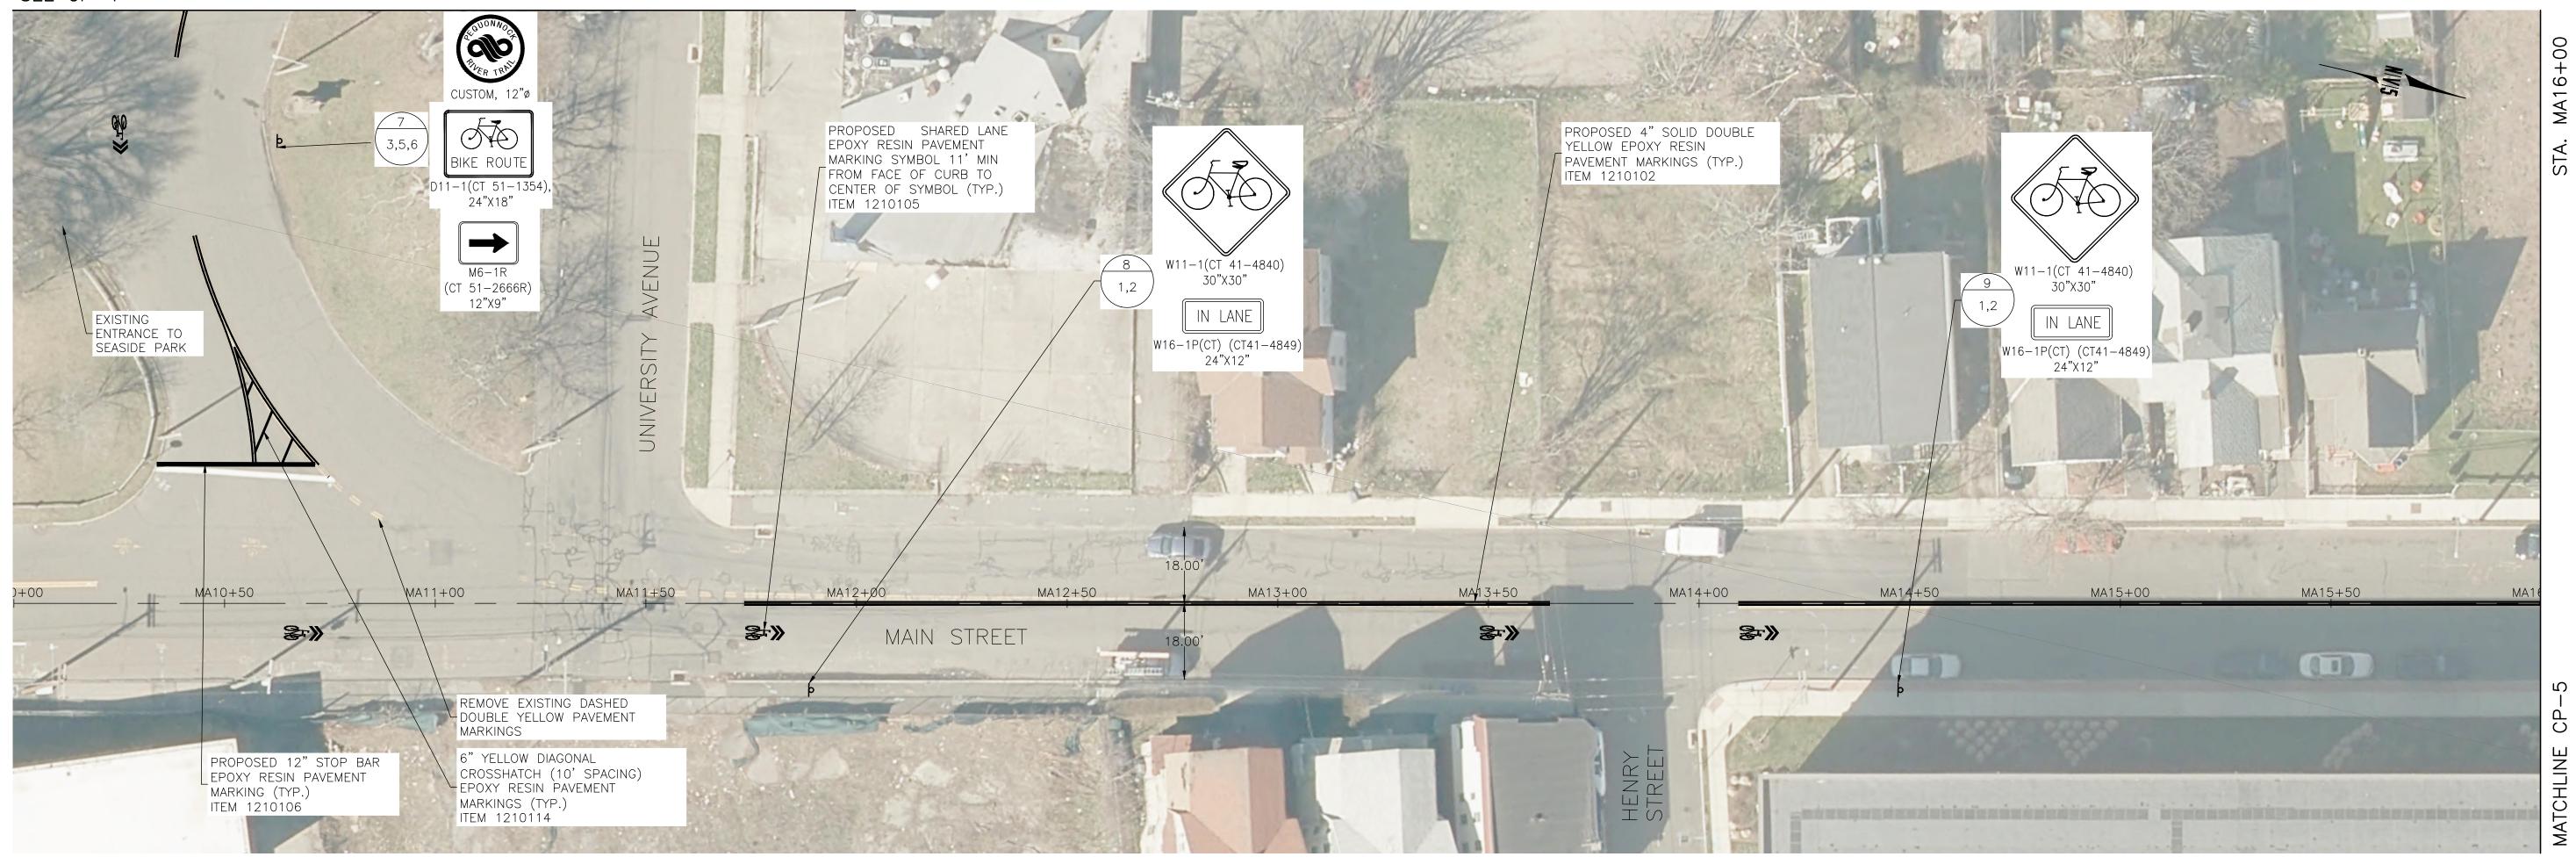


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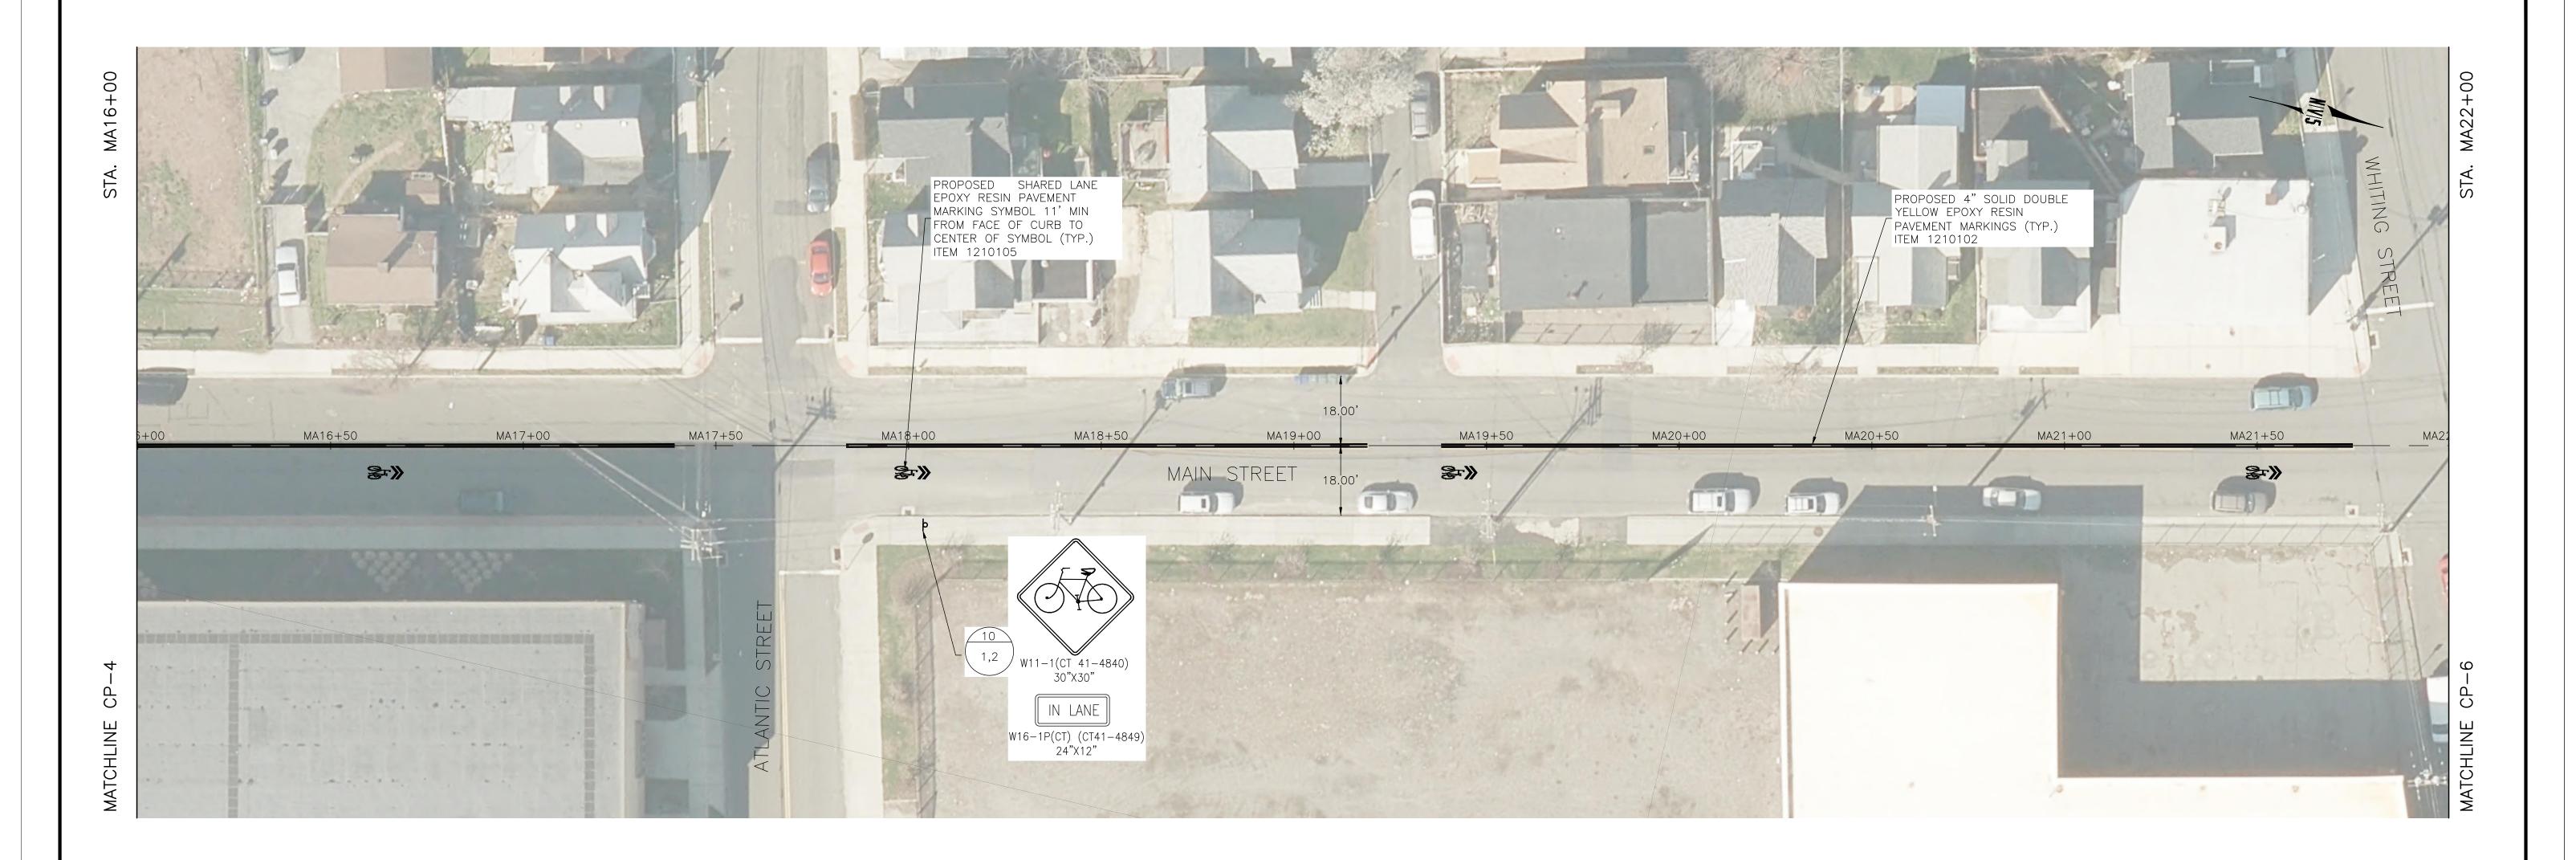
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LEGEND:

SIGN LOCATION #




									SCALE: 1"=20'
			DESIGNER: M. BORST	STATE BRIDGEPORT	A GROZE D	······································	ROJECT TITLE:	TOWN:	DOT PROJ: 15-374
				CITY OF	BRIDGEPORT (**)	W. NOS. C.	PEQUONNOCK RIVER TRAIL	CITY OF BRIDGEPORT	
			DRAFTER: M. BORST		DIVIDUCION	STES	EXTENSION	DRAWING TITLE	DRAWING NO.:
			CHECKED BY: S. NORMANDIN	ENGINEER: NV5	→	No. 22270		DRAWING TITLE: CONSTRUCTION PLANS	CP-4
EV. DATE	DESCRIPTION	SHEET. NO.			DATE, MINE 2, 2022	OS/ONAL ENGINEER			SHEET NO.:
	REVISIONS			APPROVED BY:	DATE: JUNE 3, 2020			MAIN STREET-1	10

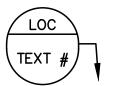


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<u>LEGEND:</u>

SIGN LOCATION #

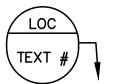

				SCALE: 1"=20'
DESIGNER: M. BORST	OF BRIDGEPOR	PROJECT TITLE:	TOWN:	DOT PROJ: 15-374
DDAFTED M. BODGT	CITY OF BRIDGEPORT	PEQUONNOCK RIVER TRAIL	CITY OF BRIDGEPORT	
DRAFIER: M. BURSI		EXTENSION	DRAWING TITLE:	DRAWING NO.: CP-5
CHECKED BY: S. NORMANDIN	ENGINEER: NV5			SHEET NO.:
	APPROVED BY: DATE: JUNE 3, 2020			17
 TION SHEET. NO	DRAFTER: M. BORST CHECKED BY: S. NORMANDIN TION SHEET. NO.	DRAFTER: M. BORST CITY OF BRIDGEPORT CHECKED BY: S. NORMANDIN ENGINEER: NV5 CHECKED BY: S. NORMANDIN CITY OF BRIDGEPORT CHECKED BY: S. NORMANDIN CHECKED BY: S. NORMANDIN CHECKED BY: S. NORMANDIN CHECKED BY: S. NORMANDIN CHECKED BY: S. NORMANDIN	DRAFTER: M. BORST CITY OF BRIDGEPORT CHECKED BY: S. NORMANDIN ENGINEER: NV5 CHECKED BY: S. NORMANDIN ENGINEER: NV5	CITY OF BRIDGEPORT DRAFTER: M. BORST CHECKED BY: S. NORMANDIN ENGINEER: NO. CITY OF BRIDGEPORT DRAWING TITLE: CONSTRUCTION PLANS MAIN STREET 2

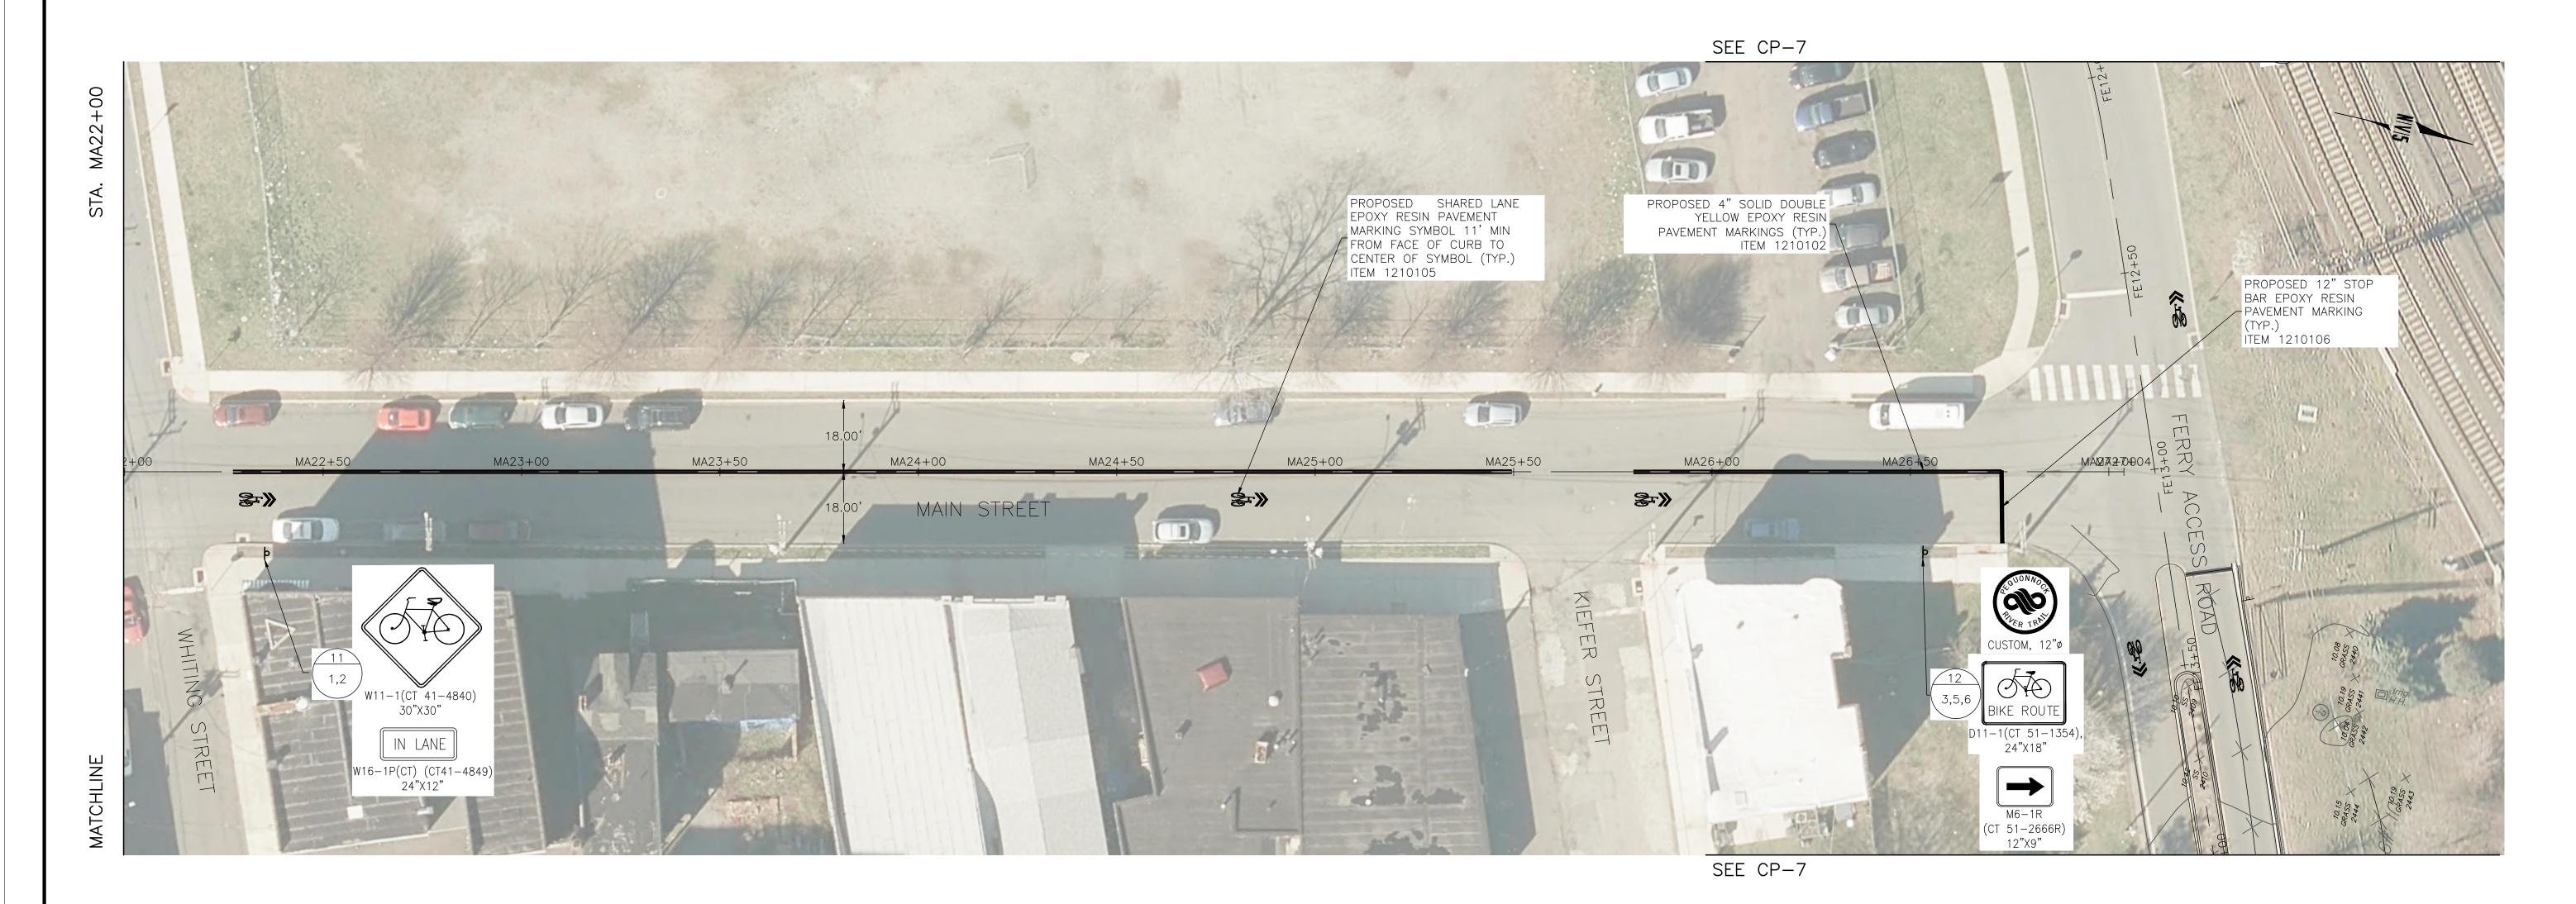


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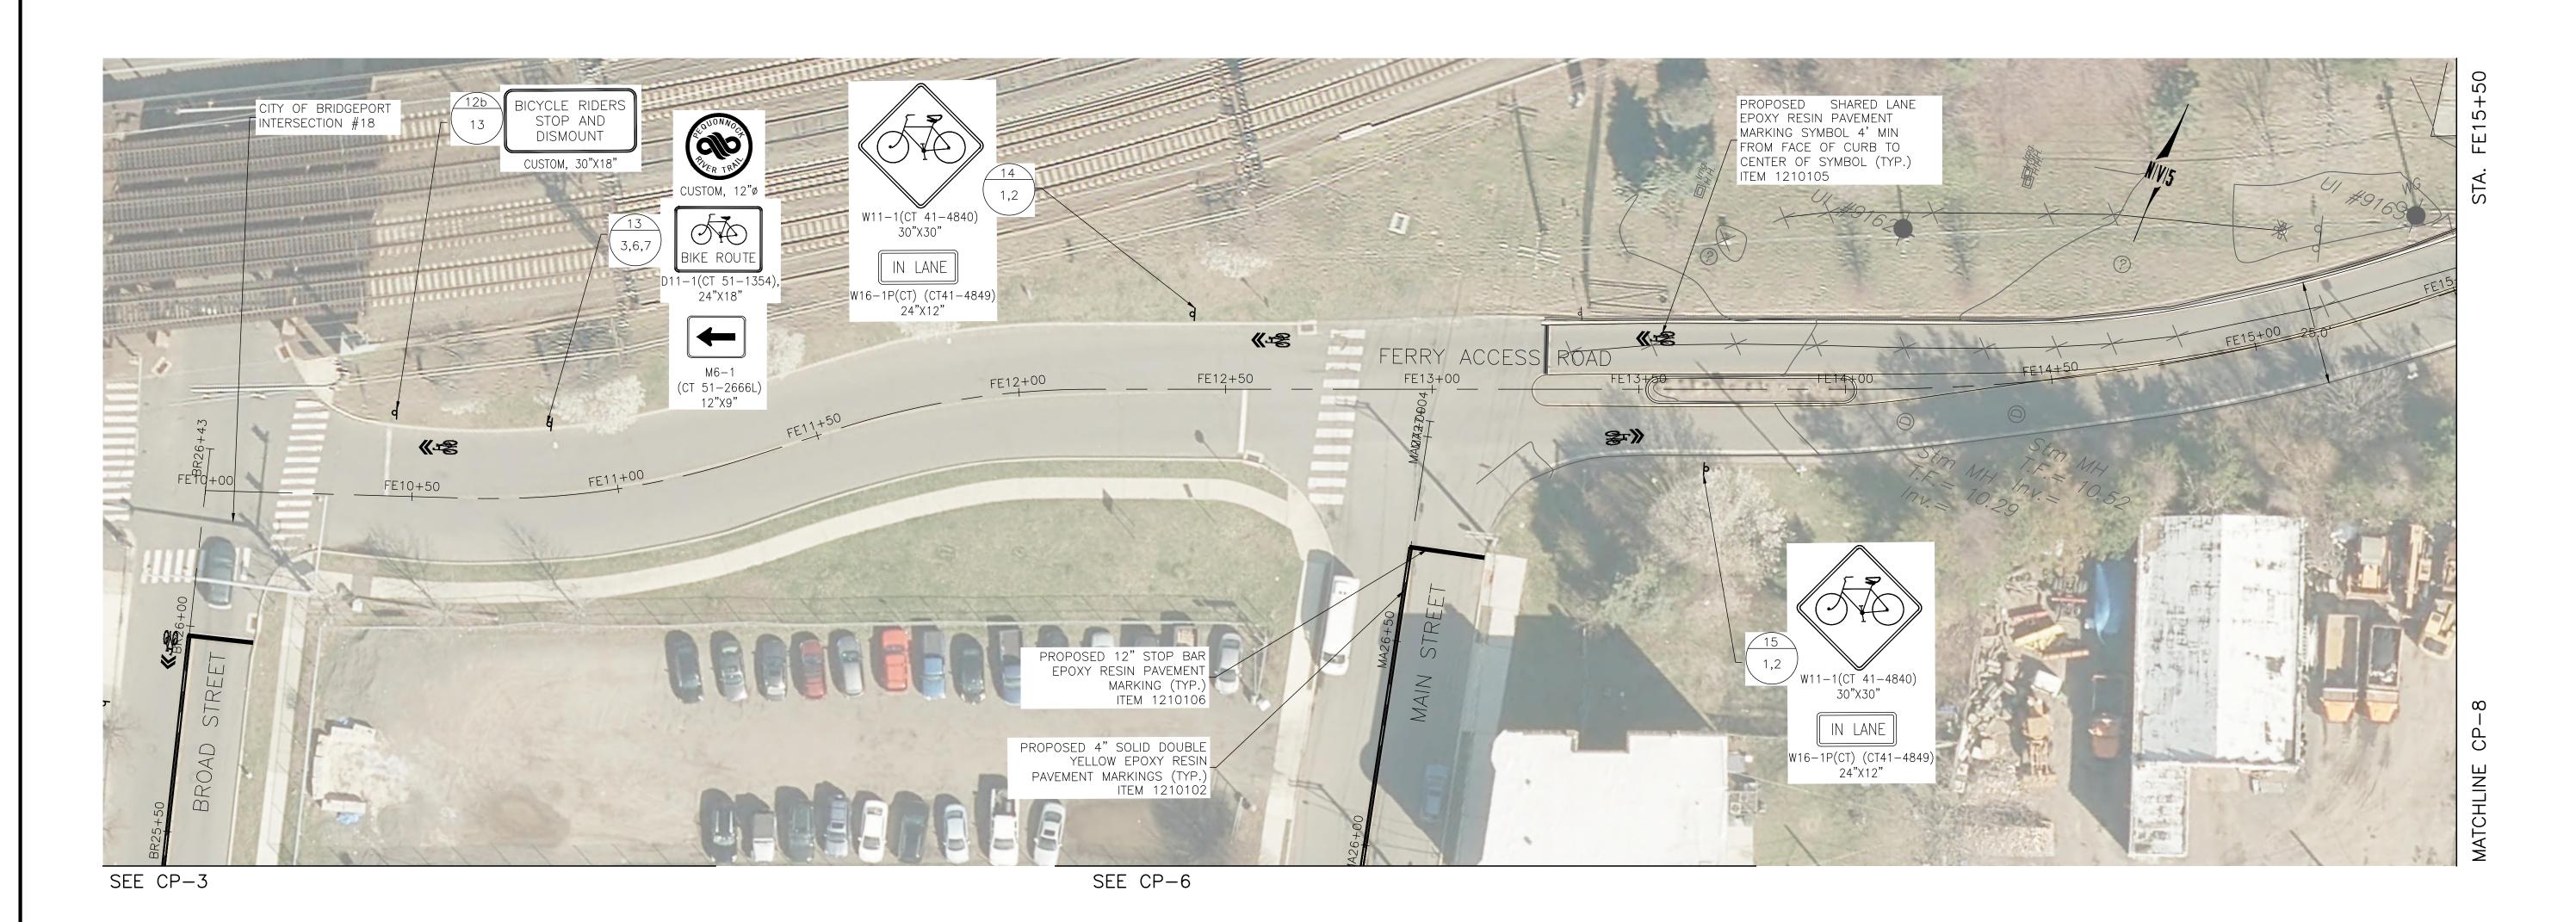
LEGEND:

SIGN LOCATION #

SIGN #'S

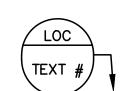


DESIGNER: M. BORST DOT PROJ: 15-374 CITY OF BRIDGEPORT CITY OF BRIDGEPORT PEQUONNOCK RIVER TRAIL DRAFTER: M. BORST DRAWING NO.: **EXTENSION** DRAWING TITLE: CONSTRUCTION PLANS CHECKED BY: S. NORMANDIN **ENGINEER: NV5** SHEET NO.: REV. DATE DESCRIPTION SHEET. NO. 18 MAIN STREET-3 APPROVED BY: DATE: JUNE 3, 2020 REVISIONS




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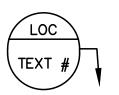
								SCALE: 1"=20'
			DESIGNER: M. BORST	OF BRIDGEPOR		PROJECT TITLE:	TOWN:	DOT PROJ: 15-374
			DRAFTER: M. BORST	CITY OF BRIDG	SEPORT OF CONNECTION OF CONNEC	PEQUONNOCK RIVER TRAIL	CITY OF BRIDGEPORT	DRAWING NO.:
			CHECKED BY: S. NORMANDIN	ENGINEER: NV5	No 22200	EXTENSION	DRAWING TITLE: CONSTRUCTION PLANS	CP-7
REV. DATE	DESCRIPTION REVISIONS	SHEET. NO.	CHECKED DIT OF HORITHMENT	APPROVED BY:	DATE: JUNE 3, 2020		FERRY ACCESS ROAD - 1	SHEET NO.:



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LEGEND:

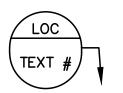SIGN LOCATION #

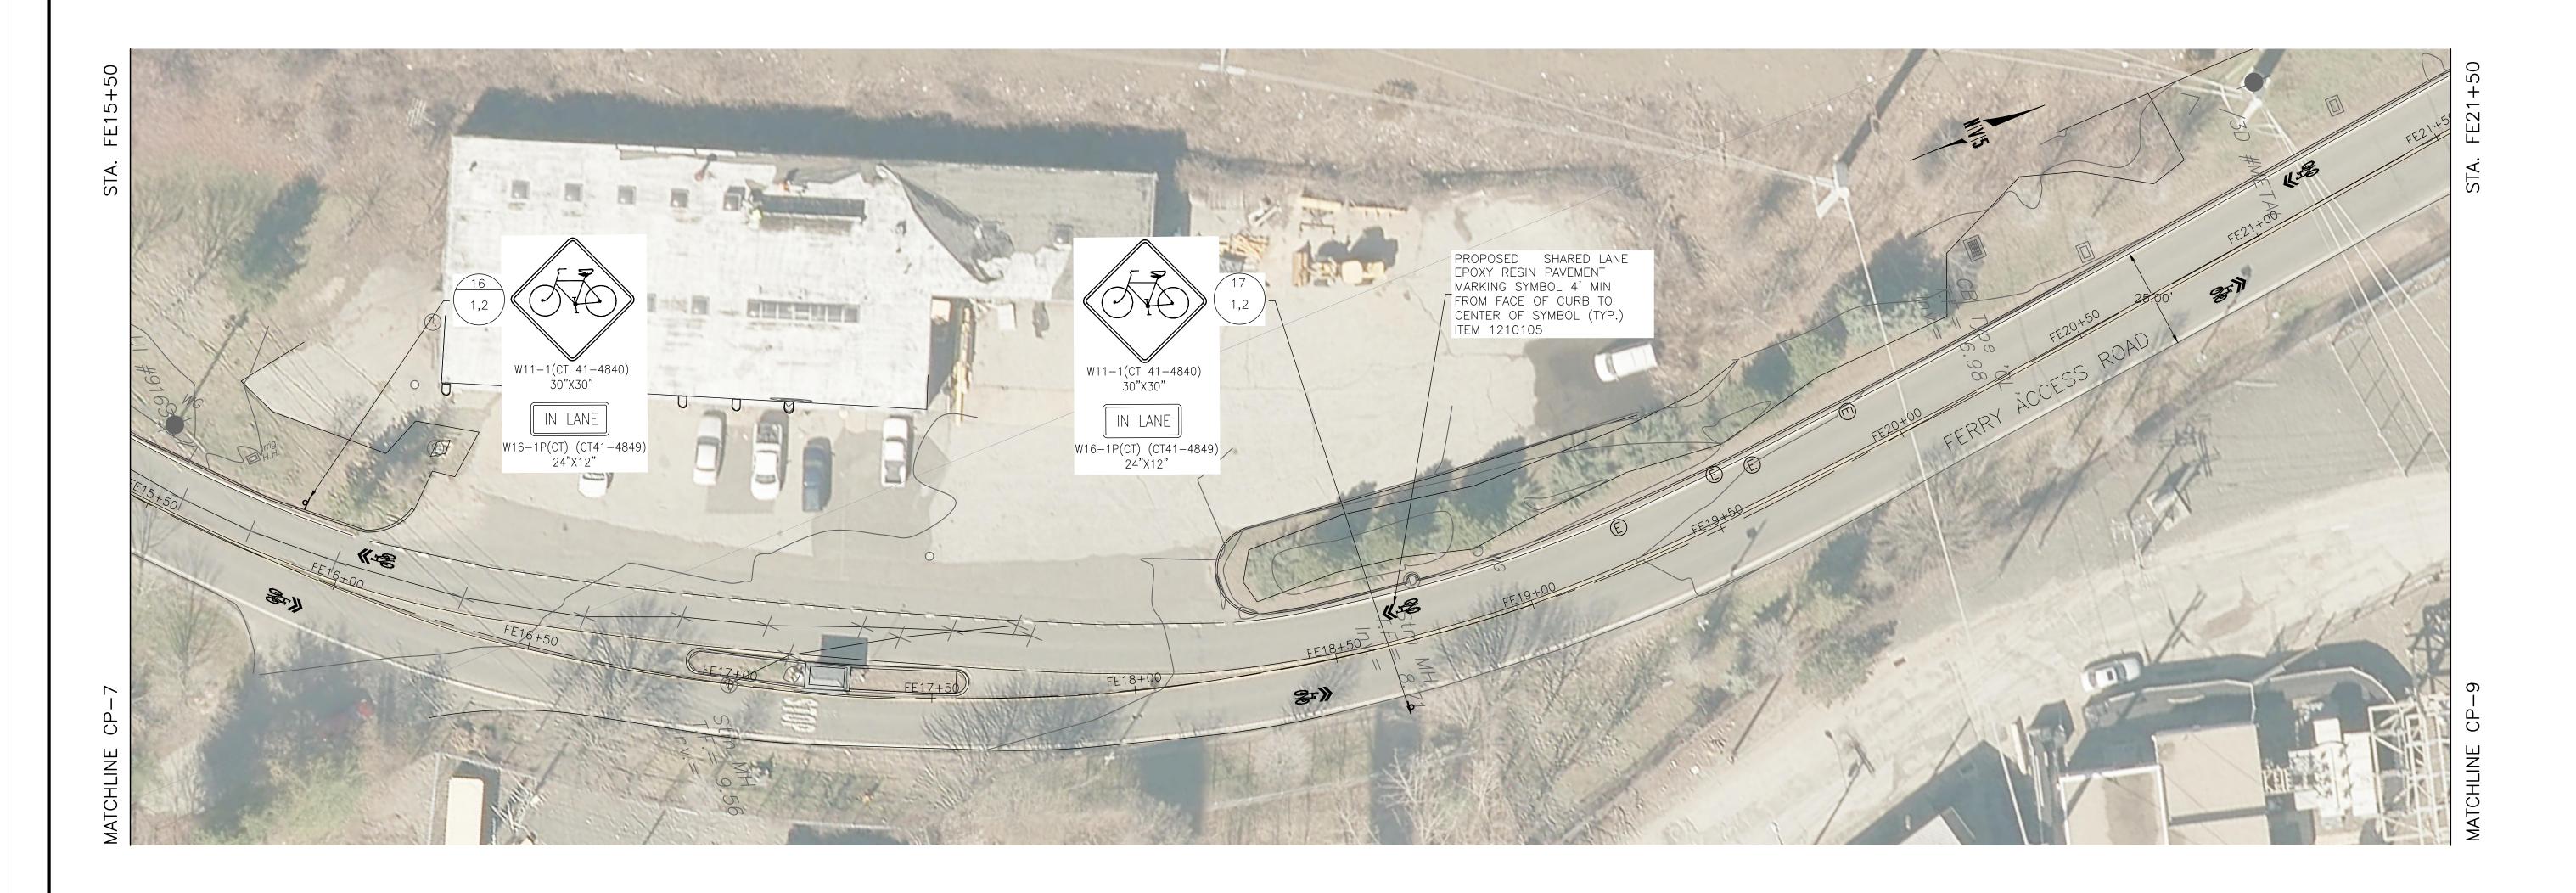

								SCALE: 1"=20'
			DESIGNER: M. BORST	CT OF BRIDGE FOR		PROJECT TITLE:	TOWN:	DOT PROJ: 15-374
			DRAFTER: M. BORST	CITY OF BRIDGEPO	RT W No see to s	PEQUONNOCK RIVER TRAIL	CITY OF BRIDGEPORT	DRAWING NO.:
				ALCORPORATED 1838	No decree	EXTENSION	DRAWING TITLE:	CP-8
()	DECONTRACTION .	QUEET NO	CHECKED BY: S. NORMANDIN	ENGINEER: NV5	A TOTAL CEMPER WITH		CONSTRUCTION PLANS	SHEET NO.:
. DATE	DESCRIPTION REVISIONS	SHEET. NO.		APPROVED BY:	DATE: JUNE 3, 2020		FERRY ACCESS ROAD - 2	20




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LEGEND:

SIGN LOCATION #

SIGN #'S

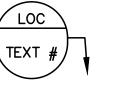

		DESIGNER: M. BORST	St. of BRIDGEFORE		PROJECT TITLE:
		DRAFTER: M. BORST	CITY OF BRIDGEPOR	RT W. NO.	PEQUONNOCK RIVER TRAI EXTENSION
		CHECKED BY: S. NORMANDIN	ENGINEER: NV5	No. 22280 CENSES	
DESCRIPTION	SHEET. NO.		APPROVED BY:	DATE: JUNE 3, 2020	
	DESCRIPTION	DESCRIPTION SHEET. NO.	DRAFTER: M. BORST CHECKED BY: S. NORMANDIN	DESIGNER: M. BORST DRAFTER: M. BORST CITY OF BRIDGEPOR CHECKED BY: S. NORMANDIN ENGINEER: NV5	DESIGNER: M. BORST DRAFTER: M. BORST CITY OF BRIDGEPORT CHECKED BY: S. NORMANDIN ENGINEER: NV5 CHECKED BY: S. NORMANDIN

O 20 40
SCALE: 1"=20'

TOWN:

CITY OF BRIDGEPORT

DRAWING TITLE:


DOT PROJ: 15-374

DRAWING NO.:

CP-

CONSTRUCTION PLANS
FERRY ACCESS ROAD - 3

CP-9
SHEET NO.:
21

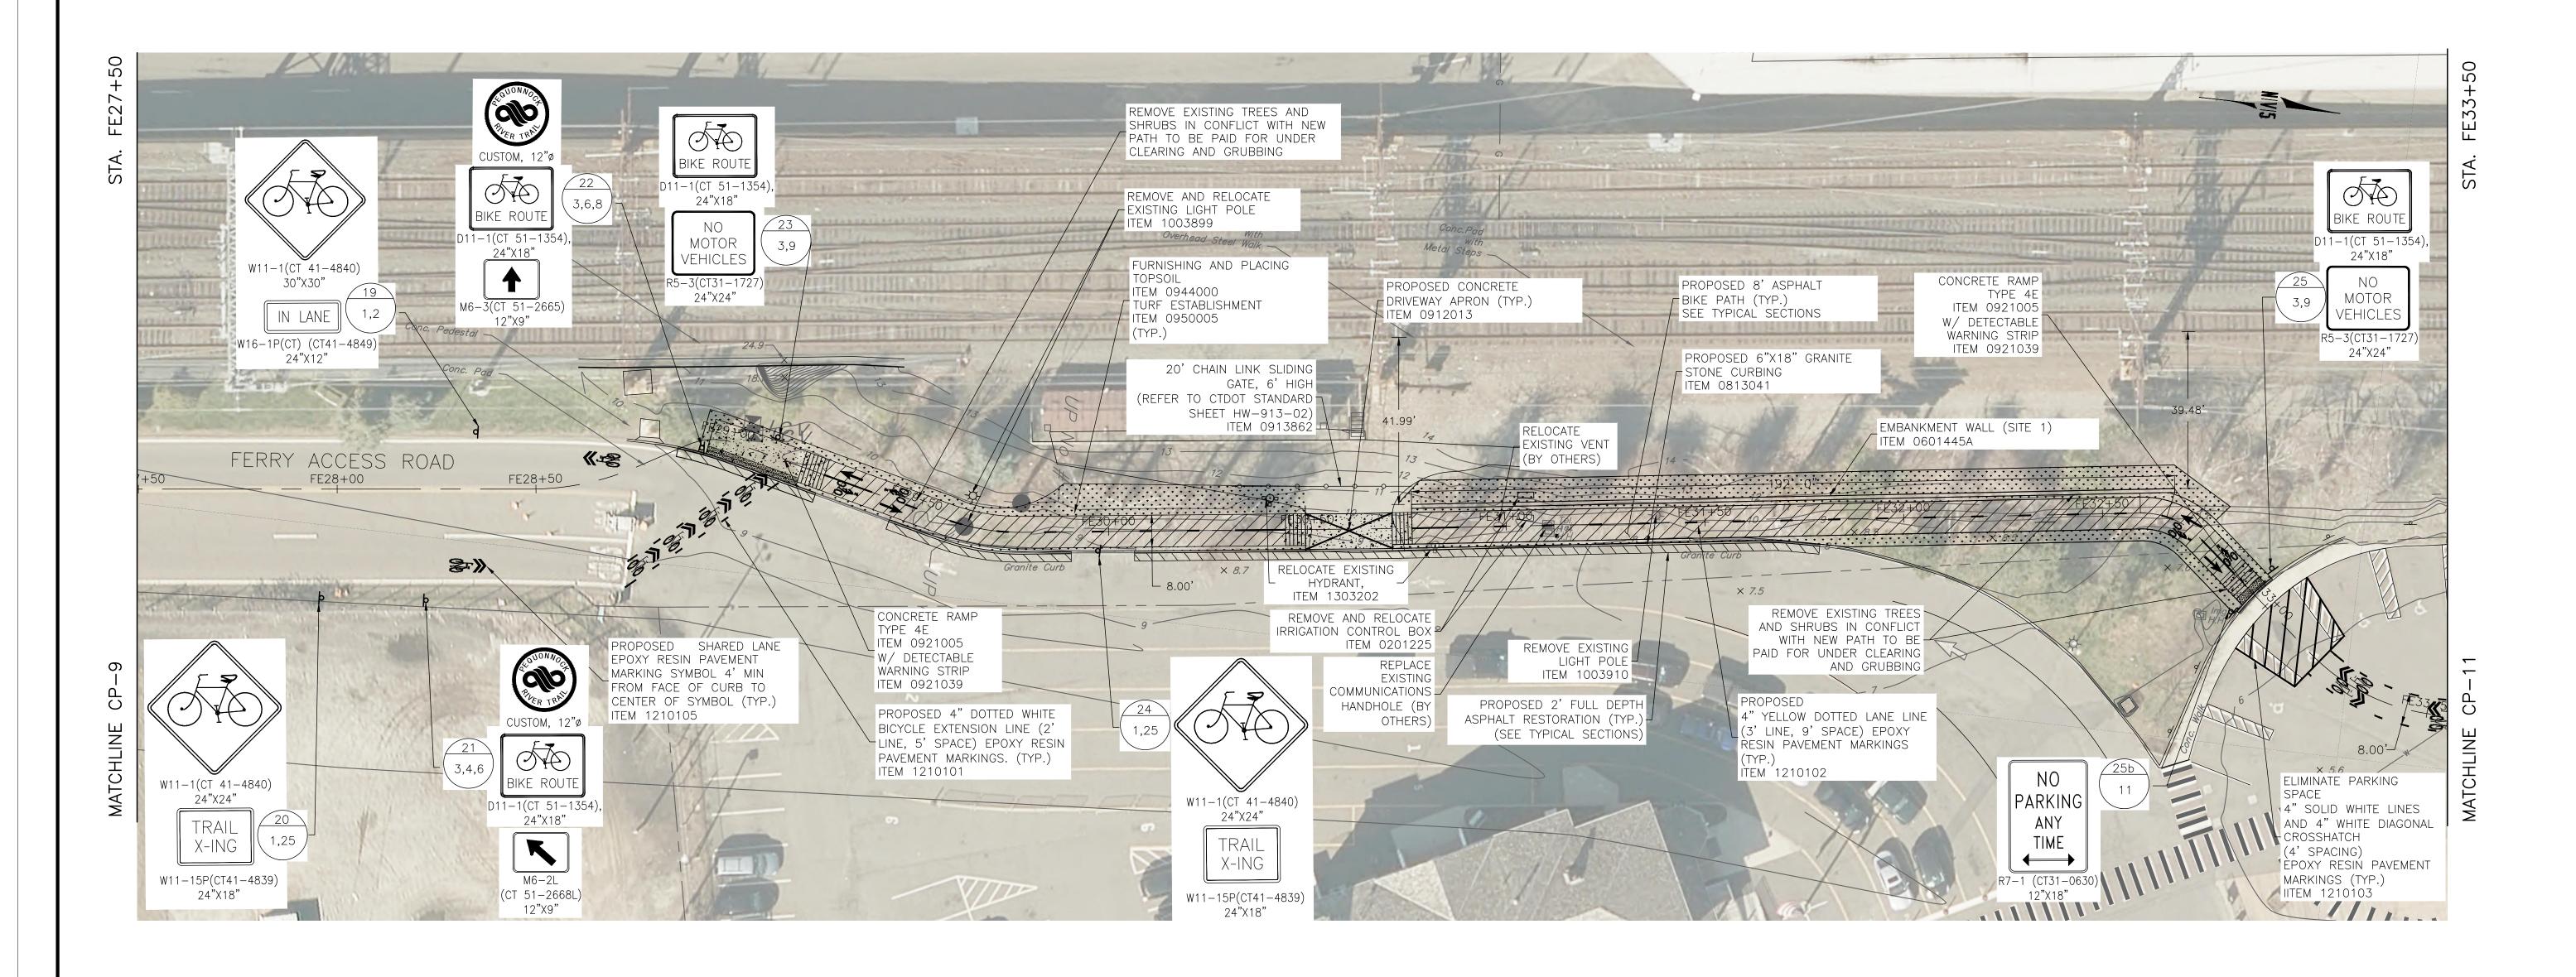


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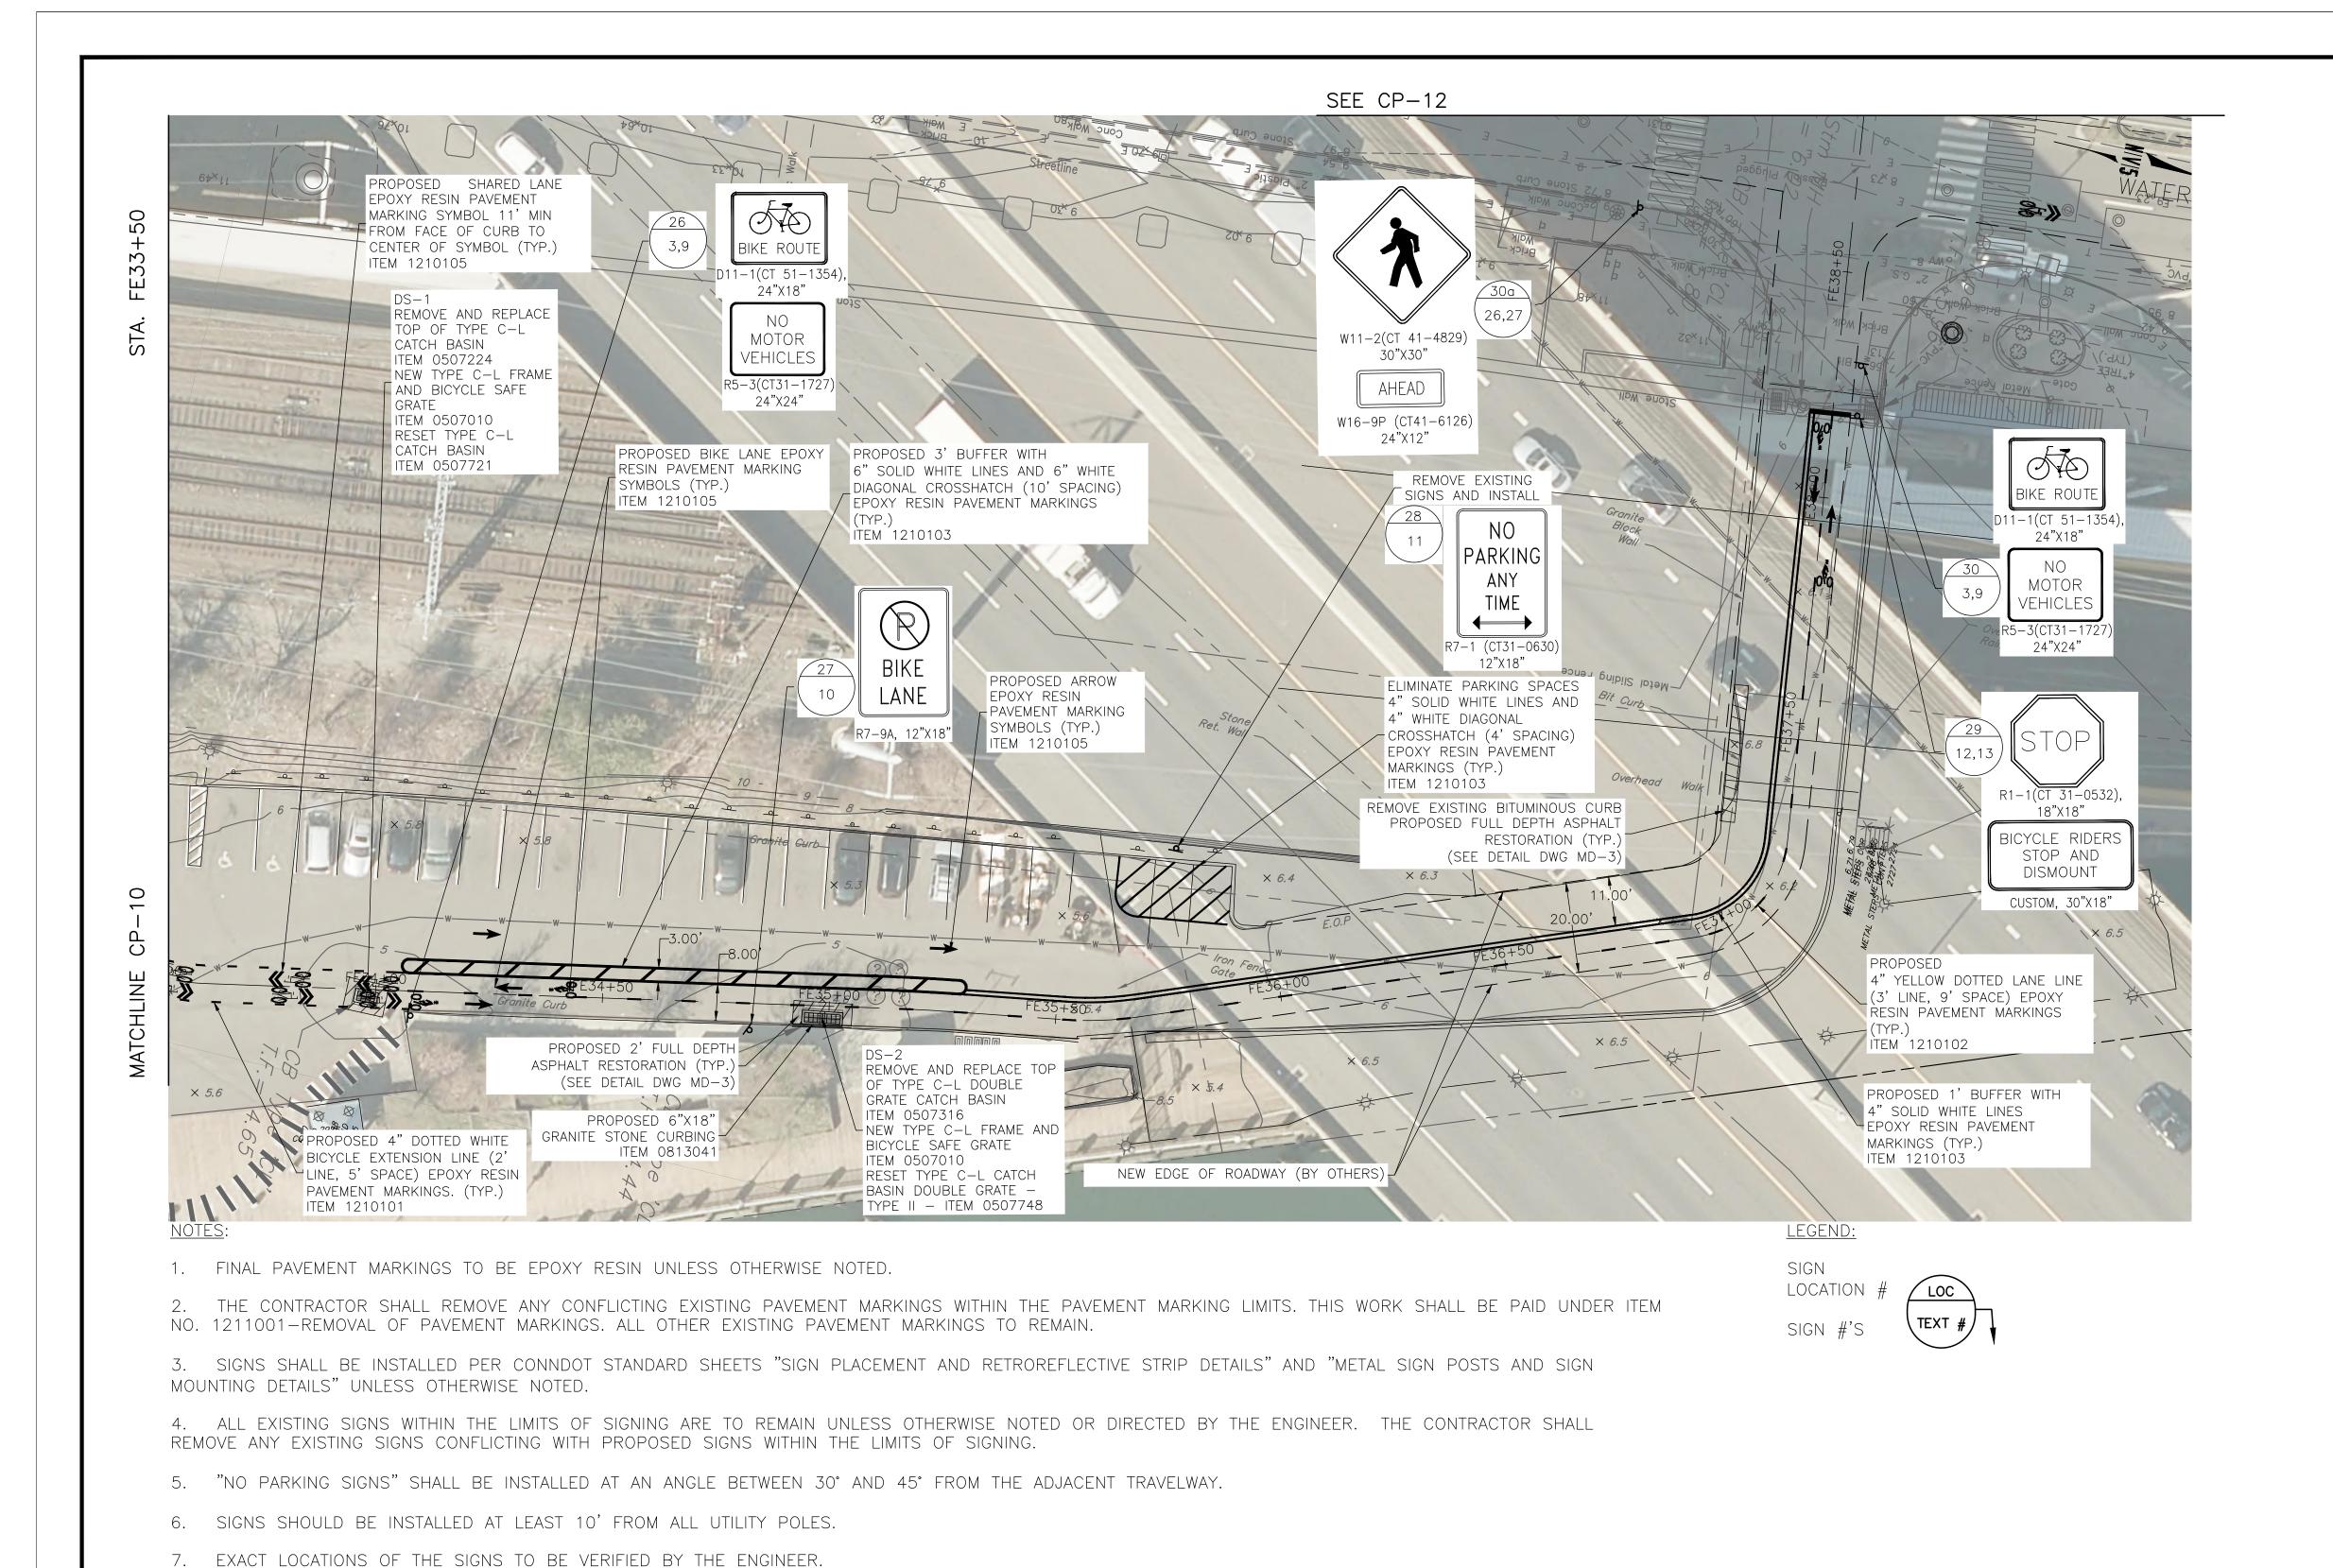
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LEGEND:

SIGN LOCATION #




			DESIGNER: M. BORST	CTTV OF D		OF CONNE	PROJECT TITLE:	CITY OF BRIDGEPORT	DOT PROJ: 15-374
			DRAFTER: M. BORST	CITY OF B	RIDGEPORT	STEE STEE	PEQUONNOCK RIVER TRAIL EXTENSION	DRAWING TITLE:	DRAWING NO.:
	D FOODY DTVO	0.1777 110	CHECKED BY: S. NORMANDIN	ENGINEER: NV5		CENSED THE		CONSTRUCTION PLANS	SHEET NO.:
V. DATE	DESCRIPTION REVISIONS	SHEET. NO.		APPROVED BY:	DATE: JUNE 3, 202	0		FERRY ACCESS ROAD - 4	22

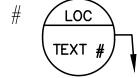

8. THE STATE WILL MAINTAIN ALL SIGNS AND PAVEMENT MARKINGS, EXCEPT BIKE SIGNS AND SHARROW PAVEMENT MARKINGS, ON ROUTE 130 (THE STATE STREET SECTION), SR 700, AND ROUTE 1 (AS WELL AS STOP BARS ON NOBLE AVENUE AND CONCORD STREET ON ROUTE 1). CITY IS TO MAINTAIN ALL BICYCLE SIGNING, ALL

SHARROW MARKINGS, AND ALL SIGNS AND PAVEMENT MARKINGS ON ROUTE 130 (THE WATER STREET SECTION).

DESIGNER: M. BORST DOT PROJ: 15-374 CITY OF BRIDGEPORT CITY OF BRIDGEPORT PEQUONNOCK RIVER TRAIL DRAFTER: M. BORST DRAWING NO.: **EXTENSION** CP-11 DRAWING TITLE: CONSTRUCTION PLANS **ENGINEER: NV5** CHECKED BY: S. NORMANDIN SHEET NO.: REV. DATE DESCRIPTION SHEET. NO. 23 FERRY ACCESS ROAD - 5 APPROVED BY: DATE: JUNE 3, 2020 REVISIONS

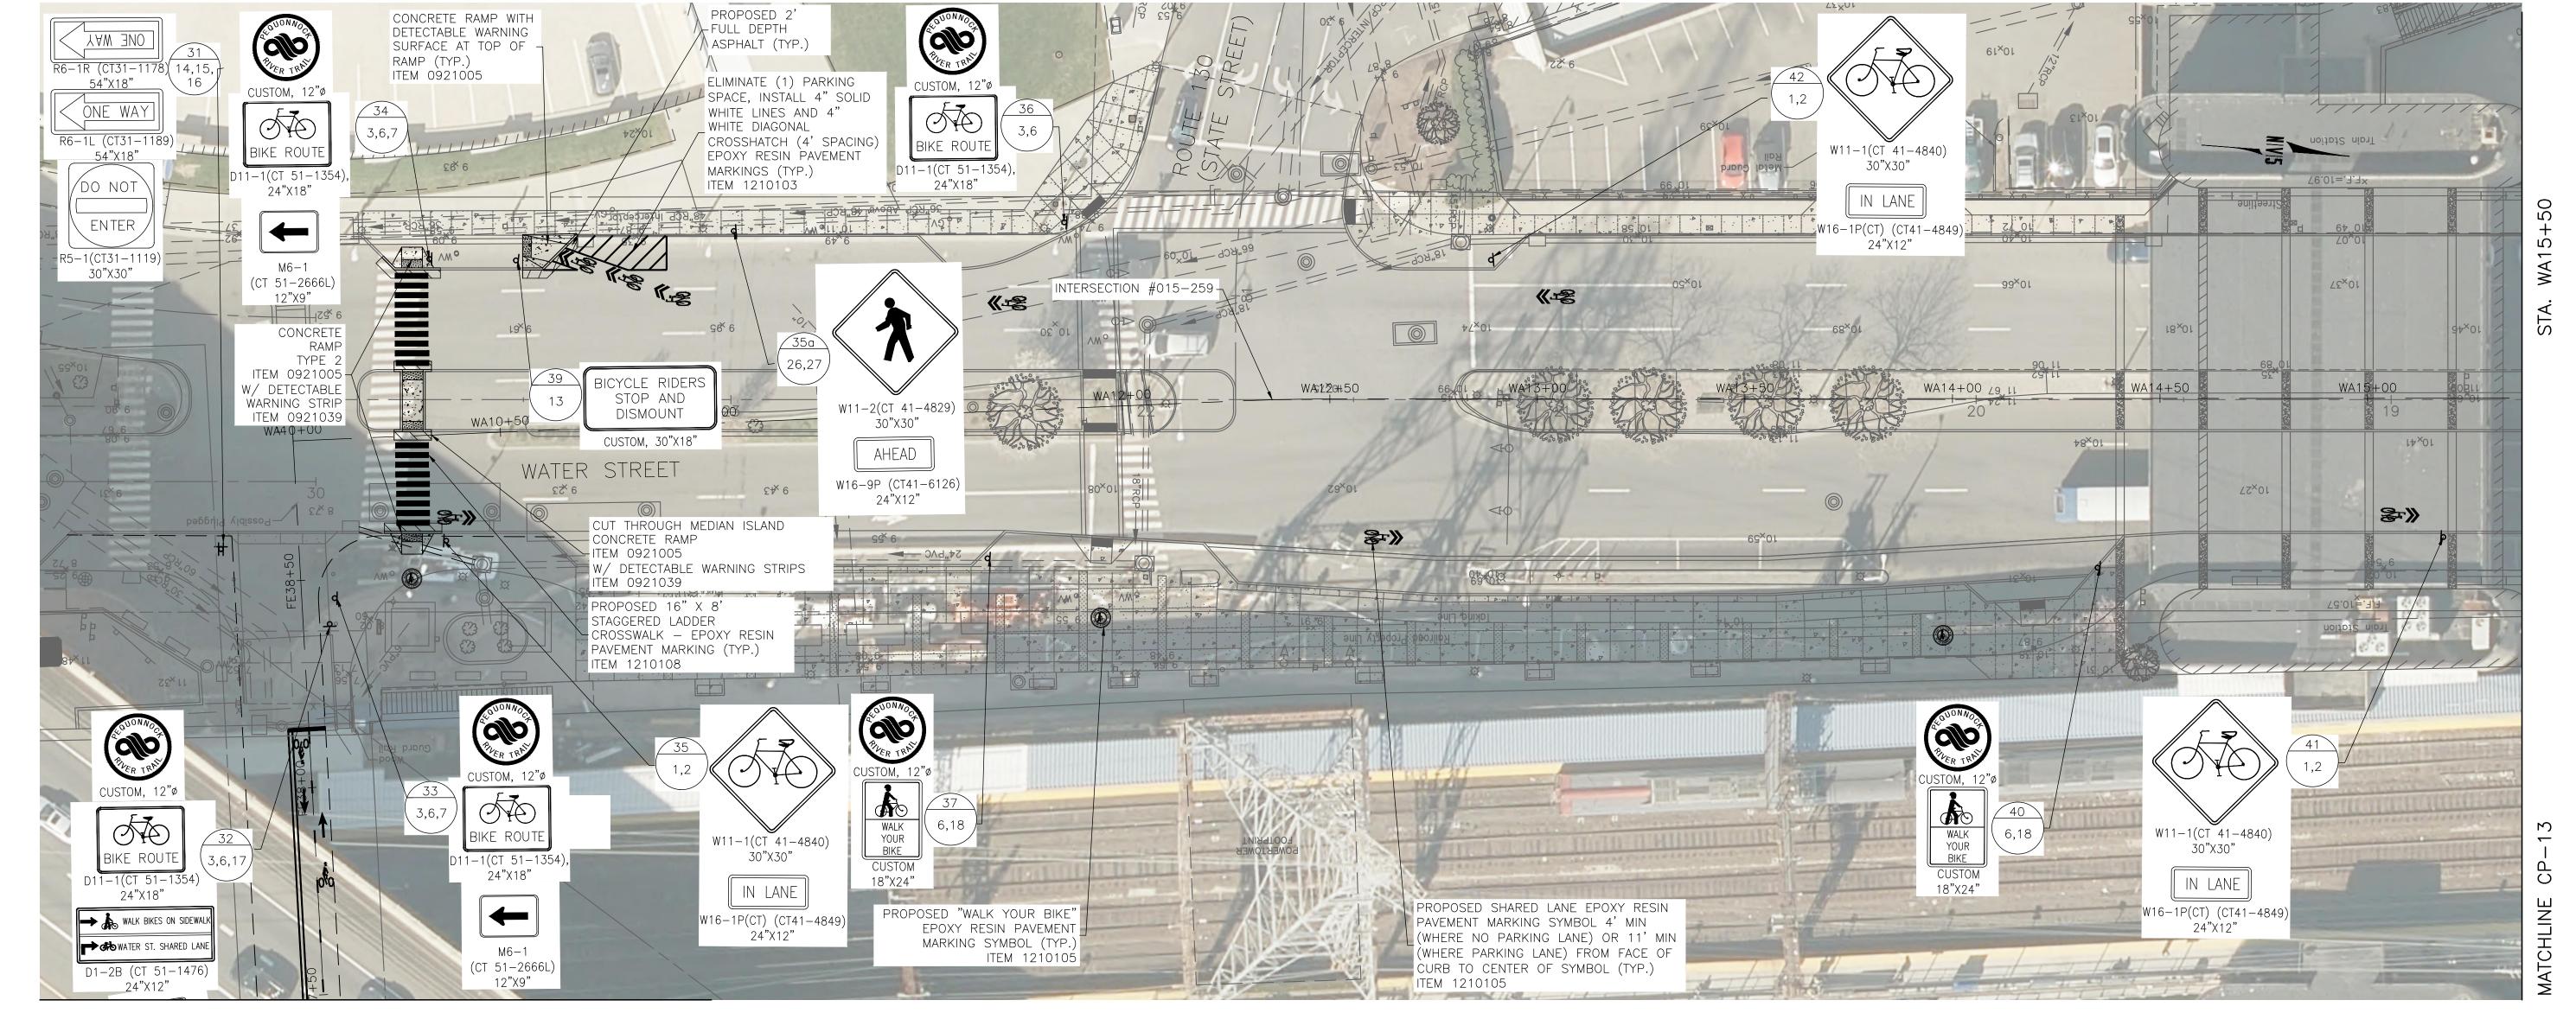

SEE CP-11


NOTES:

- 1. FINAL PAVEMENT MARKINGS TO BE EPOXY RESIN UNLESS OTHERWISE NOTED.
- 2. THE CONTRACTOR SHALL REMOVE ANY CONFLICTING EXISTING PAVEMENT MARKINGS WITHIN THE PAVEMENT MARKING LIMITS. THIS WORK SHALL BE PAID UNDER ITEM NO. 1211001—REMOVAL OF PAVEMENT MARKINGS. ALL OTHER EXISTING PAVEMENT MARKINGS TO REMAIN.
- 3. SIGNS SHALL BE INSTALLED PER CONNDOT STANDARD SHEETS "SIGN PLACEMENT AND RETROREFLECTIVE STRIP DETAILS" AND "METAL SIGN POSTS AND SIGN MOUNTING DETAILS" UNLESS OTHERWISE NOTED.
- 4. ALL EXISTING SIGNS WITHIN THE LIMITS OF SIGNING ARE TO REMAIN UNLESS OTHERWISE NOTED OR DIRECTED BY THE ENGINEER. THE CONTRACTOR SHALL REMOVE ANY EXISTING SIGNS CONFLICTING WITH PROPOSED SIGNS WITHIN THE LIMITS OF SIGNING.
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- 6. SIGNS SHOULD BE INSTALLED AT LEAST 10' FROM ALL UTILITY POLES.
- 7. EXACT LOCATIONS OF THE SIGNS TO BE VERIFIED BY THE ENGINEER.
- 8. THE STATE WILL MAINTAIN ALL SIGNS AND PAVEMENT MARKINGS, EXCEPT BIKE SIGNS AND SHARROW PAVEMENT MARKINGS, ON ROUTE 130 (THE STATE STREET SECTION), SR 700, AND ROUTE 1 (AS WELL AS STOP BARS ON NOBLE AVENUE AND CONCORD STREET ON ROUTE 1). CITY IS TO MAINTAIN ALL BICYCLE SIGNING, ALL SHARROW MARKINGS, AND ALL SIGNS AND PAVEMENT MARKINGS ON ROUTE 130 (THE WATER STREET SECTION).

LEGEND:


SIGN LOCATION #

SIGN #'S

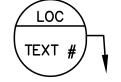

DOWNTOWN INTERMODAL URBAN DESIGN ENHANCEMENT PROJECT NOTE:
THE CONTRACTOR IS ADVISED THE DOWNTOWN INTERMODAL URBAN DESIGN
ENHANCEMENT PROJECT — WATER STREET (ROUTE 130) MAY BE COMPLETED,
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TRAIL CONTRACT BEGINS. THE CONTRACTOR SHALL COORDINATE HIS ACTIVITIES
WITH THE CITY AND THE DOWNTOWN INTERMODAL URBAN DESIGN
ENHANCEMENT PROJECT AT NO ADDITIONAL COST. IN THE EVENT THE
INTERMODAL PROJECT HAS NOT BEEN COMPLETED, THE CONTRACTOR UPON
WRITTEN DIRECTION FROM THE CITY, SHALL PROCEED WITH WATER STREET
"OPTION 1" AS SHOWN ON SHEET NO. 24-1 AND 25-1.

			DESIGNER: M. BORST	OF BRIDGEPORT		PRO.	DECT TITLE:	CITY OF BRIDGEPORT	DOT PROJ: 15-374
			DRAFTER: M. BORST	CIIY OF	BRIDGEPORT	WIGHT STATES	PEQUONNOCK RIVER TRAIL EXTENSION	DRAWING TITLE:	DRAWING NO.: CP-12
	DECONTE ON	0.1555-110	CHECKED BY: S. NORMANDIN	ENGINEER: NV5		O SONAL ENGINEER		CONSTRUCTION PLANS	SHEET NO.:
/. DATE	DESCRIPTION REVISIONS	SHEET. NO.		APPROVED BY:	DATE: JUNE 3, 202	7//////////////////////////////////////		WATER STREET-1	24

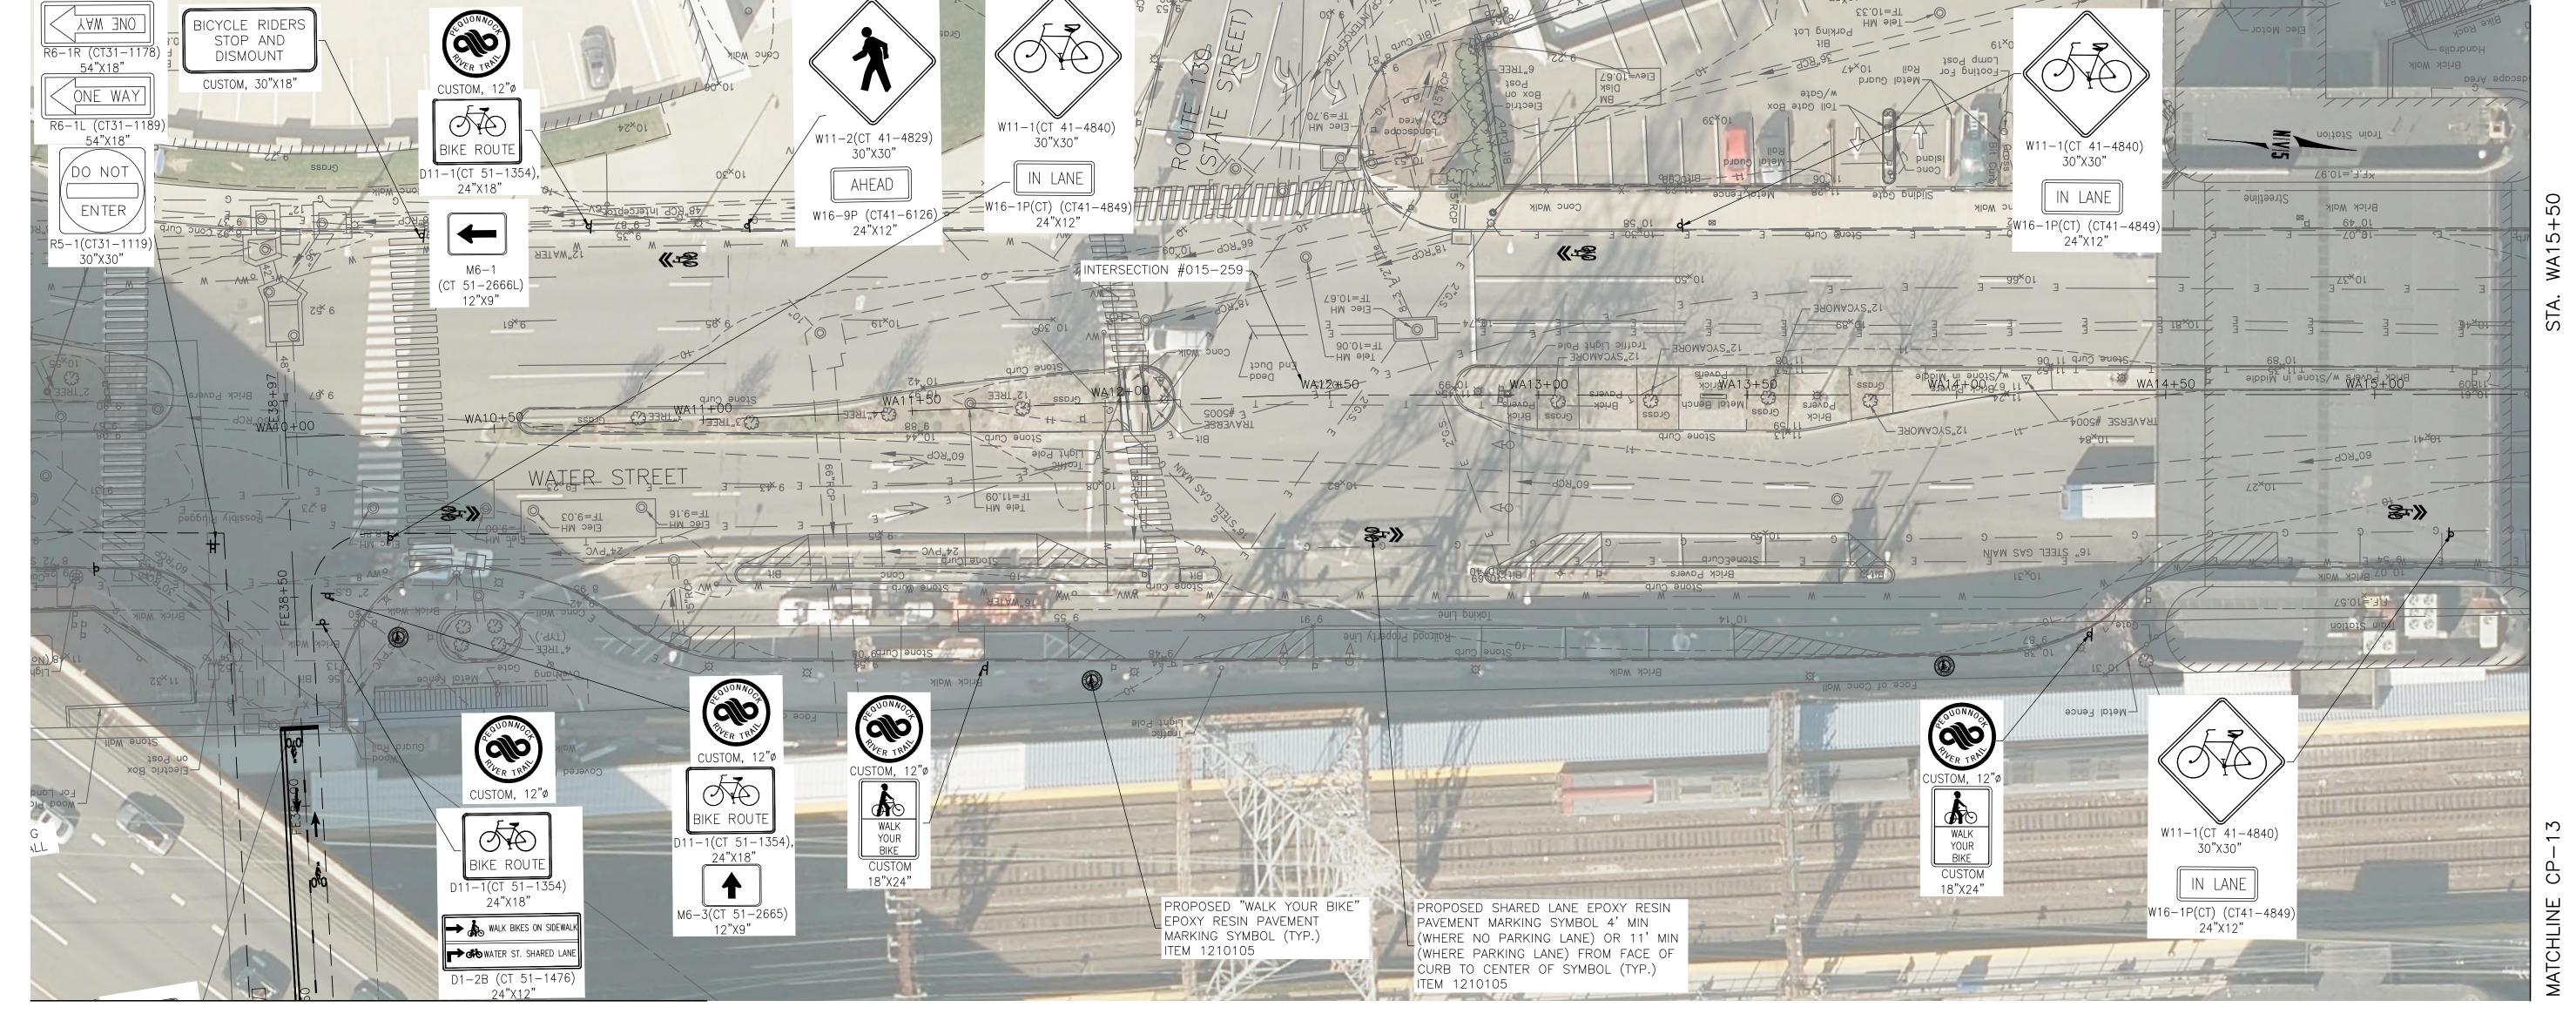

SEE CP-11


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LEGEND:


SIGN LOCATION #

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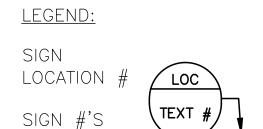


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"OPTION 1" AS SHOWN ON SHEET NO. 24-1 AND 25-1.

DESIGNER: M. BORST DOT PROJ: 15-374 CITY OF BRIDGEPORT CITY OF BRIDGEPORT PEQUONNOCK RIVER TRAIL DRAFTER: M. BORST DRAWING NO.: **EXTENSION** CP-12-1 DRAWING TITLE: CONSTRUCTION PLANS CHECKED BY: S. NORMANDIN **ENGINEER: NV5** SHEET NO.: REV. DATE DESCRIPTION SHEET. NO. 24-1 WATER STREET-1 - OPTION 1 APPROVED BY: DATE: JUNE 3, 2020 REVISIONS

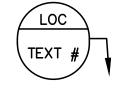

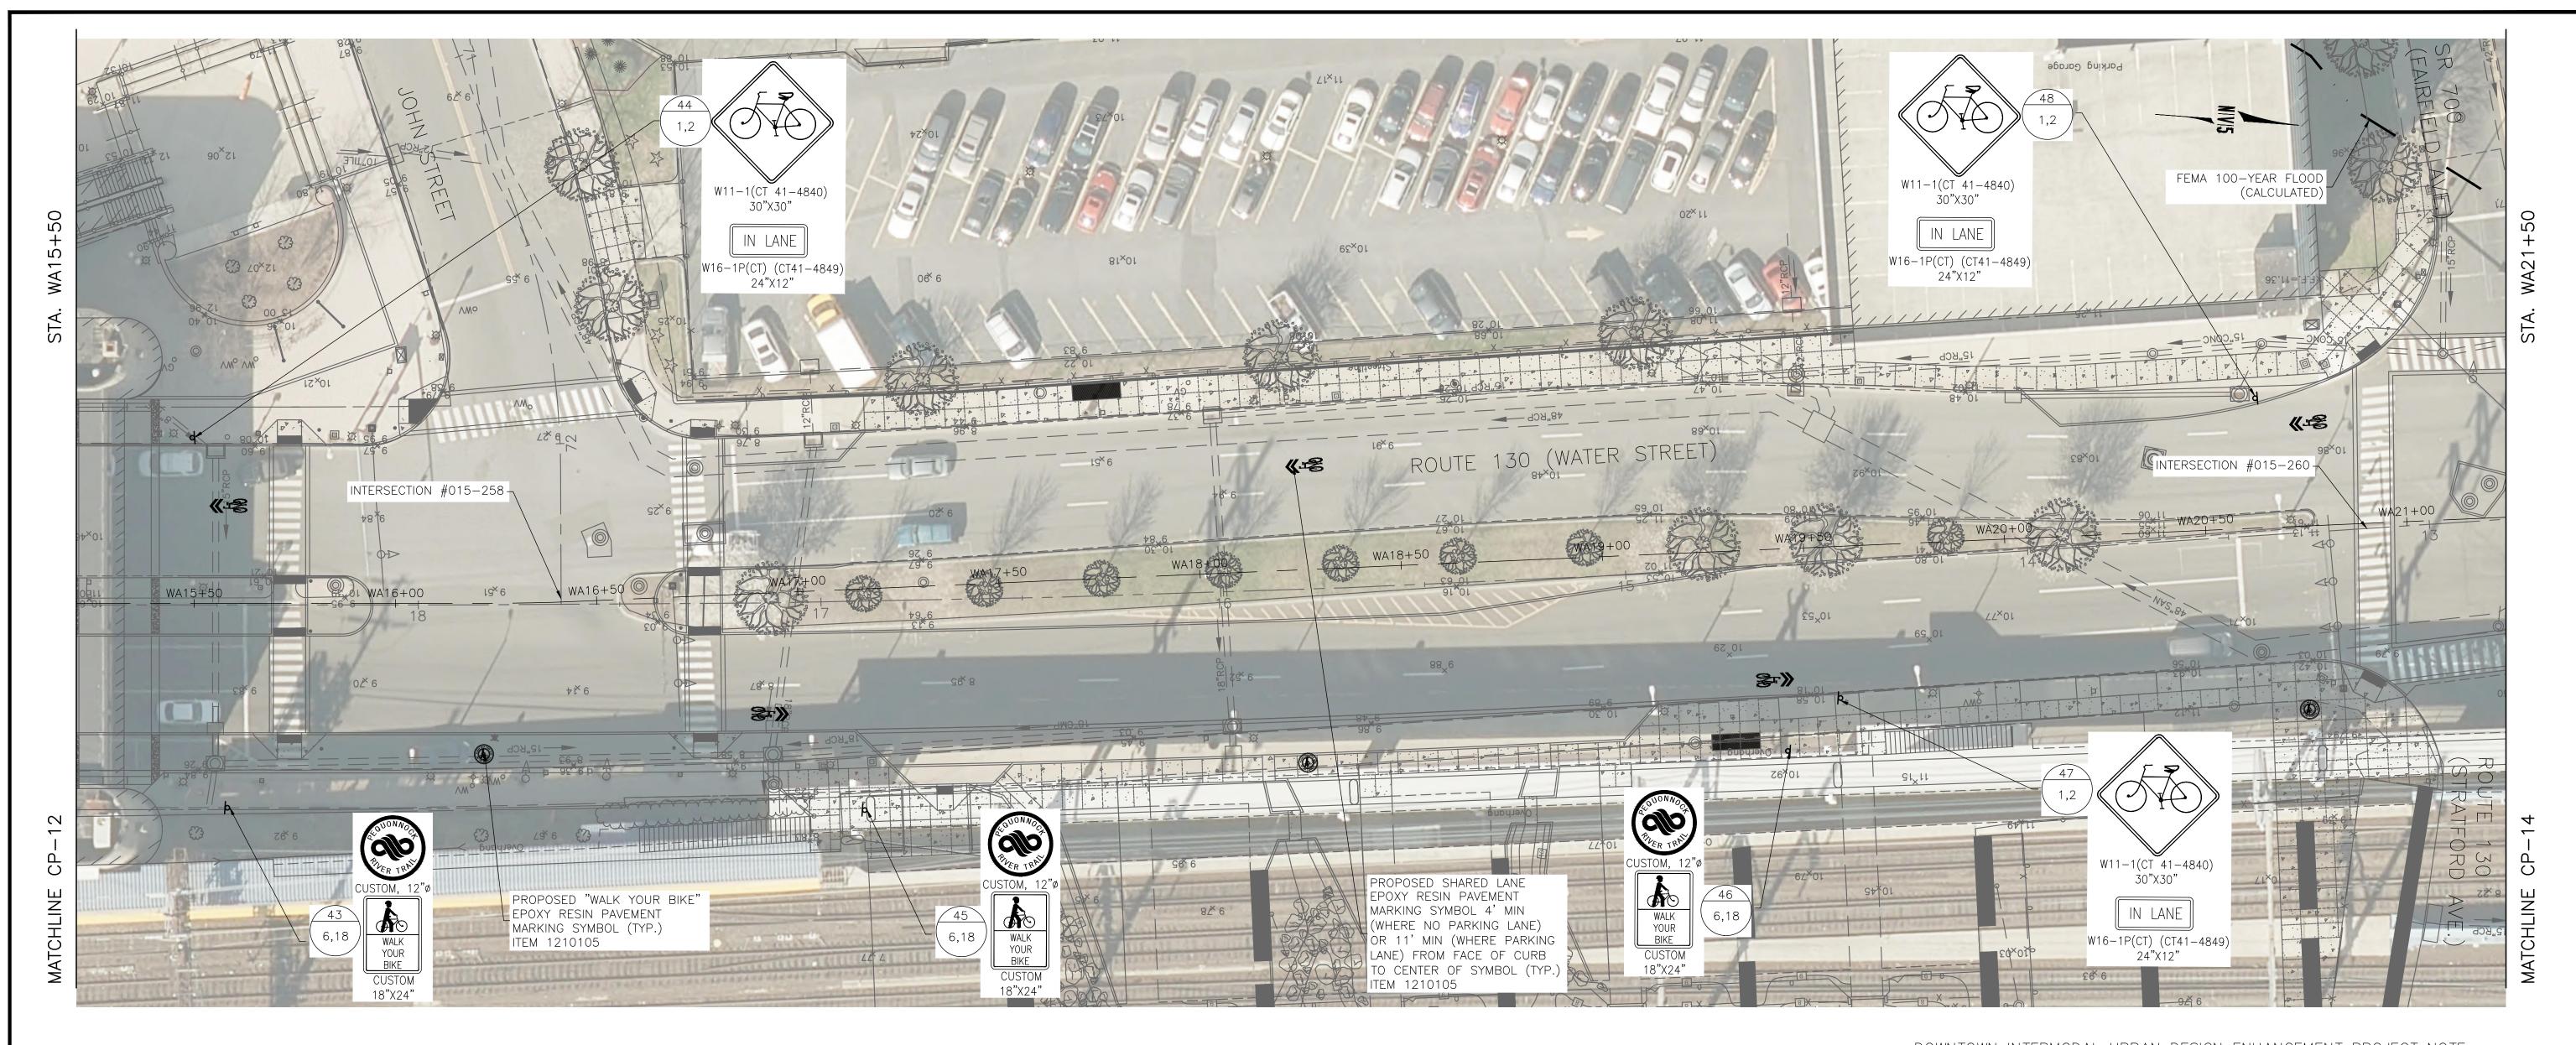- 1. FINAL PAVEMENT MARKINGS TO BE EPOXY RESIN UNLESS OTHERWISE NOTED.
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REV.	DATE	DESCRIPTION	SHEET. NO.
	•	REVISIONS	

DESIGNER: M. BORST

DRAFTER: M. BORST

CHECKED BY: S. NORMANDIN

ENGINEER: NV5

APPROVED BY:

CITY OF BRIDGEPORT



PEQUONNOCK RIVER TRAIL EXTENSION

CITY OF BRIDGEPORT

DRAWING TITLE:

CONSTRUCTION PLANS

WATER STREET-2


DRAWING NO.:

CP-13


SHEET NO.:

25


DOT PROJ: 15-374

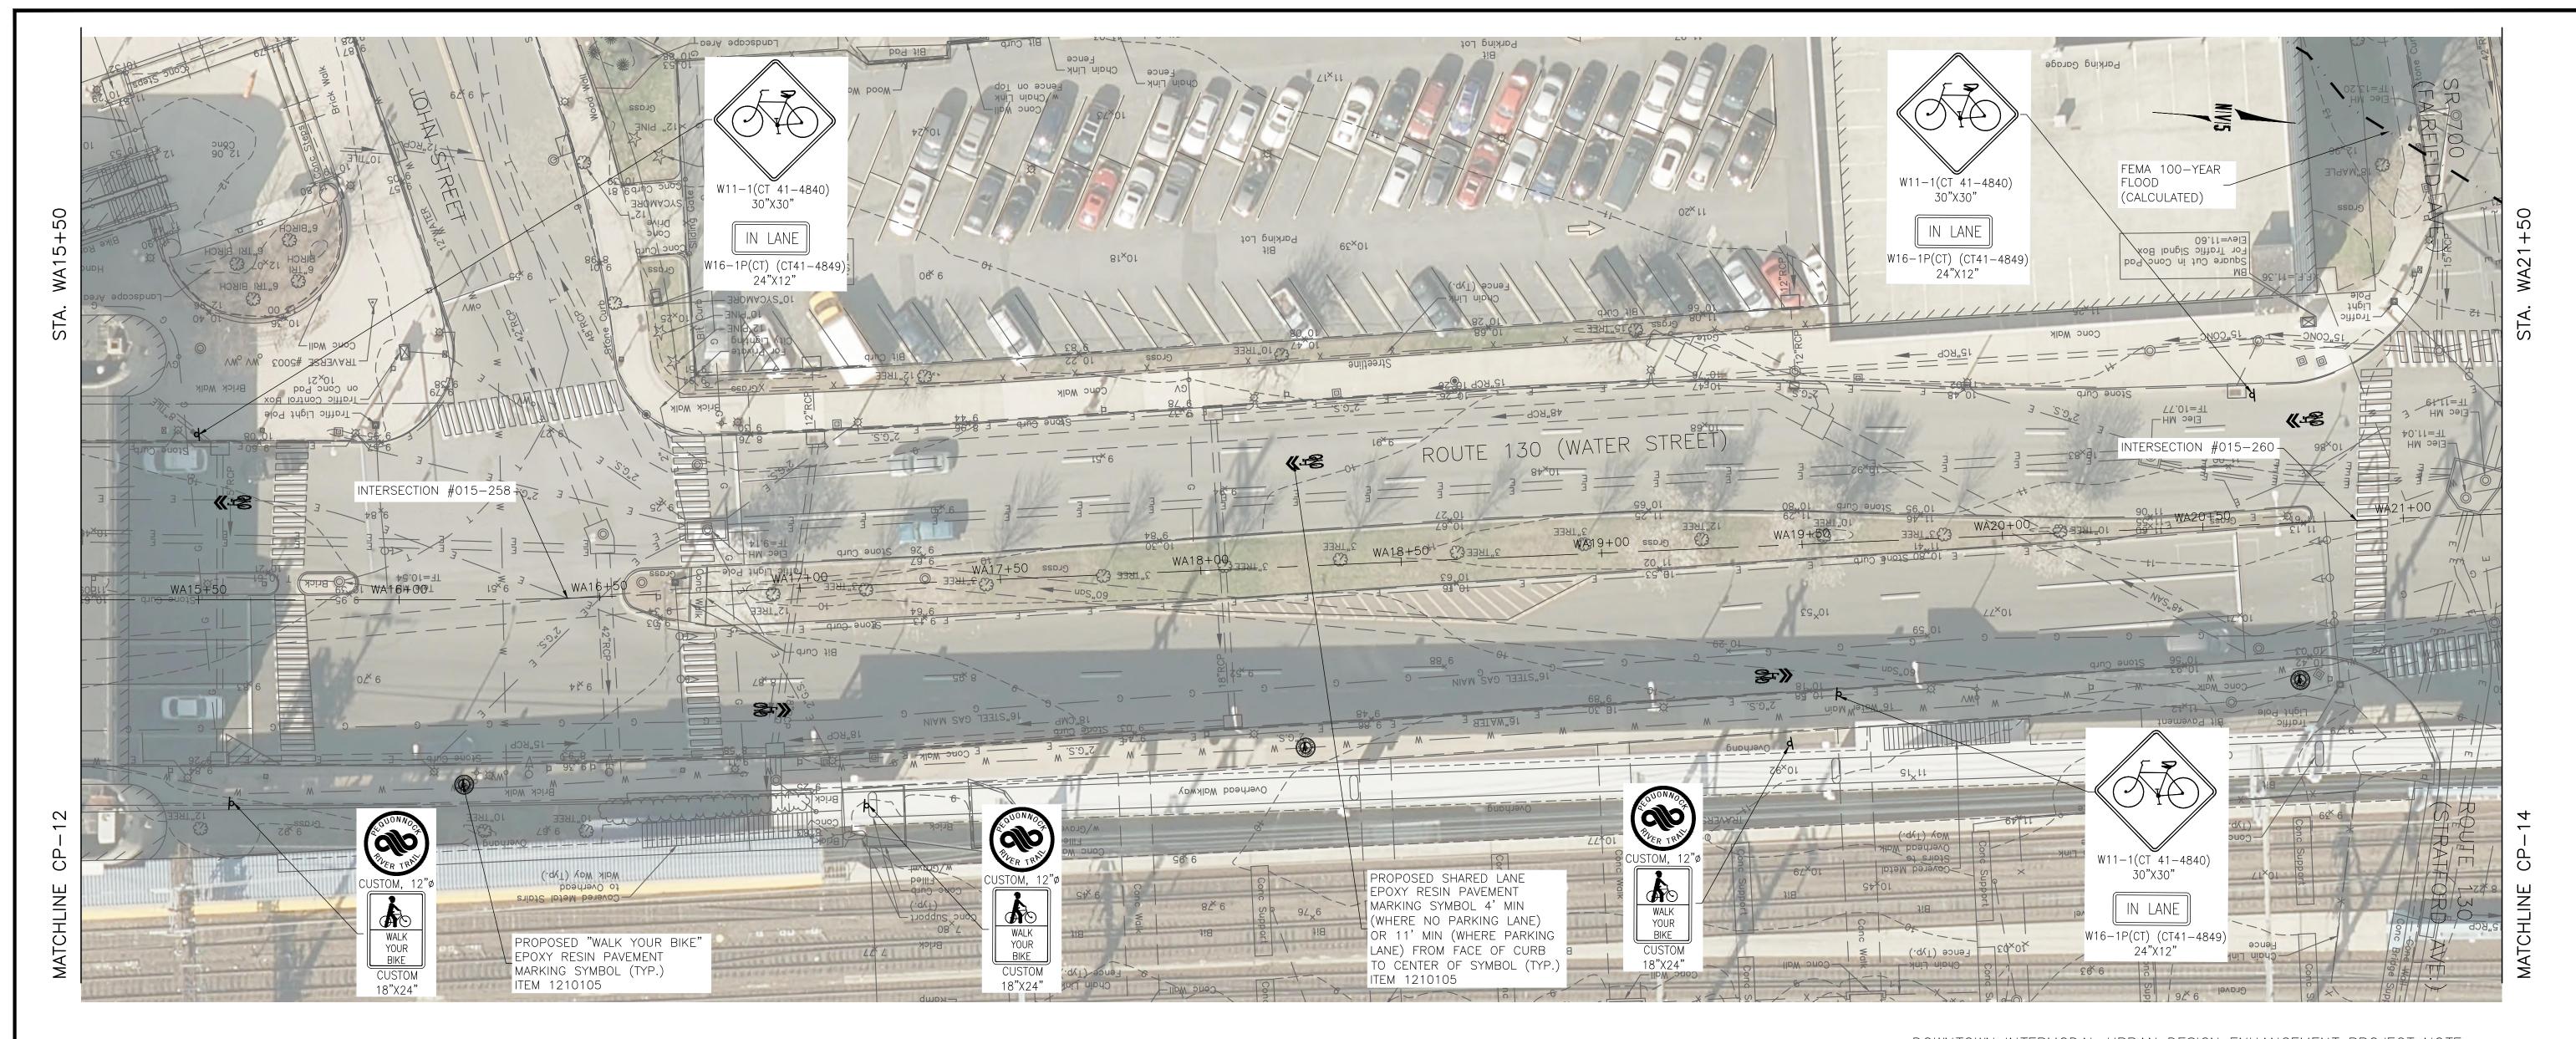

- 1. FINAL PAVEMENT MARKINGS TO BE EPOXY RESIN UNLESS OTHERWISE NOTED.
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- 8. THE STATE WILL MAINTAIN ALL SIGNS AND PAVEMENT MARKINGS, EXCEPT BIKE SIGNS AND SHARROW PAVEMENT MARKINGS, ON ROUTE 130 (THE STATE STREET SECTION), SR 700, AND ROUTE 1 (AS WELL AS STOP BARS ON NOBLE AVENUE AND CONCORD STREET ON ROUTE 1). CITY IS TO MAINTAIN ALL BICYCLE SIGNING, ALL SHARROW MARKINGS, AND ALL SIGNS AND PAVEMENT MARKINGS ON ROUTE 130 (THE WATER STREET SECTION).

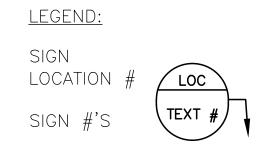


DOWNTOWN INTERMODAL URBAN DESIGN ENHANCEMENT PROJECT NOTE: THE CONTRACTOR IS ADVISED THE DOWNTOWN INTERMODAL URBAN DESIGN ENHANCEMENT PROJECT - WATER STREET (ROUTE 130) MAY BE COMPLETED. UNDER CONSTRUCTION, OR NOT YET STARTED WHEN THE PEQUONNOCK RIVER TRAIL CONTRACT BEGINS. THE CONTRACTOR SHALL COORDINATE HIS ACTIVITIES WITH THE CITY AND THE DOWNTOWN INTERMODAL URBAN DESIGN ENHANCEMENT PROJECT AT NO ADDITIONAL COST. IN THE EVENT THE INTERMODAL PROJECT HAS NOT BEEN COMPLETED, THE CONTRACTOR UPON WRITTEN DIRECTION FROM THE CITY, SHALL PROCEED WITH WATER STREET "OPTION 1" AS SHOWN ON SHEET NO. 24-1 AND 25-1.

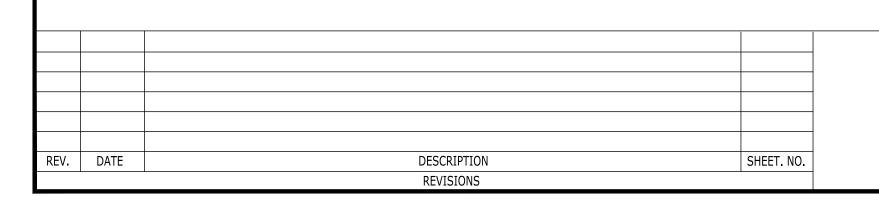

DESIGNER: M. BORST CITY OF BRIDGEPORT DRAFTER: M. BORST CHECKED BY: S. NORMANDIN **ENGINEER: NV5**

APPROVED BY:

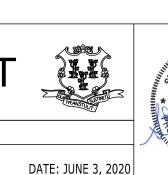

PEQUONNOCK RIVER TRAIL **EXTENSION**


CITY OF BRIDGEPORT

DRAWING TITLE: CONSTRUCTION PLANS

CP-13-1 SHEET NO.: 25-1 WATER STREET-2 - OPTION 1

DOT PROJ: 15-374

DRAWING NO.:

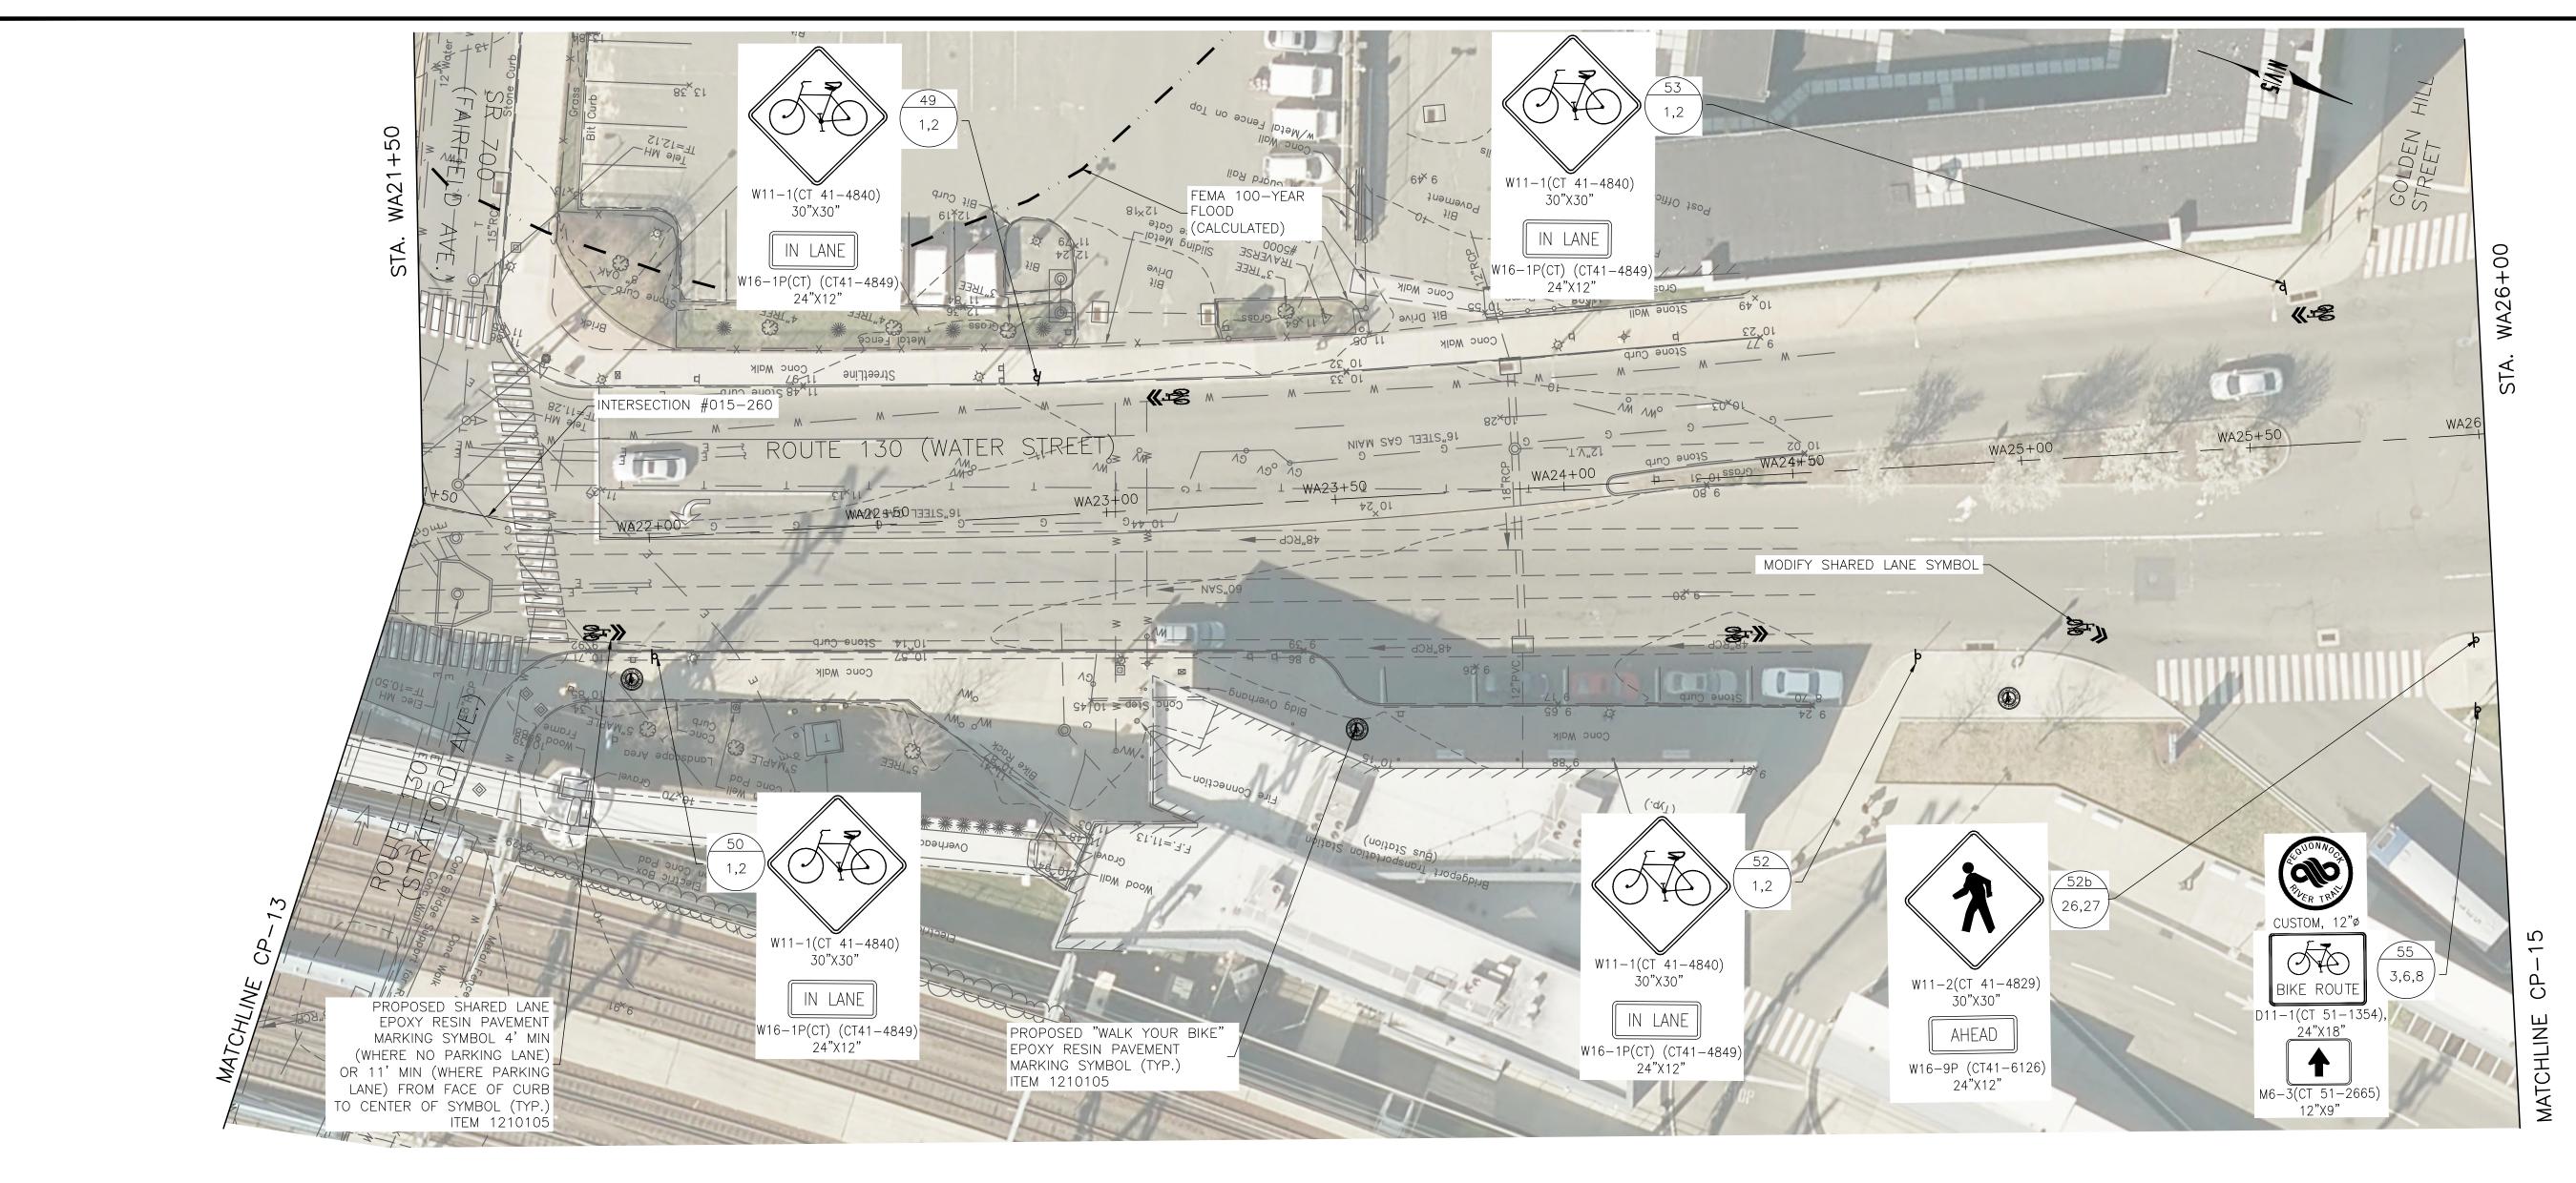

- 1. FINAL PAVEMENT MARKINGS TO BE EPOXY RESIN UNLESS OTHERWISE NOTED.
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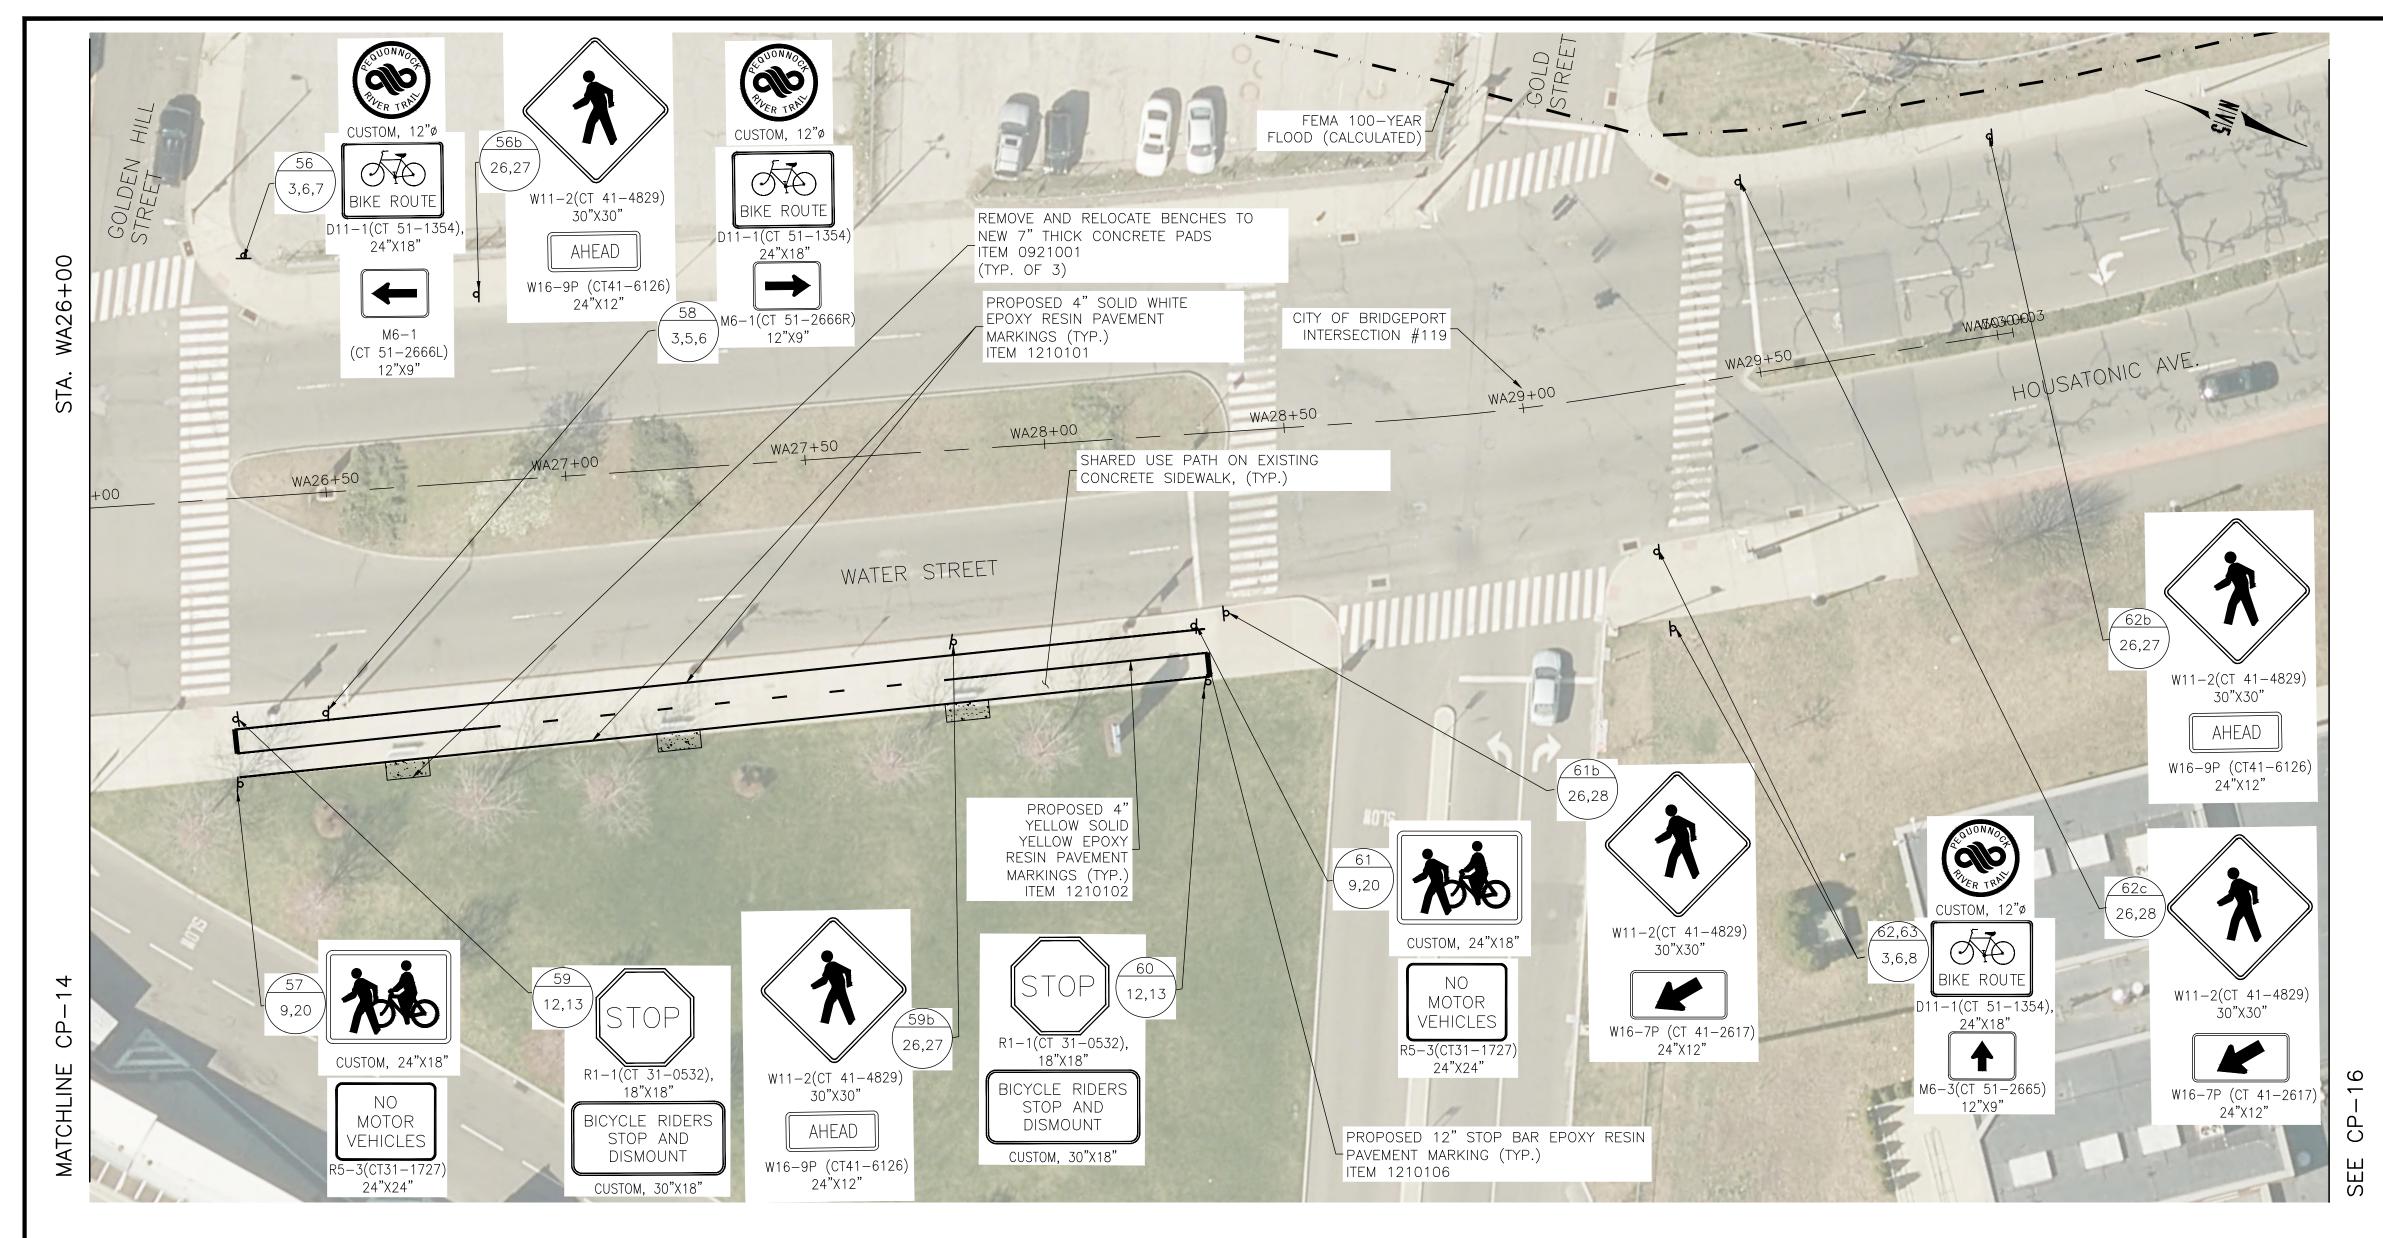
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LEGEND:

SIGN LOCATION #



		l I		N BRIDGE					SCALE: 1"=20'
			DESIGNER: M. BORST			WHITE OF CONNECTION	PEQUONNOCK RIVER TRAIL	CITY OF BRIDGEPORT	DOT PROJ: 15-374
			DRAFTER: M. BORST	CITY OF E	BRIDGEPORT	TEN STATE OF THE S	EXTENSION		DRAWING NO.:
			CHECKED BY: S. NORMANDIN	ENGINEER: NV5		No. 22220	LXTENOION	CONSTRUCTION PLANS	CP-14 SHEET NO.:
EV. DATE	DESCRIPTION REVISIONS	SHEET. NO.		APPROVED BY:	DATE: JUNE 3, 2020)		WATER STREET-3	26



APPROVED BY:

NOTES:

REV. DATE

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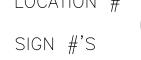
DESCRIPTION

REVISIONS

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LEGEND:

SIGN LOCATION #




DESIGNER: M. BORST

DRAFTER: M. BORST

CHECKED BY: S. NORMANDIN ENGINEER: NV5

SHEET. NO.

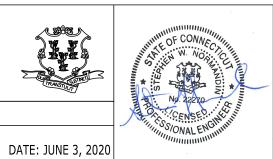

PROJECT TITLE:

PEQUONNOCK RIVER TRAIL

EXTENSION

CITY OF BRIDGEPORT

CONSTRUCTION PLANS
WATER STREET-4


DRAWING NO.:

CP-15

SHEET NO.:

27


DOT PROJ: 15-374

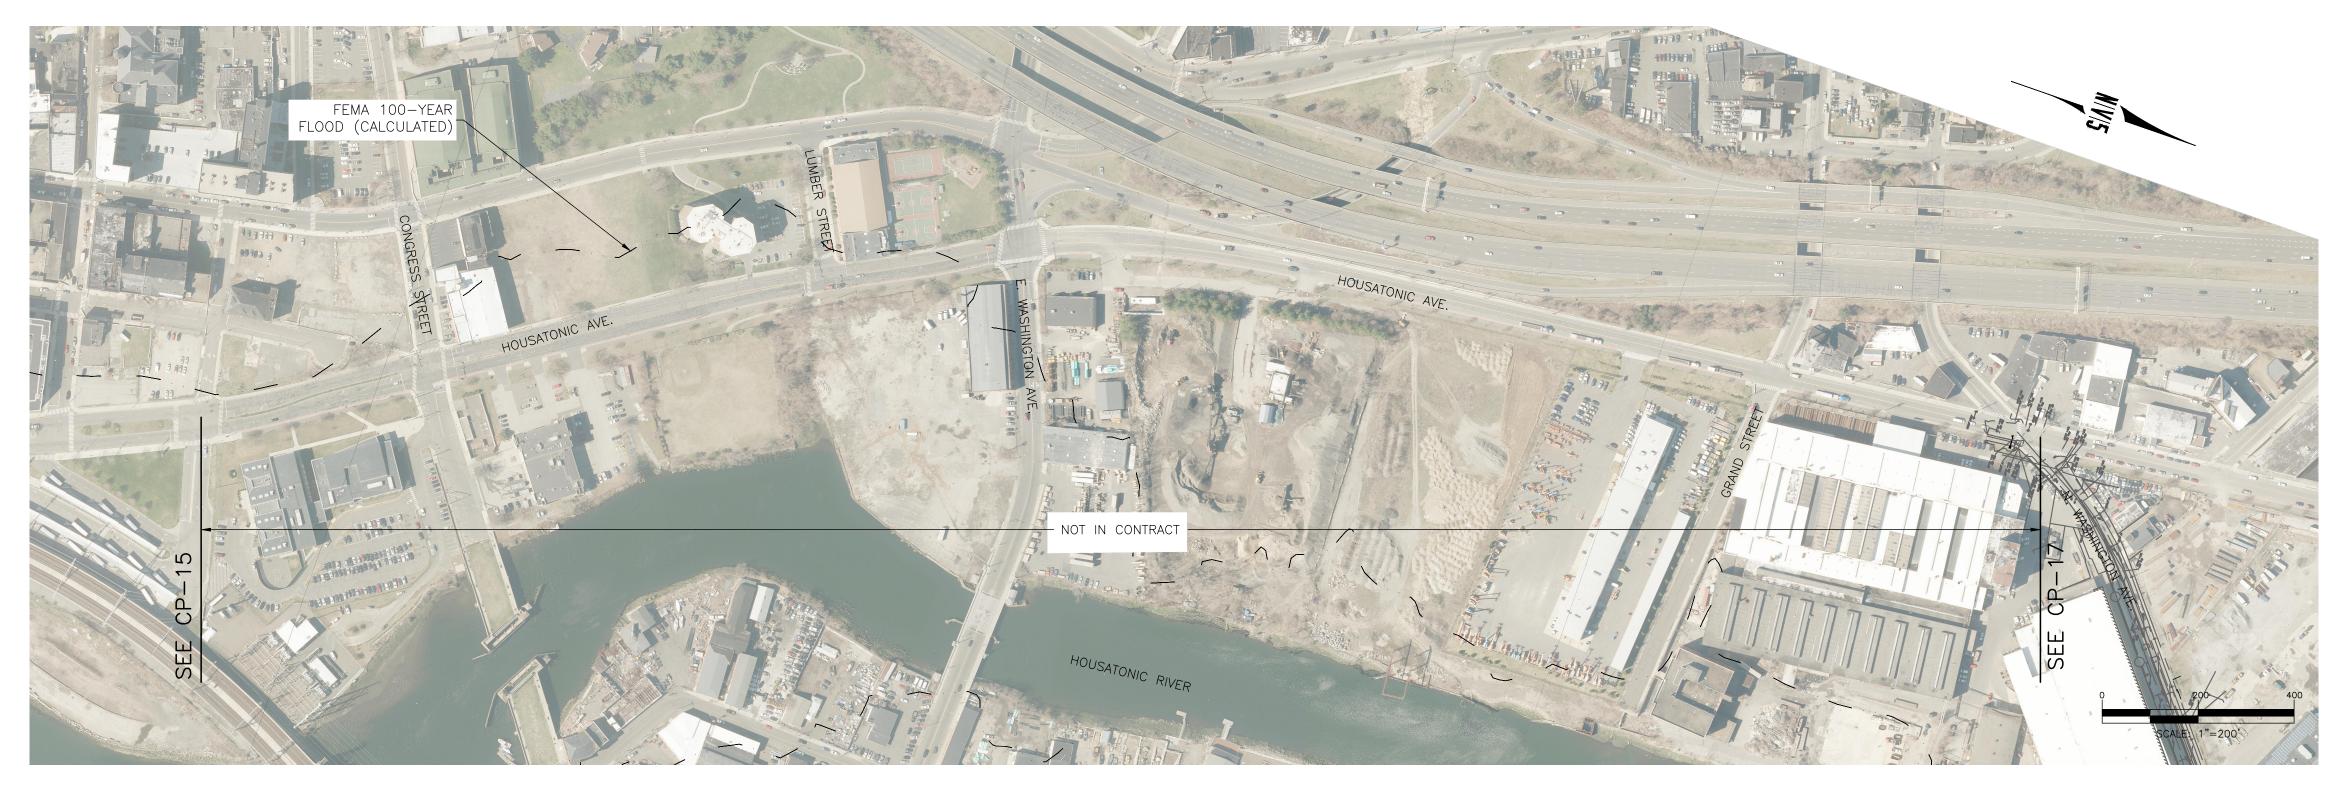

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<u>LEGEND:</u>

LOCATION #

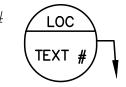

REV.	DATE	DESCRIPTION	SHEET. NO.	
		REVISIONS		




APPROVED BY:

DESIGNER: M. BORST

DRAFTER: M. BORST

CITY OF BRIDGEPORT

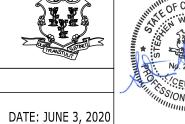




TOWN:	
	CITY OF BRIDGEPORT

CONSTRUCTION PLANS

HOUSATONIC AVENUE

DRAWING TITLE:

DOT PROJ: 15-374
DRAWING NO.:
CP-16
SHEET NO.:
28

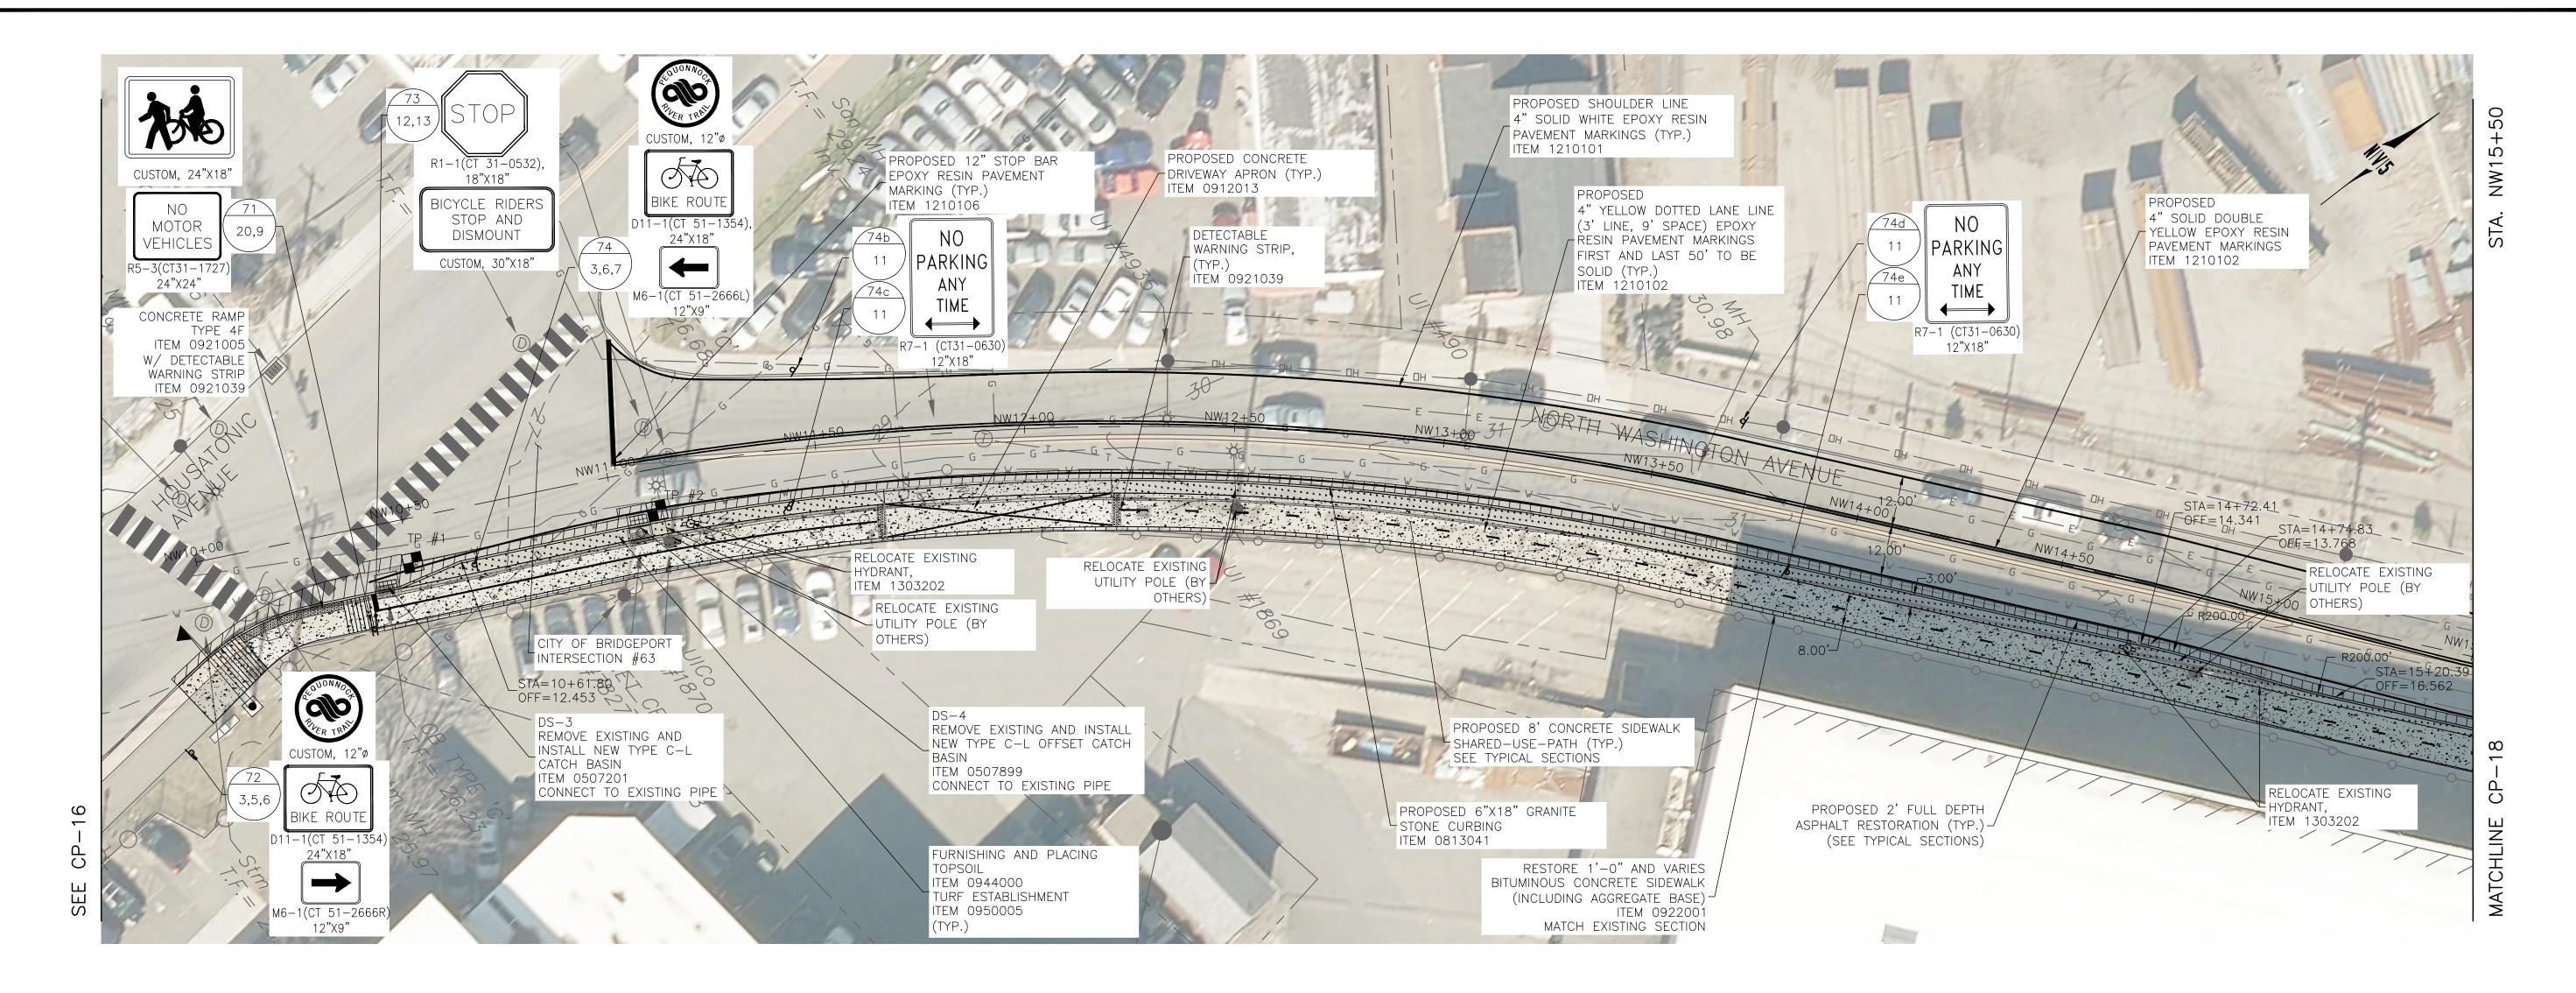


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LEGEND:

SIGN LOCATION #

SIGN #'S

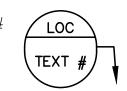

UTILITY TEST PIT DATA

TEST PIT#	STATION	OFFSET	NORTHING	EASTING	UTILITY	UTILITY SIZE (IN) AND TYPE	COVER (IN)	RELOCATION ANTICIPATED
1	10+50.50	10.50'R	630803.801	878115.8184	WATER MAIN	7.05" DIA. CAST IRON	21	NO
2	11+10.16	9.87'R	630857.2691	878141.6635	N/A	N/A	N/A	NO
3	19+15.13	7.09'R	631403.8863	878720.3902	WATER MAIN	9.55"DIA. CAST IRON	49	NO
4	22+40.83	9.02'R	631583.4987	878988.4861	WATER MAIN	7.05"DIA. CAST IRON	48"	NO
5	25+68.67	9.83'R	631735.1954	879279.1259	WATER MAIN	13.5" DIA. CAST IRON	60", 45"	NO
						18", 22" WIDE CONCRETE		
6	19+16.79	13.92'R	631399.6617	878726.0132	TELECOMM.	DUCTS	27", 52"	NO
						MULTIPLE 22" WIDE		
7	22+47.97	12.40'R	631583.8259	878996.3829	TELECOMM.	CONCRETE DUCTS	26"	NO
8	25+68.67	12.50'R	631732.8327	879280.3626	TELECOMM.	20" WIDE CONCRETE DUCT	38"	NO
9	28+46.48	12.50' R	631865.0849	879527.2691	TELECOMM.	18" WIDE CONCRETE DUCT	23"	NO

REV. DATE DESCRIPTION SHEET. NO. REVISIONS

DESIGNER: M. BORST


DRAFTER: M. BORST

CHECKED BY: S. NORMANDIN

ENGINEER: NV5

APPROVED BY:

CITY OF BRIDGEPORT

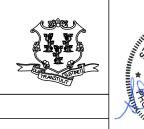

DATE: JUNE 3, 2020

PEQUONNOCK RIVER TRAIL EXTENSION

CITY OF BRIDGEPORT

DRAWING TITLE:

CONSTRUCTION PLANS

NORTH WASHINGTON AVENUE-1


DOT PROJ: 15-374

DRAWING NO.:

CP-17

SHEET NO.:
29

SCALE: 1"=20'

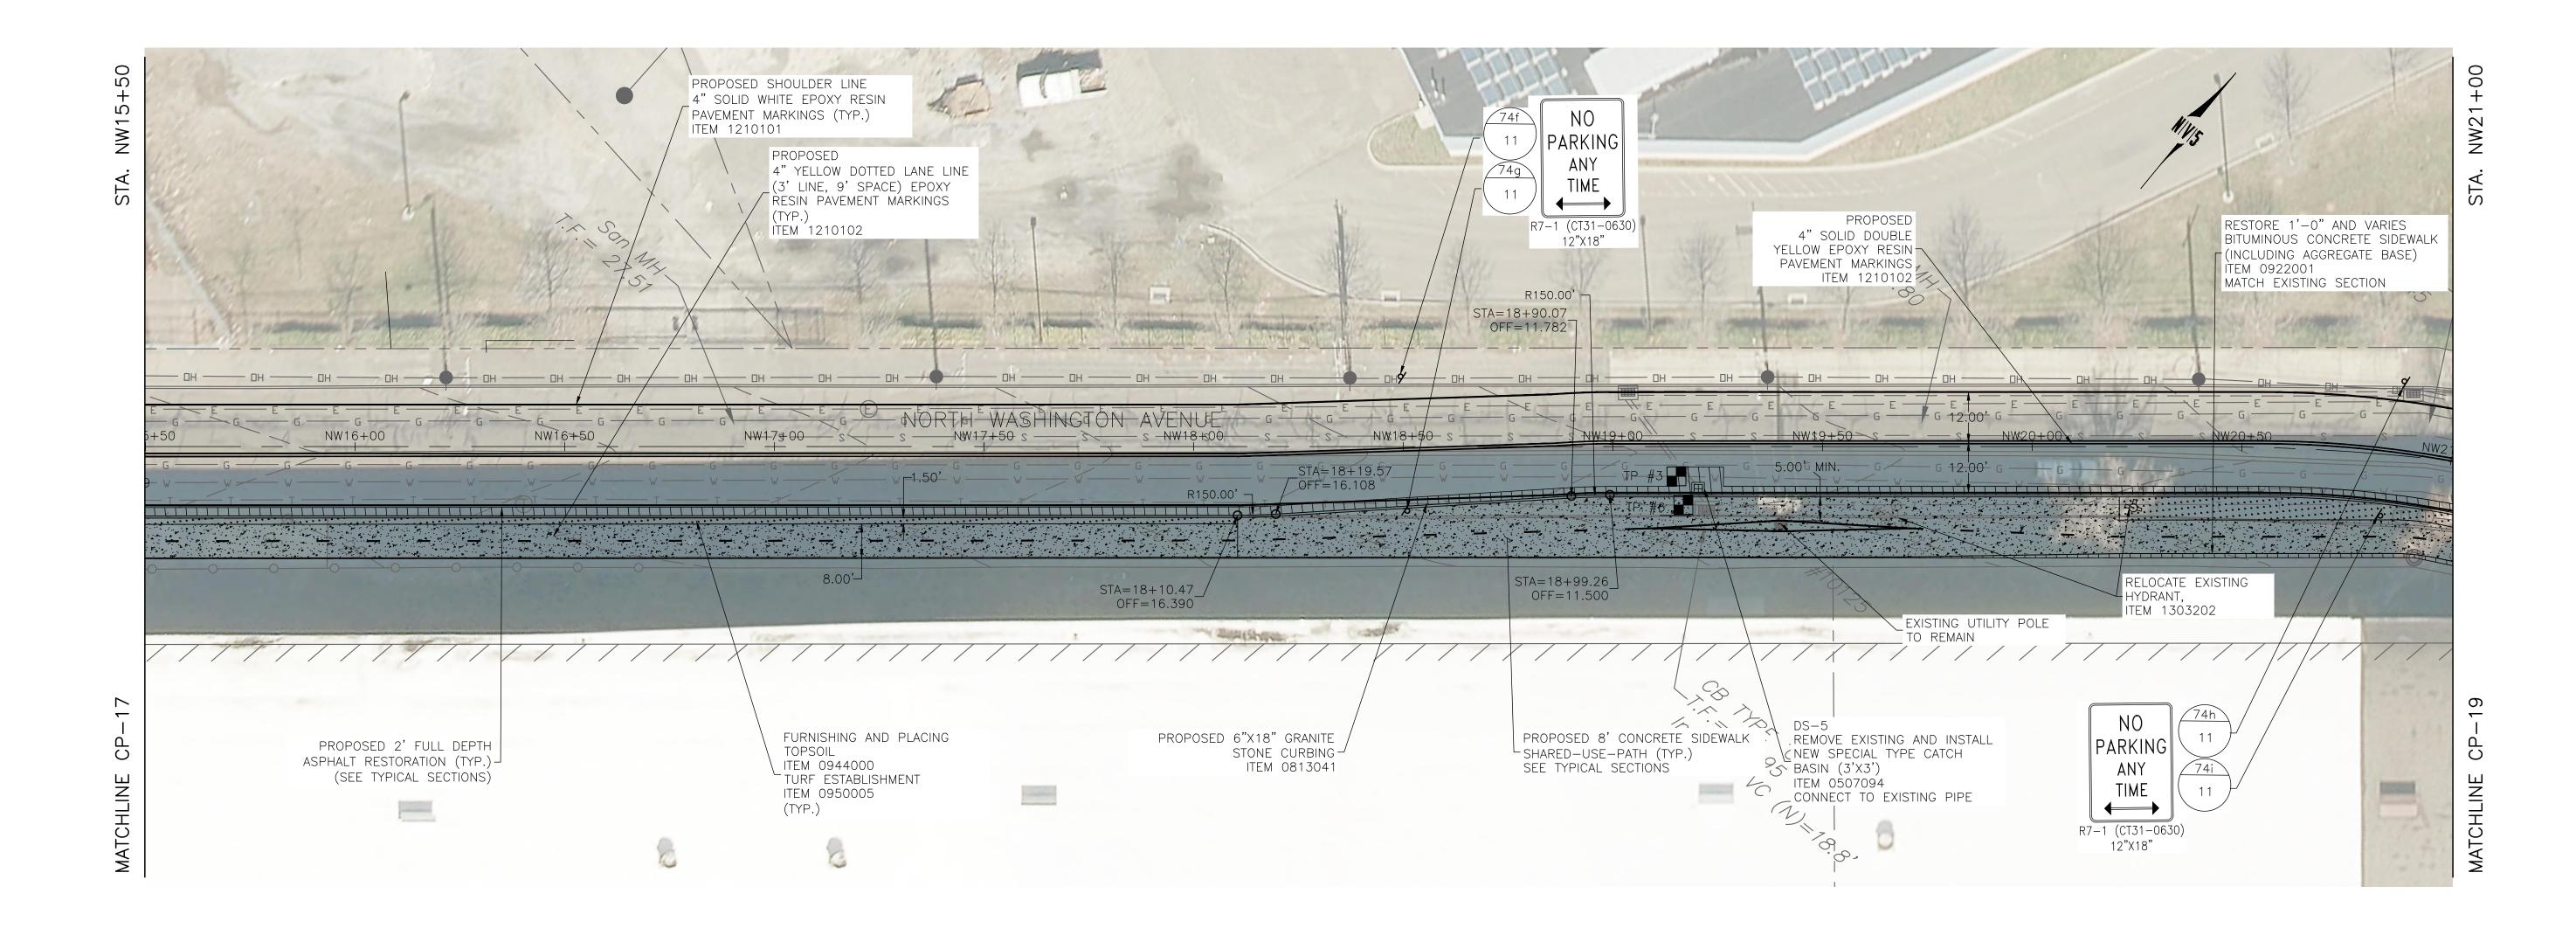


- 1. FINAL PAVEMENT MARKINGS TO BE EPOXY RESIN UNLESS OTHERWISE NOTED.
- 2. THE CONTRACTOR SHALL REMOVE ANY CONFLICTING EXISTING PAVEMENT MARKINGS WITHIN THE PAVEMENT MARKING LIMITS. THIS WORK SHALL BE PAID UNDER ITEM NO. 1211001-REMOVAL OF PAVEMENT MARKINGS. ALL OTHER EXISTING PAVEMENT MARKINGS TO REMAIN.
- 3. SIGNS SHALL BE INSTALLED PER CONNDOT STANDARD SHEETS "SIGN PLACEMENT AND RETROREFLECTIVE STRIP DETAILS" AND "METAL SIGN POSTS AND SIGN MOUNTING DETAILS" UNLESS OTHERWISE NOTED.
- 4. ALL EXISTING SIGNS WITHIN THE LIMITS OF SIGNING ARE TO REMAIN UNLESS OTHERWISE NOTED OR DIRECTED BY THE ENGINEER. THE CONTRACTOR SHALL REMOVE ANY EXISTING SIGNS CONFLICTING WITH PROPOSED SIGNS WITHIN THE LIMITS OF SIGNING.
- 5. "NO PARKING SIGNS" SHALL BE INSTALLED AT AN ANGLE BETWEEN 30° AND 45° FROM THE ADJACENT TRAVELWAY.
- 6. SIGNS SHOULD BE INSTALLED AT LEAST 10' FROM ALL UTILITY POLES.
- 7. EXACT LOCATIONS OF THE SIGNS TO BE VERIFIED BY THE ENGINEER.
- 8. THE STATE WILL MAINTAIN ALL SIGNS AND PAVEMENT MARKINGS, EXCEPT BIKE SIGNS AND SHARROW PAVEMENT MARKINGS, ON ROUTE 130 (THE STATE STREET SECTION), SR 700, AND ROUTE 1 (AS WELL AS STOP BARS ON NOBLE AVENUE AND CONCORD STREET ON ROUTE 1). CITY IS TO MAINTAIN ALL BICYCLE SIGNING, ALL SHARROW MARKINGS, AND ALL SIGNS AND PAVEMENT MARKINGS ON ROUTE 130 (THE WATER STREET SECTION).

<u>LEGEND:</u>

SIGN LOCATION #

SIGN #'S

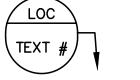

UTILITY TEST PIT DATA

TEST PIT#	STATION	OFFSET	NORTHING	EASTING	UTILITY	UTILITY SIZE (IN) AND TYPE	COVER (IN)	RELOCATION ANTICIPATED
1	10+50.50	10.50'R	630803.801	878115.8184	WATER MAIN	7.05" DIA. CAST IRON	21	NO
2	11+10.16	9.87'R	630857.2691	878141.6635	N/A	N/A	N/A	NO
3	19+15.13	7.09'R	631403.8863	878720.3902	WATER MAIN	9.55"DIA. CAST IRON	49	NO
4	22+40.83	9.02'R	631583.4987	878988.4861	WATER MAIN	7.05"DIA. CAST IRON	48"	NO
5	25+68.67	9.83'R	631735.1954	879279.1259	WATER MAIN	13.5" DIA. CAST IRON	60", 45"	NO
						18", 22" WIDE CONCRETE		
6	19+16.79	13.92'R	631399.6617	878726.0132	TELECOMM.	DUCTS	27", 52"	NO
						MULTIPLE 22" WIDE		
7	22+47.97	12.40'R	631583.8259	878996.3829	TELECOMM.	CONCRETE DUCTS	26"	NO
8	25+68.67	12.50'R	631732.8327	879280.3626	TELECOMM.	20" WIDE CONCRETE DUCT	38"	NO
9	28+46.48	12.50' R	631865.0849	879527.2691	TELECOMM.	18" WIDE CONCRETE DUCT	23"	NO


30

REV. DATE DESCRIPTION SHEET. NO. REVISIONS

DESIGNER: M. BORST DRAFTER: M. BORST **ENGINEER: NV5** CHECKED BY: S. NORMANDIN

APPROVED BY:


CITY OF BRIDGEPORT

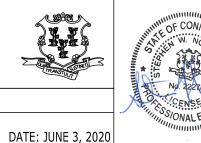

PEQUONNOCK RIVER TRAIL **EXTENSION**

DOT PROJ: 15-374 CITY OF BRIDGEPORT DRAWING NO.: CP-18 DRAWING TITLE: SHEET NO.:

CONSTRUCTION PLANS NORTH WASHINGTON AVENUE-2

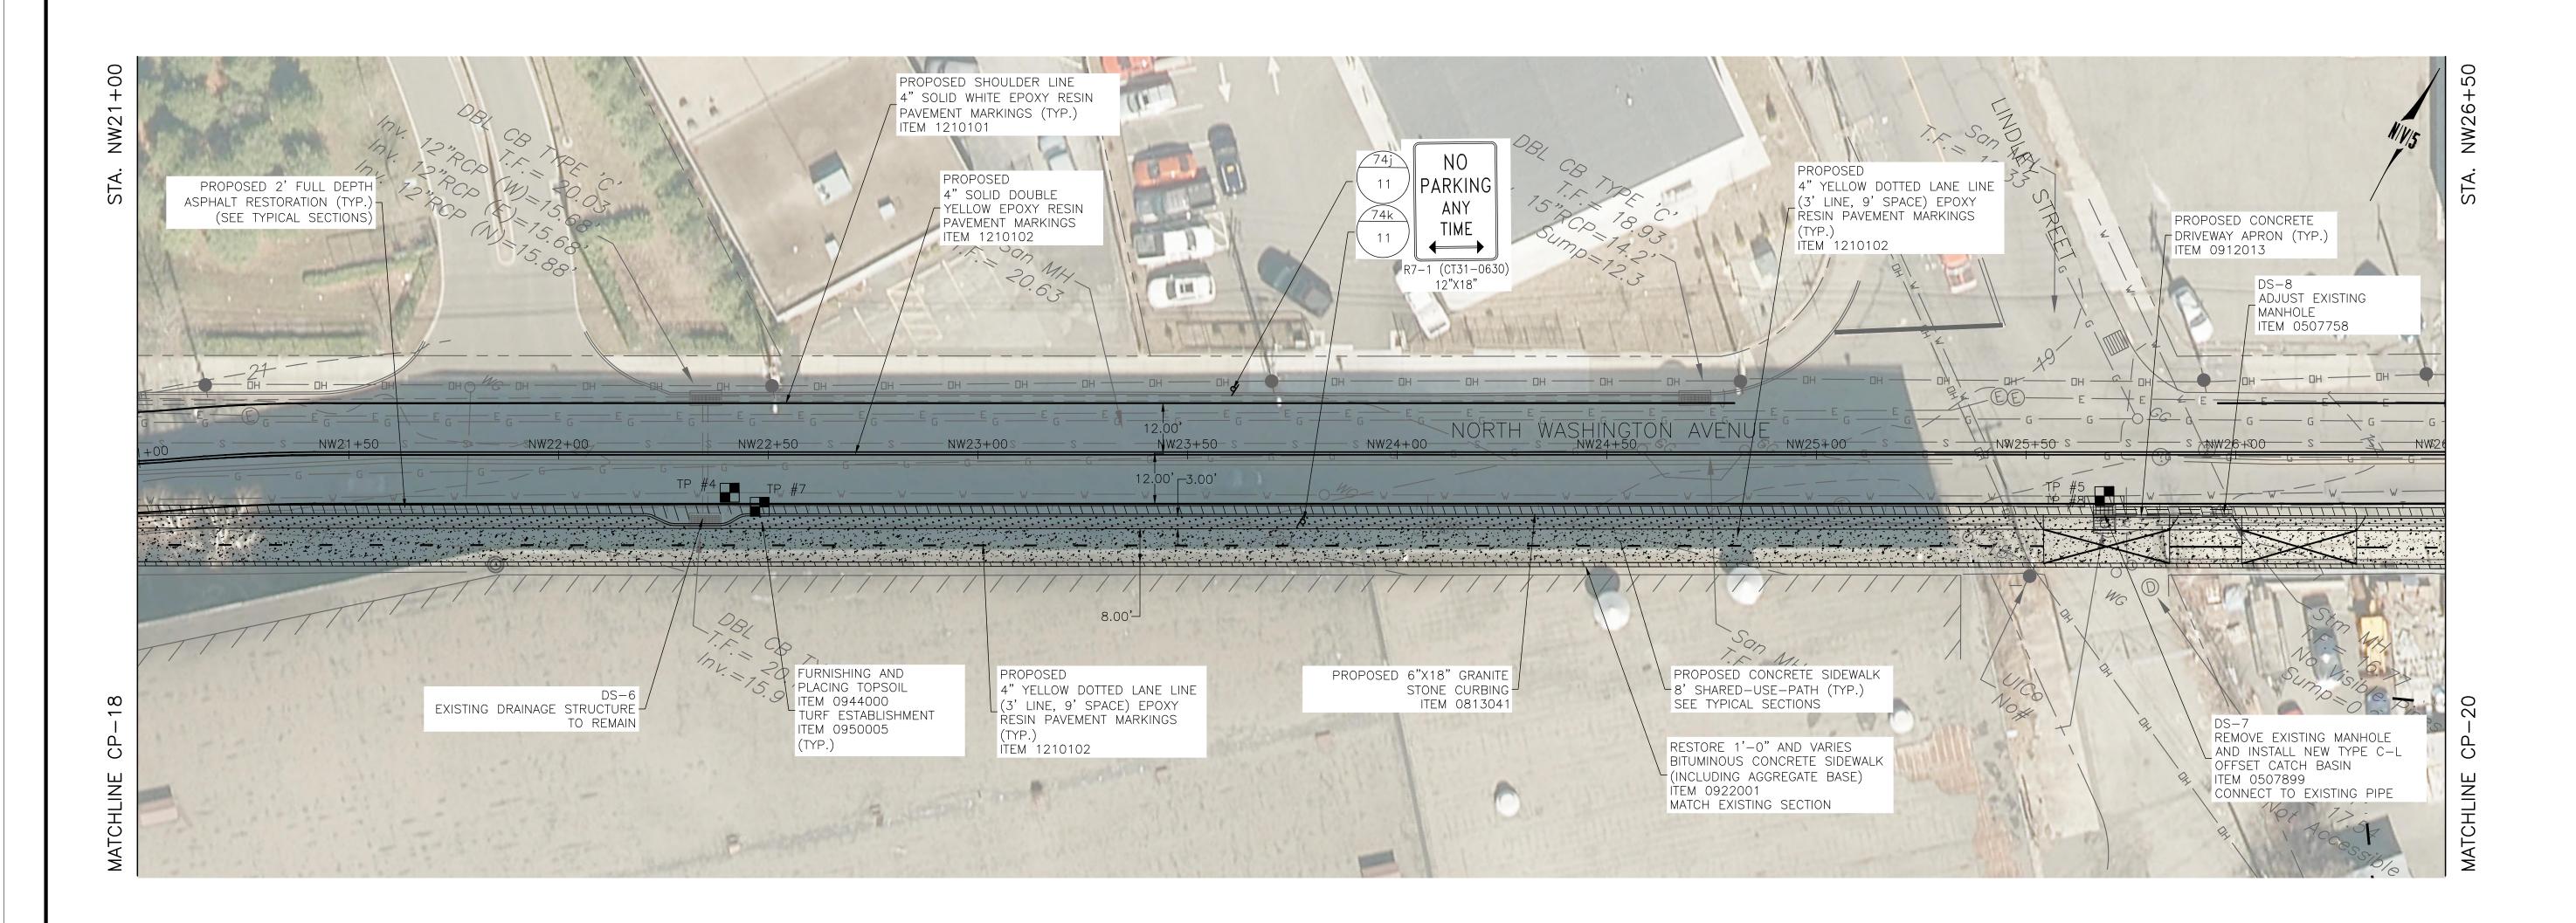

- 1. FINAL PAVEMENT MARKINGS TO BE EPOXY RESIN UNLESS OTHERWISE NOTED.
- 2. THE CONTRACTOR SHALL REMOVE ANY CONFLICTING EXISTING PAVEMENT MARKINGS WITHIN THE PAVEMENT MARKING LIMITS. THIS WORK SHALL BE PAID UNDER ITEM NO. 1211001-REMOVAL OF PAVEMENT MARKINGS. ALL OTHER EXISTING PAVEMENT MARKINGS TO REMAIN.
- 3. SIGNS SHALL BE INSTALLED PER CONNDOT STANDARD SHEETS "SIGN PLACEMENT AND RETROREFLECTIVE STRIP DETAILS" AND "METAL SIGN POSTS AND SIGN MOUNTING DETAILS" UNLESS OTHERWISE NOTED.
- 4. ALL EXISTING SIGNS WITHIN THE LIMITS OF SIGNING ARE TO REMAIN UNLESS OTHERWISE NOTED OR DIRECTED BY THE ENGINEER. THE CONTRACTOR SHALL REMOVE ANY EXISTING SIGNS CONFLICTING WITH PROPOSED SIGNS WITHIN THE LIMITS OF SIGNING.
- 5. "NO PARKING SIGNS" SHALL BE INSTALLED AT AN ANGLE BETWEEN 30° AND 45° FROM THE ADJACENT TRAVELWAY.
- 6. SIGNS SHOULD BE INSTALLED AT LEAST 10' FROM ALL UTILITY POLES.
- 7. EXACT LOCATIONS OF THE SIGNS TO BE VERIFIED BY THE ENGINEER.
- 8. THE STATE WILL MAINTAIN ALL SIGNS AND PAVEMENT MARKINGS, EXCEPT BIKE SIGNS AND SHARROW PAVEMENT MARKINGS, ON ROUTE 130 (THE STATE STREET SECTION), SR 700, AND ROUTE 1 (AS WELL AS STOP BARS ON NOBLE AVENUE AND CONCORD STREET ON ROUTE 1). CITY IS TO MAINTAIN ALL BICYCLE SIGNING, ALL SHARROW MARKINGS, AND ALL SIGNS AND PAVEMENT MARKINGS ON ROUTE 130 (THE WATER STREET SECTION).

LEGEND:

SIGN LOCATION #

SIGN #'S

UTILITY TEST PIT DATA


TEST PIT#	STATION	OFFSET	NORTHING	EASTING	UTILITY	UTILITY SIZE (IN) AND TYPE	COVER (IN)	RELOCATION ANTICIPATED
1	10+50.50	10.50'R	630803.801	878115.8184	WATER MAIN	7.05" DIA. CAST IRON	21	NO
2	11+10.16	9.87'R	630857.2691	878141.6635	N/A	N/A	N/A	NO
3	19+15.13	7.09'R	631403.8863	878720.3902	WATER MAIN	9.55"DIA. CAST IRON	49	NO
4	22+40.83	9.02'R	631583.4987	878988.4861	WATER MAIN	7.05"DIA. CAST IRON	48"	NO
5	25+68.67	9.83'R	631735.1954	879279.1259	WATER MAIN	13.5" DIA. CAST IRON	60", 45"	NO
						18", 22" WIDE CONCRETE		
6	19+16.79	13.92'R	631399.6617	878726.0132	TELECOMM.	DUCTS	27", 52"	NO
						MULTIPLE 22" WIDE		
7	22+47.97	12.40'R	631583.8259	878996.3829	TELECOMM.	CONCRETE DUCTS	26"	NO
8	25+68.67	12.50'R	631732.8327	879280.3626	TELECOMM.	20" WIDE CONCRETE DUCT	38"	NO
9	28+46.48	12.50' R	631865.0849	879527.2691	TELECOMM.	18" WIDE CONCRETE DUCT	23"	NO

REV. DATE DESCRIPTION SHEET. NO. REVISIONS

DESIGNER: M. BORST DRAFTER: M. BORST **ENGINEER: NV5** CHECKED BY: S. NORMANDIN

APPROVED BY:


CITY OF BRIDGEPORT

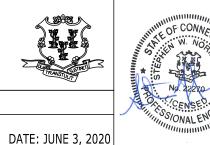



DOT PROJ: 15-374 CITY OF BRIDGEPORT DRAWING TITLE:

DRAWING NO.: CP-19 CONSTRUCTION PLANS SHEET NO.: 31 NORTH WASHINGTON AVENUE-3

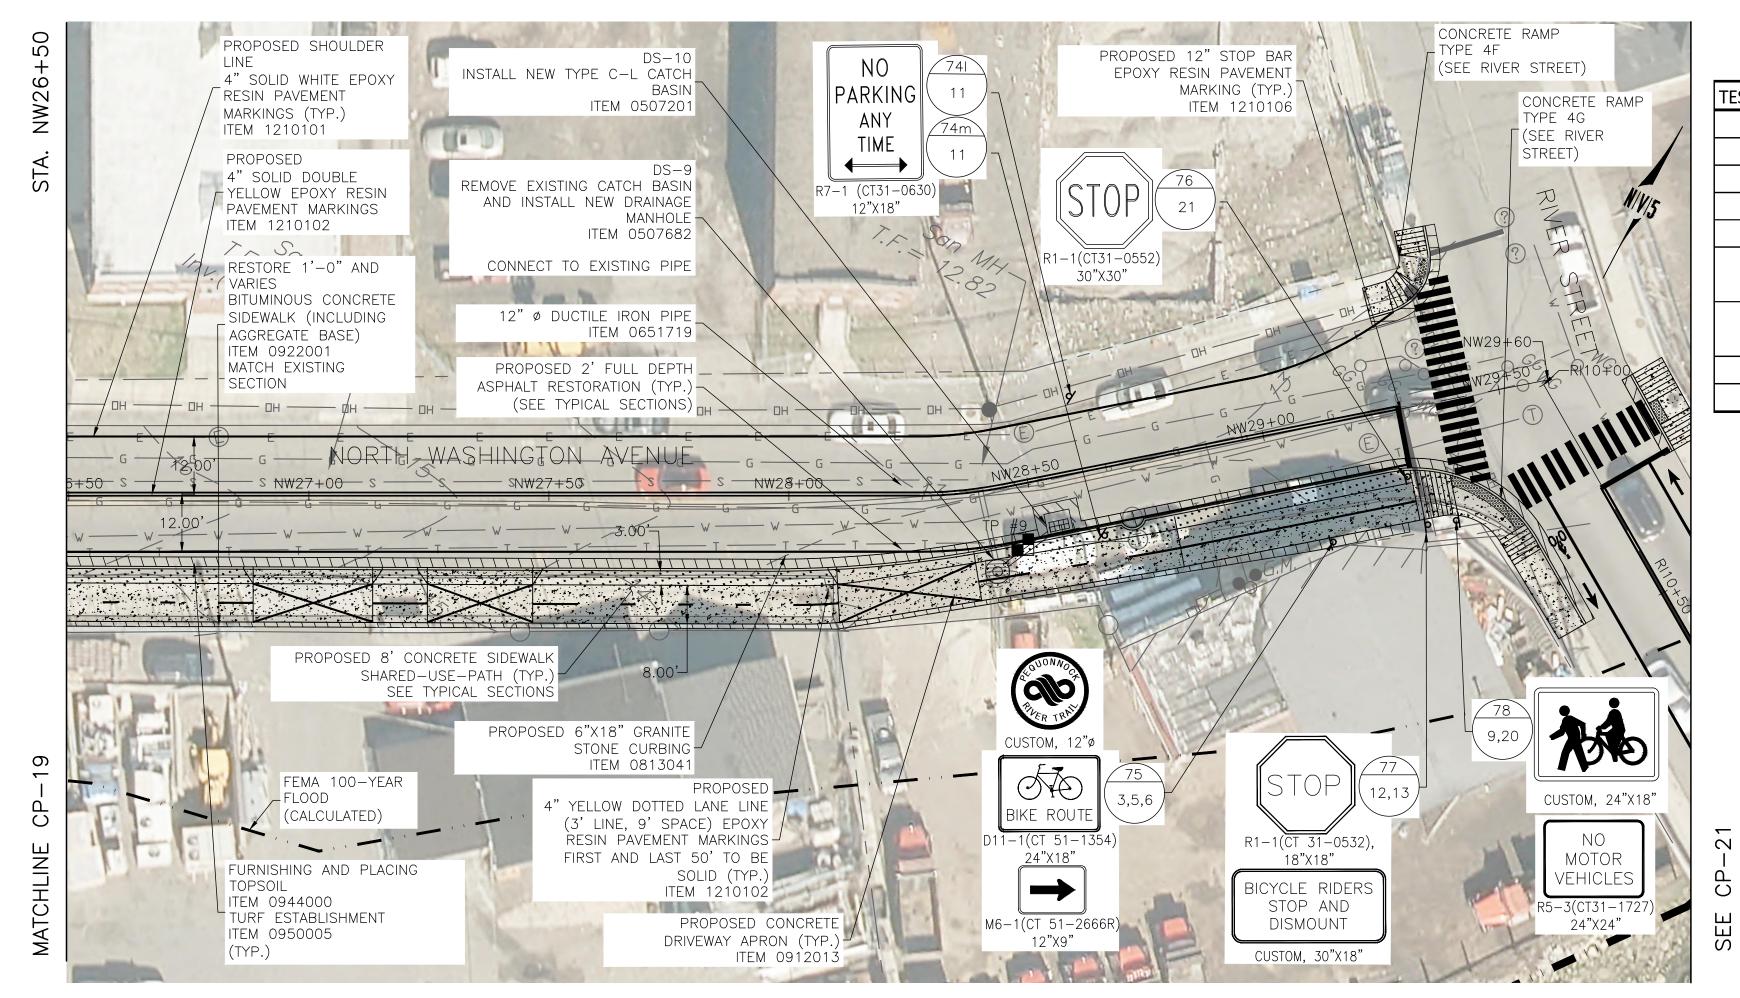

UTILITY TEST PIT DATA

TEST PIT#	STATION	OFFSET	NORTHING	EASTING	UTILITY	UTILITY SIZE (IN) AND TYPE	COVER (IN)	RELOCATION ANTICIPATED
1	10+50.50	10.50'R	630803.801	878115.8184	WATER MAIN	7.05" DIA. CAST IRON	21 NO	
2	11+10.16	9.87'R	630857.2691	878141.6635	N/A	N/A	N/A	NO
3	19+15.13	7.09'R	631403.8863	878720.3902	WATER MAIN	9.55"DIA. CAST IRON	49	NO
4	22+40.83	9.02'R	631583.4987	878988.4861	WATER MAIN	7.05"DIA. CAST IRON	48"	NO
5	25+68.67	9.83'R	631735.1954	879279.1259	WATER MAIN	13.5" DIA. CAST IRON	60", 45"	NO
						18", 22" WIDE CONCRETE		
6	19+16.79	13.92'R	631399.6617	878726.0132	TELECOMM.	DUCTS	27", 52"	NO
						MULTIPLE 22" WIDE		
7	22+47.97	12.40'R	631583.8259	878996.3829	TELECOMM.	CONCRETE DUCTS	26"	NO
8	25+68.67	12.50'R	631732.8327	879280.3626	TELECOMM.	20" WIDE CONCRETE DUCT	38"	NO
9	28+46.48	12.50' R	631865.0849	879527.2691	TELECOMM.	18" WIDE CONCRETE DUCT	23"	NO


<u>NOTES</u>:

- 1. FINAL PAVEMENT MARKINGS TO BE EPOXY RESIN UNLESS OTHERWISE NOTED.
- 2. THE CONTRACTOR SHALL REMOVE ANY CONFLICTING EXISTING PAVEMENT MARKINGS WITHIN THE PAVEMENT MARKING LIMITS. THIS WORK SHALL BE PAID UNDER ITEM NO. 1211001-REMOVAL OF PAVEMENT MARKINGS. ALL OTHER EXISTING PAVEMENT MARKINGS TO REMAIN.
- 3. SIGNS SHALL BE INSTALLED PER CONNDOT STANDARD SHEETS "SIGN PLACEMENT AND RETROREFLECTIVE STRIP DETAILS" AND "METAL SIGN POSTS AND SIGN MOUNTING DETAILS" UNLESS OTHERWISE NOTED.
- 4. ALL EXISTING SIGNS WITHIN THE LIMITS OF SIGNING ARE TO REMAIN UNLESS OTHERWISE NOTED OR DIRECTED BY THE ENGINEER. THE CONTRACTOR SHALL REMOVE ANY EXISTING SIGNS CONFLICTING WITH PROPOSED SIGNS WITHIN THE LIMITS OF SIGNING.
- 5. "NO PARKING SIGNS" SHALL BE INSTALLED AT AN ANGLE BETWEEN 30° AND 45° FROM THE ADJACENT TRAVELWAY.
- 6. SIGNS SHOULD BE INSTALLED AT LEAST 10' FROM ALL UTILITY POLES.
- 7. EXACT LOCATIONS OF THE SIGNS TO BE VERIFIED BY THE ENGINEER.
- 8. THE STATE WILL MAINTAIN ALL SIGNS AND PAVEMENT MARKINGS, EXCEPT BIKE SIGNS AND SHARROW PAVEMENT MARKINGS, ON ROUTE 130 (THE STATE STREET SECTION), SR 700, AND ROUTE 1 (AS WELL AS STOP BARS ON NOBLE AVENUE AND CONCORD STREET ON ROUTE 1). CITY IS TO MAINTAIN ALL BICYCLE SIGNING, ALL SHARROW MARKINGS, AND ALL SIGNS AND PAVEMENT MARKINGS ON ROUTE 130 (THE WATER STREET SECTION).

LEGEND:

SIGN LOCATION #

SIGN #'S

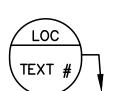

DOT PROJ: 15-374 CITY OF BRIDGEPORT PEQUONNOCK RIVER TRAIL DRAWING NO.: **EXTENSION** CP-20 DRAWING TITLE: CONSTRUCTION PLANS SHEET NO.: 32 NORTH WASHINGTON AVENUE-4


REV. DATE DESCRIPTION SHEET. NO. REVISIONS


DESIGNER: M. BORST DRAFTER: M. BORST **ENGINEER: NV5** CHECKED BY: S. NORMANDIN

APPROVED BY:

CITY OF BRIDGEPORT



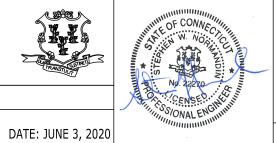

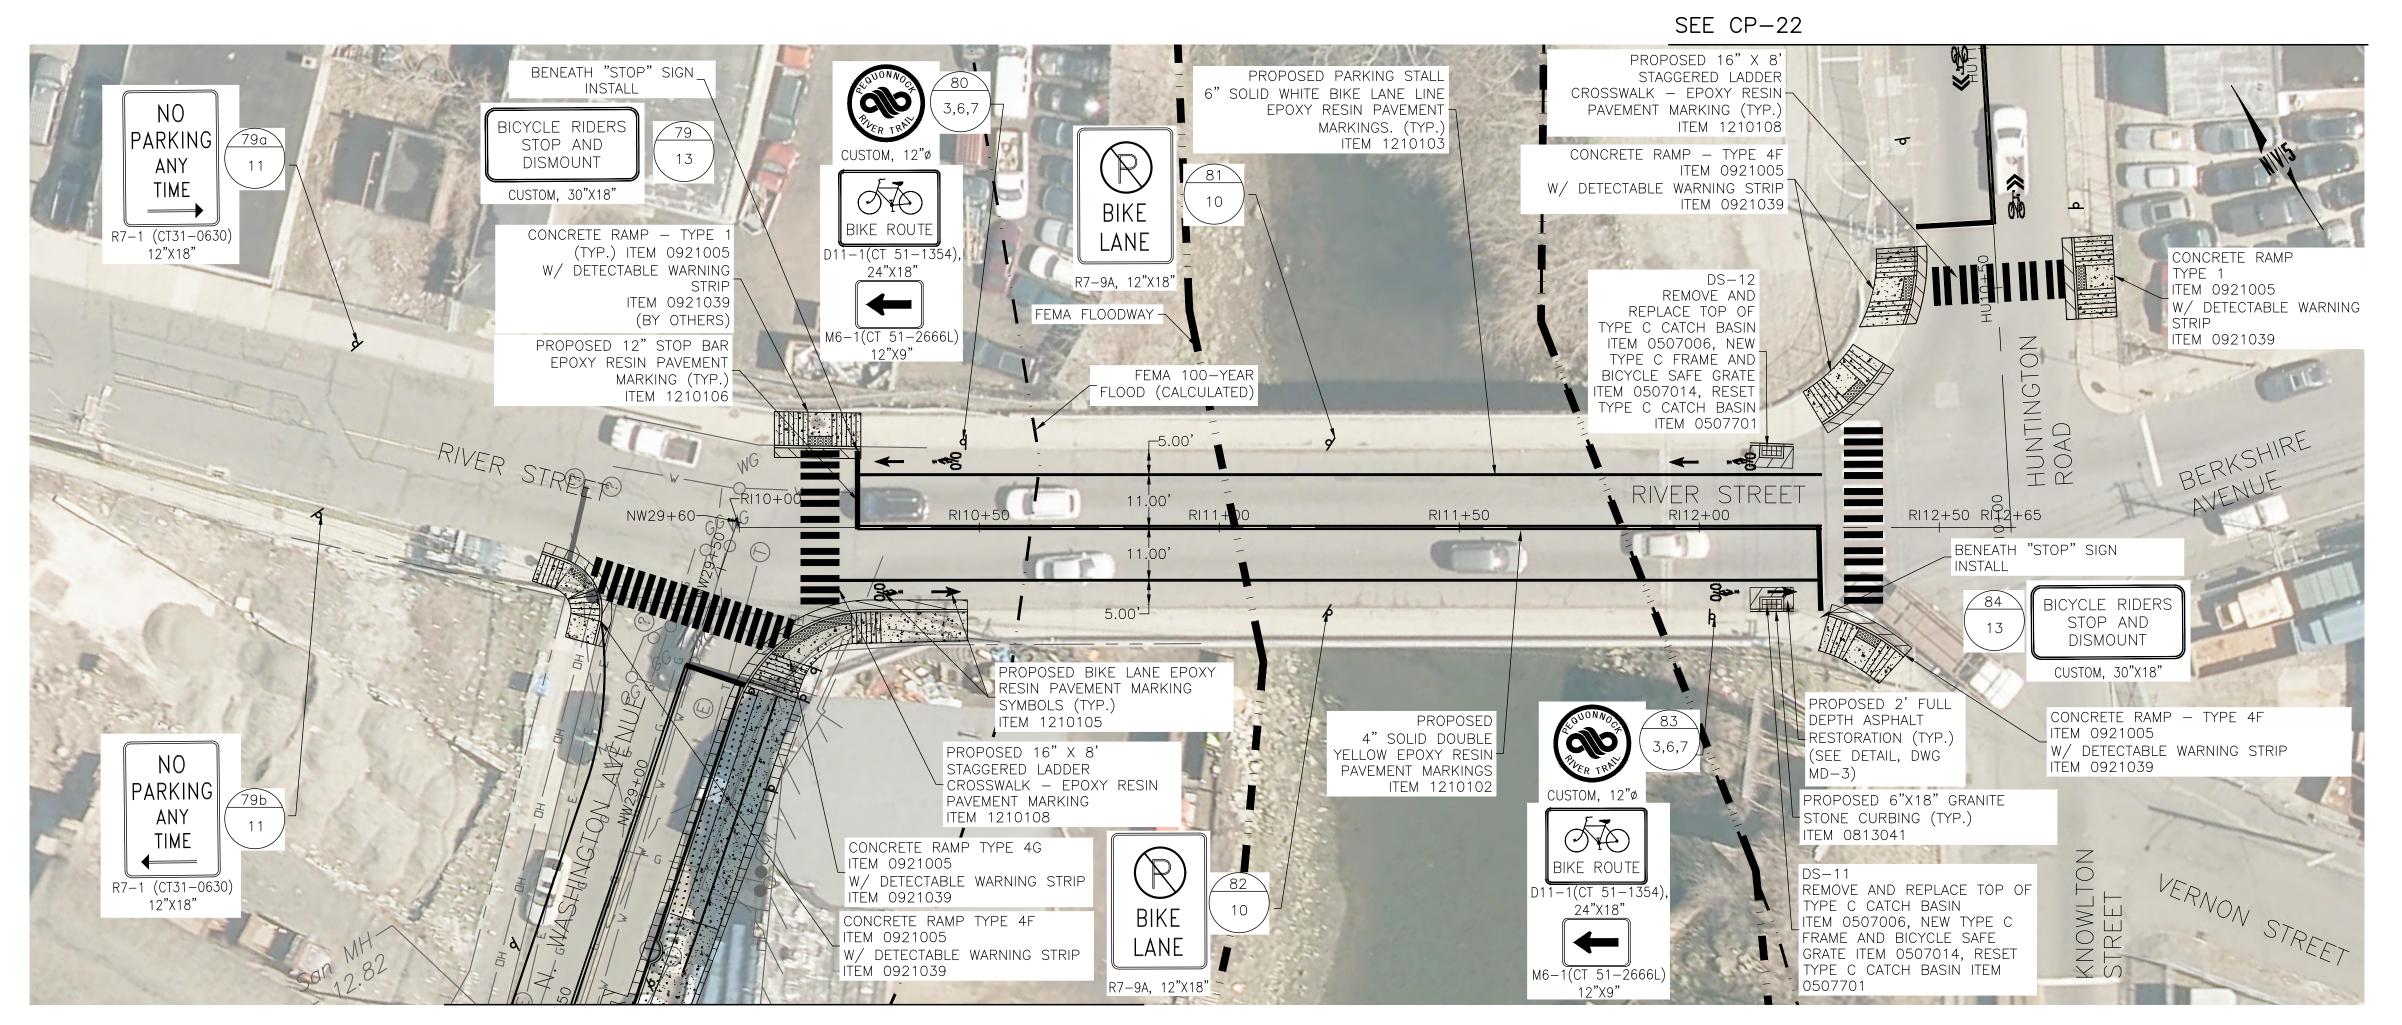


SEE CP-20

- 1. FINAL PAVEMENT MARKINGS TO BE EPOXY RESIN UNLESS OTHERWISE NOTED.
- 2. THE CONTRACTOR SHALL REMOVE ANY CONFLICTING EXISTING PAVEMENT MARKINGS WITHIN THE PAVEMENT MARKING LIMITS. THIS WORK SHALL BE PAID UNDER ITEM NO. 1211001—REMOVAL OF PAVEMENT MARKINGS. ALL OTHER EXISTING PAVEMENT MARKINGS TO REMAIN.
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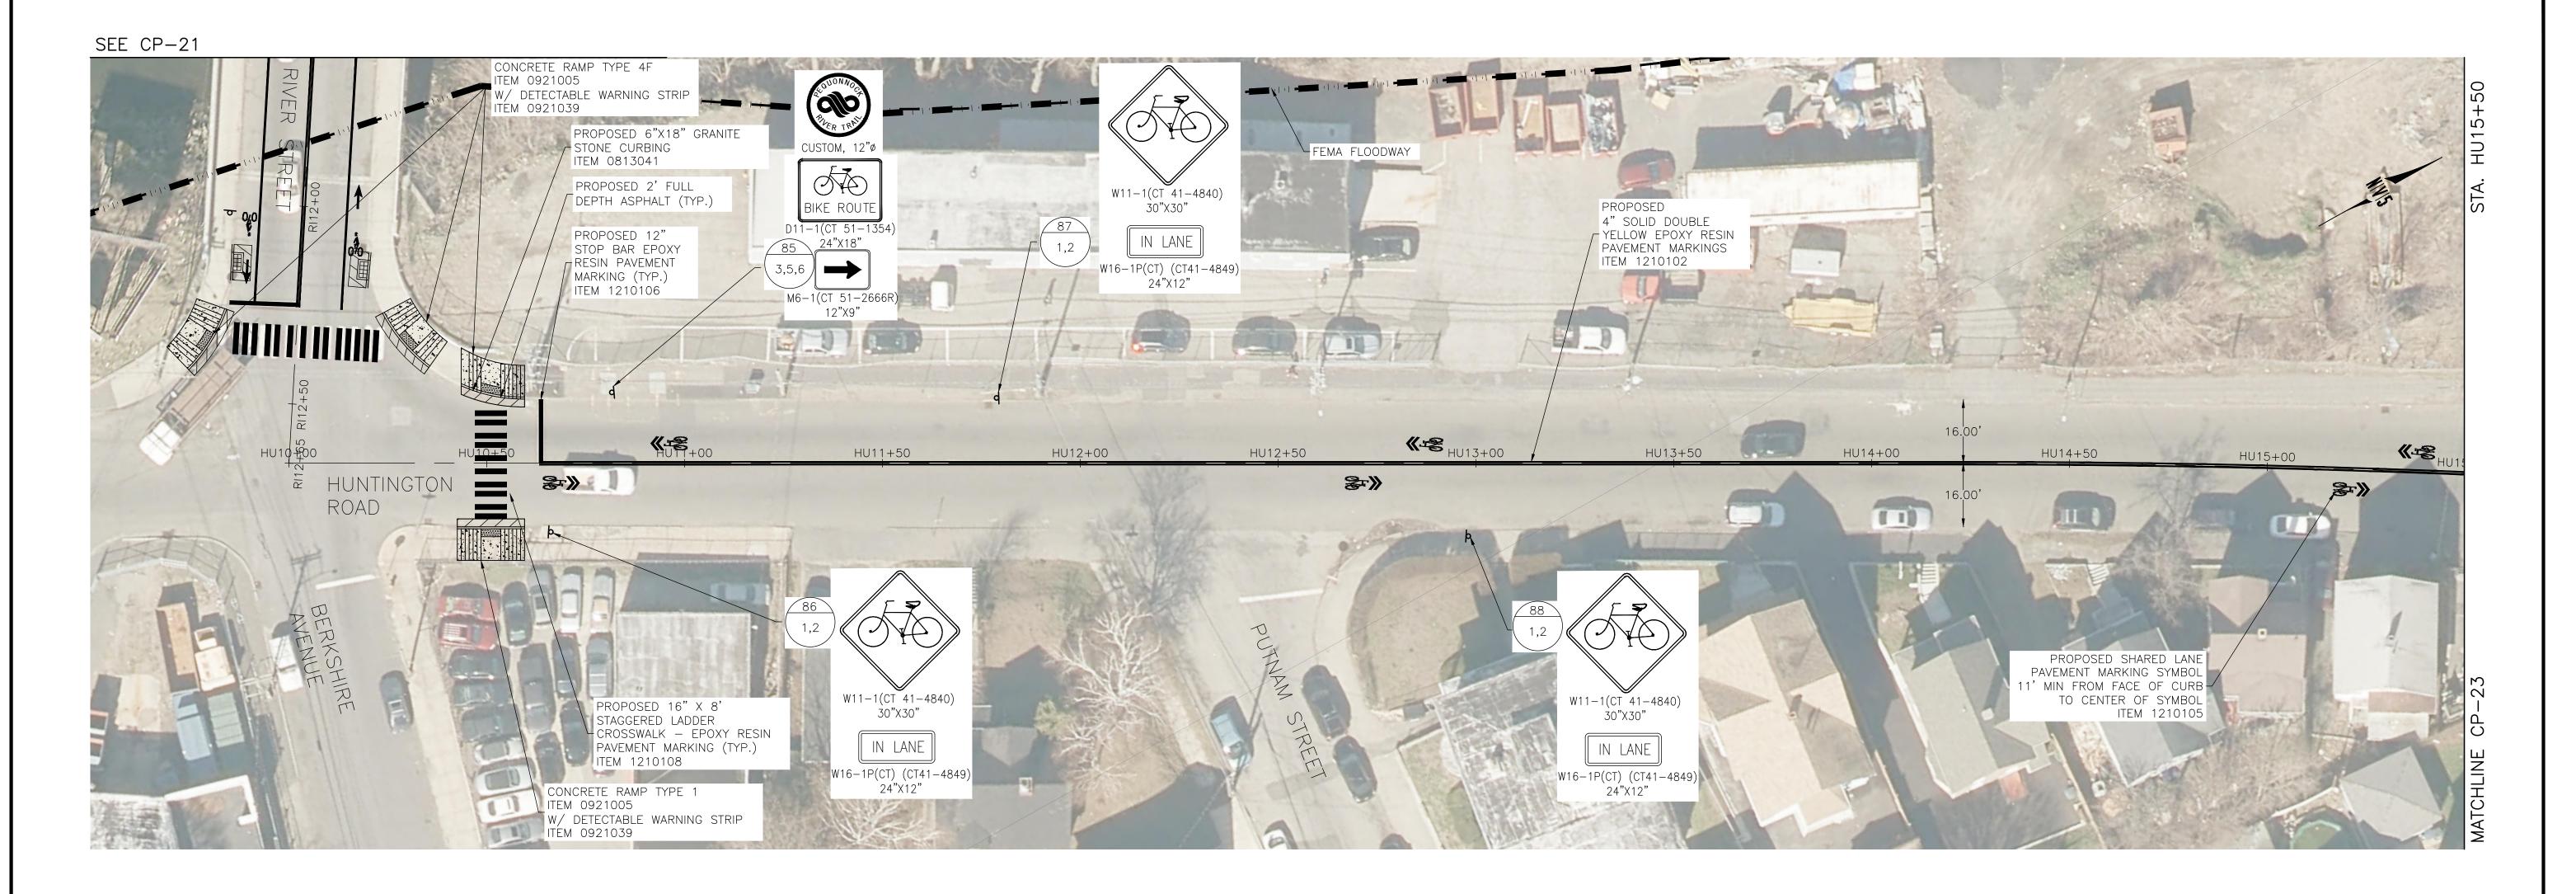
LEGEND:

SIGN LOCATION #

SIGN #'S

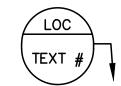


DESIGNER: M. BORST DOT PROJ: 15-374 CITY OF BRIDGEPORT CITY OF BRIDGEPORT PEQUONNOCK RIVER TRAIL DRAFTER: M. BORST DRAWING NO.: **EXTENSION** CP-21 DRAWING TITLE: CONSTRUCTION PLANS **ENGINEER: NV5** CHECKED BY: S. NORMANDIN SHEET NO.: REV. DATE DESCRIPTION SHEET. NO. 33 RIVER STREET APPROVED BY: DATE: JUNE 3, 2020 REVISIONS




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LEGEND:

SIGN LOCATION #

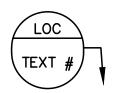

								SCALE: 1"=20'
			DESIGNER: M. BORST	CITY OF BRIDGE POR		PROJECT TITLE:	TOWN:	DOT PROJ: 15-374
			DRAFTER: M. BORST	CITY OF BRIDGEPOR	T PROPERTY WINDS	PEQUONNOCK RIVER TRAIL	CITY OF BRIDGEPORT	DRAWING NO :
			DIGITER. HI BOROT	ACORPORATED 1836	TO NO SOON ASSESSMENT OF THE PARTY OF THE PA	EXTENSION	DRAWING TITLE:	DRAWING NO.: CP-22
			CHECKED BY: S. NORMANDIN	ENGINEER: NV5	A CENSES CHELLING		CONSTRUCTION PLANS	SHEET NO.:
REV. DATE	DESCRIPTION REVISIONS	SHEET. NO.		APPROVED BY:	DATE: JUNE 3, 2020		HUNTINGTON STREET-1	34

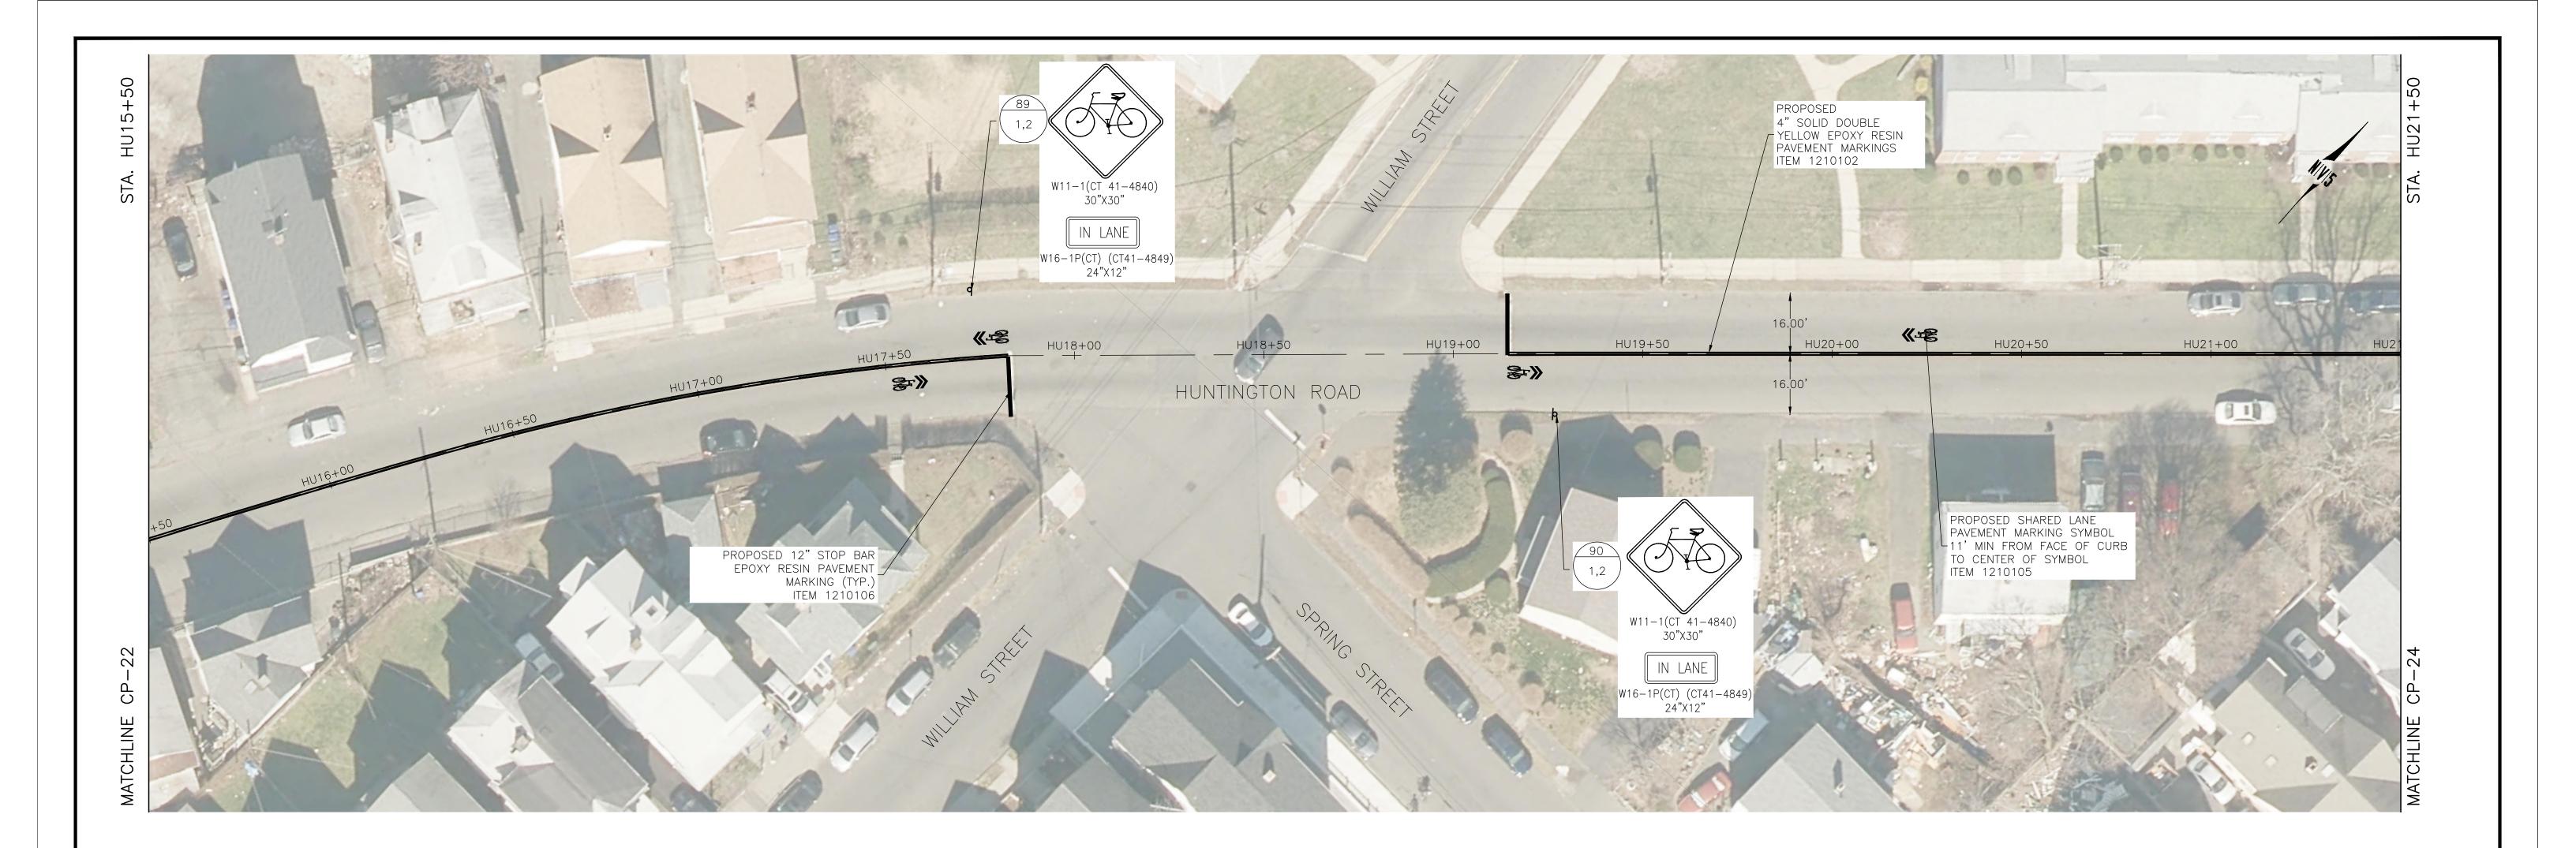


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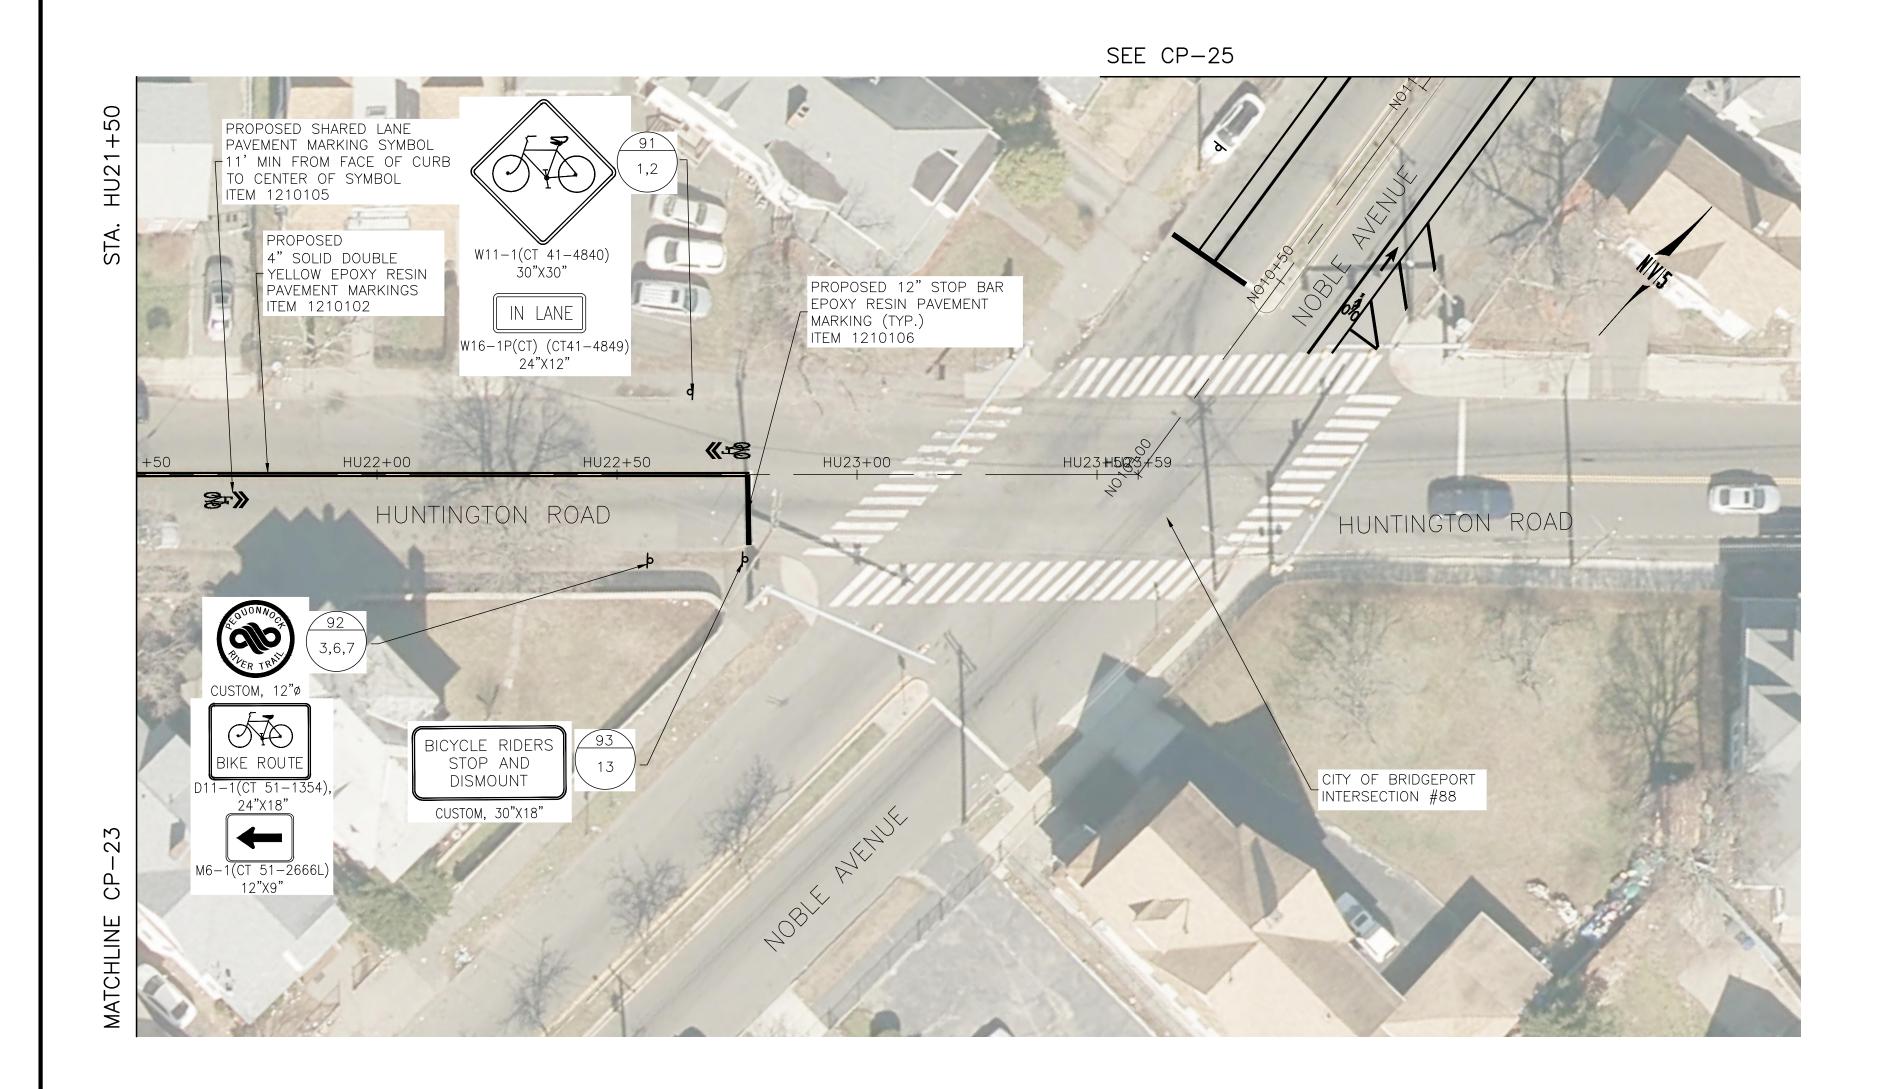
LEGEND:

SIGN LOCATION #

SIGN #'S

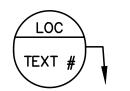

DESIGNER: M. BORST DOT PROJ: 15-374 CITY OF BRIDGEPORT CITY OF BRIDGEPORT PEQUONNOCK RIVER TRAIL DRAFTER: M. BORST DRAWING NO.: **EXTENSION** CP-23 DRAWING TITLE: CONSTRUCTION PLANS CHECKED BY: S. NORMANDIN **ENGINEER: NV5** SHEET NO.: REV. DATE DESCRIPTION SHEET. NO. 35 **HUNTINGTON STREET-2** APPROVED BY: DATE: JUNE 3, 2020 REVISIONS




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LEGEND:

SIGN LOCATION #

SIGN #'S

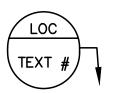


DESIGNER: M. BORST DOT PROJ: 15-374 CITY OF BRIDGEPORT CITY OF BRIDGEPORT PEQUONNOCK RIVER TRAIL DRAFTER: M. BORST DRAWING NO.: **EXTENSION CP-24** DRAWING TITLE: CONSTRUCTION PLANS CHECKED BY: S. NORMANDIN **ENGINEER: NV5** SHEET NO.: REV. DATE DESCRIPTION SHEET. NO. 36 **HUNTINGTON STREET-3** APPROVED BY: DATE: JUNE 3, 2020 REVISIONS




- 1. FINAL PAVEMENT MARKINGS TO BE EPOXY RESIN UNLESS OTHERWISE NOTED.
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LEGEND:

SIGN LOCATION #

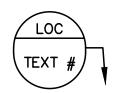


					SCALE: 1"=20'
	DESIGNER: M. BORST	CT OF BRIDGEPORT	PROJECT TITLE:	TOWN:	DOT PROJ: 15-374
	DRAFTER: M. BORST	CITY OF BRIDGEPORT	PEQUONNOCK RIVER TRAIL	CITY OF BRIDGEPORT	DRAWING NO.:
	CHECKED BY: S. NORMANDIN	ENGINEER: NV5	EXTENSION	DRAWING TITLE: CONSTRUCTION PLANS	CP-25
REV. DATE DESCRIPTION SHEET. NO. REVISIONS	STEERED DIT STRONG DANDIN	APPROVED BY: DATE: JUNE 3, 2020	ONAL ENGRICHMENT	NOBLE AVENUE-1	SHEET NO.:

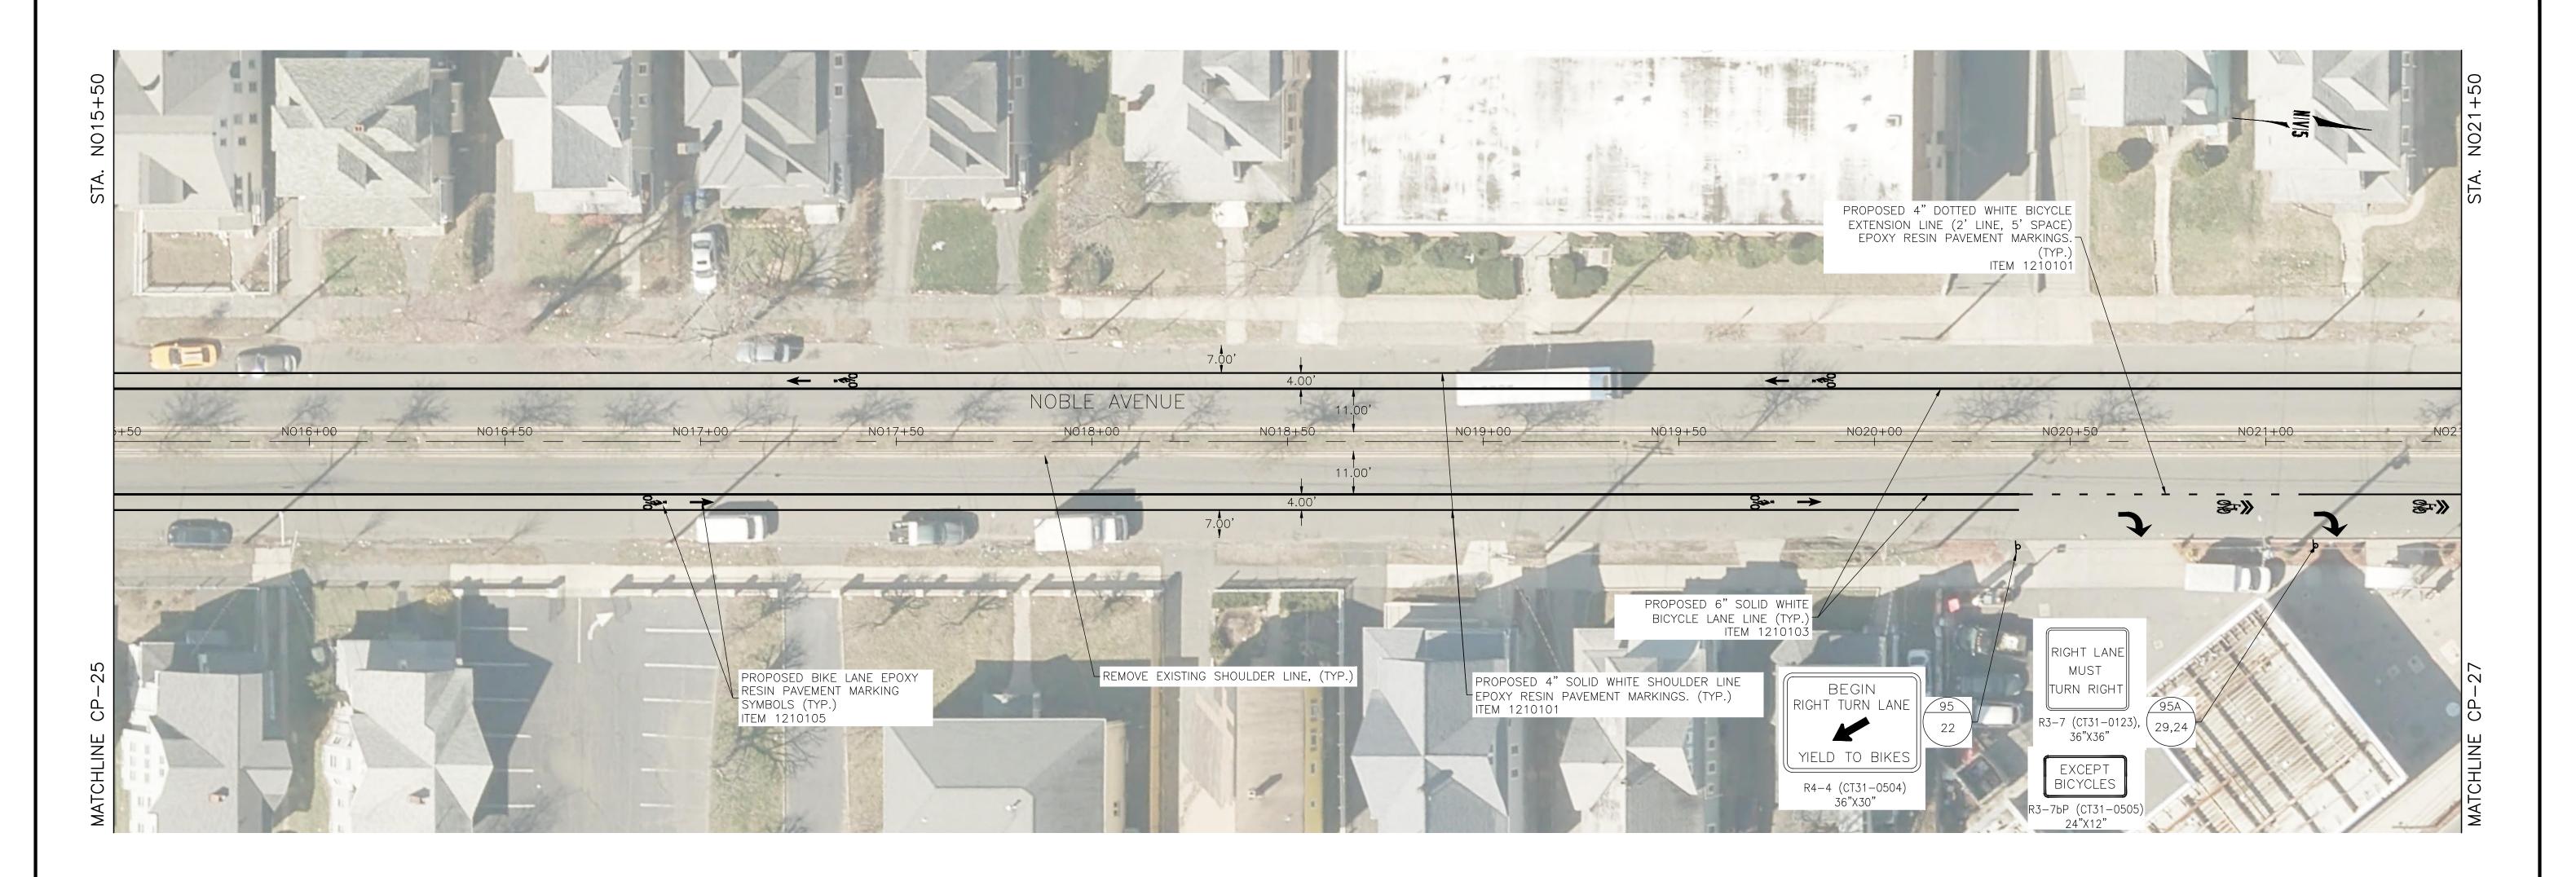


- 1. FINAL PAVEMENT MARKINGS TO BE EPOXY RESIN UNLESS OTHERWISE NOTED.
- 2. THE CONTRACTOR SHALL REMOVE ANY CONFLICTING EXISTING PAVEMENT MARKINGS WITHIN THE PAVEMENT MARKING LIMITS. THIS WORK SHALL BE PAID UNDER ITEM NO. 1211001—REMOVAL OF PAVEMENT MARKINGS. ALL OTHER EXISTING PAVEMENT MARKINGS TO REMAIN.
- 3. SIGNS SHALL BE INSTALLED PER CONNDOT STANDARD SHEETS "SIGN PLACEMENT AND RETROREFLECTIVE STRIP DETAILS" AND "METAL SIGN POSTS AND SIGN MOUNTING DETAILS" UNLESS OTHERWISE NOTED.
- 4. ALL EXISTING SIGNS WITHIN THE LIMITS OF SIGNING ARE TO REMAIN UNLESS OTHERWISE NOTED OR DIRECTED BY THE ENGINEER. THE CONTRACTOR SHALL REMOVE ANY EXISTING SIGNS CONFLICTING WITH PROPOSED SIGNS WITHIN THE LIMITS OF SIGNING.
- 5. "NO PARKING SIGNS" SHALL BE INSTALLED AT AN ANGLE BETWEEN 30° AND 45° FROM THE ADJACENT TRAVELWAY.
- 6. SIGNS SHOULD BE INSTALLED AT LEAST 10' FROM ALL UTILITY POLES.
- 7. EXACT LOCATIONS OF THE SIGNS TO BE VERIFIED BY THE ENGINEER.
- 8. THE STATE WILL MAINTAIN ALL SIGNS AND PAVEMENT MARKINGS, EXCEPT BIKE SIGNS AND SHARROW PAVEMENT MARKINGS, ON ROUTE 130 (THE STATE STREET SECTION), SR 700, AND ROUTE 1 (AS WELL AS STOP BARS ON NOBLE AVENUE AND CONCORD STREET ON ROUTE 1). CITY IS TO MAINTAIN ALL BICYCLE SIGNING, ALL SHARROW MARKINGS, AND ALL SIGNS AND PAVEMENT MARKINGS ON ROUTE 130 (THE WATER STREET SECTION).

LEGEND:

SIGN LOCATION #

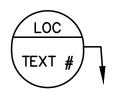


								SCALE: 1"=20'
			DESIGNER: M. BORST	of BRIDGEPORT		ROJECT TITLE:	TOWN:	DOT PROJ: 15-374
			DRAFTER: M. BORST	CITY OF BRIDGEPOR	RT STATE OF CONNECTION OF CONN	PEQUONNOCK RIVER TRAIL	CITY OF BRIDGEPORT	DRAWING NO :
			DIVALLER, III DONOT	INCORPORATED 1938	T.S. No 2020	EXTENSION	DRAWING TITLE:	DRAWING NO.: CP-26
			CHECKED BY: S. NORMANDIN	ENGINEER: NV5	A A CENSED WELL		CONSTRUCTION PLANS	SHEET NO.:
REV. DATE	DESCRIPTION REVISIONS	SHEET. NO.		APPROVED BY:	DATE: JUNE 3, 2020		NOBLE AVENUE-2	38

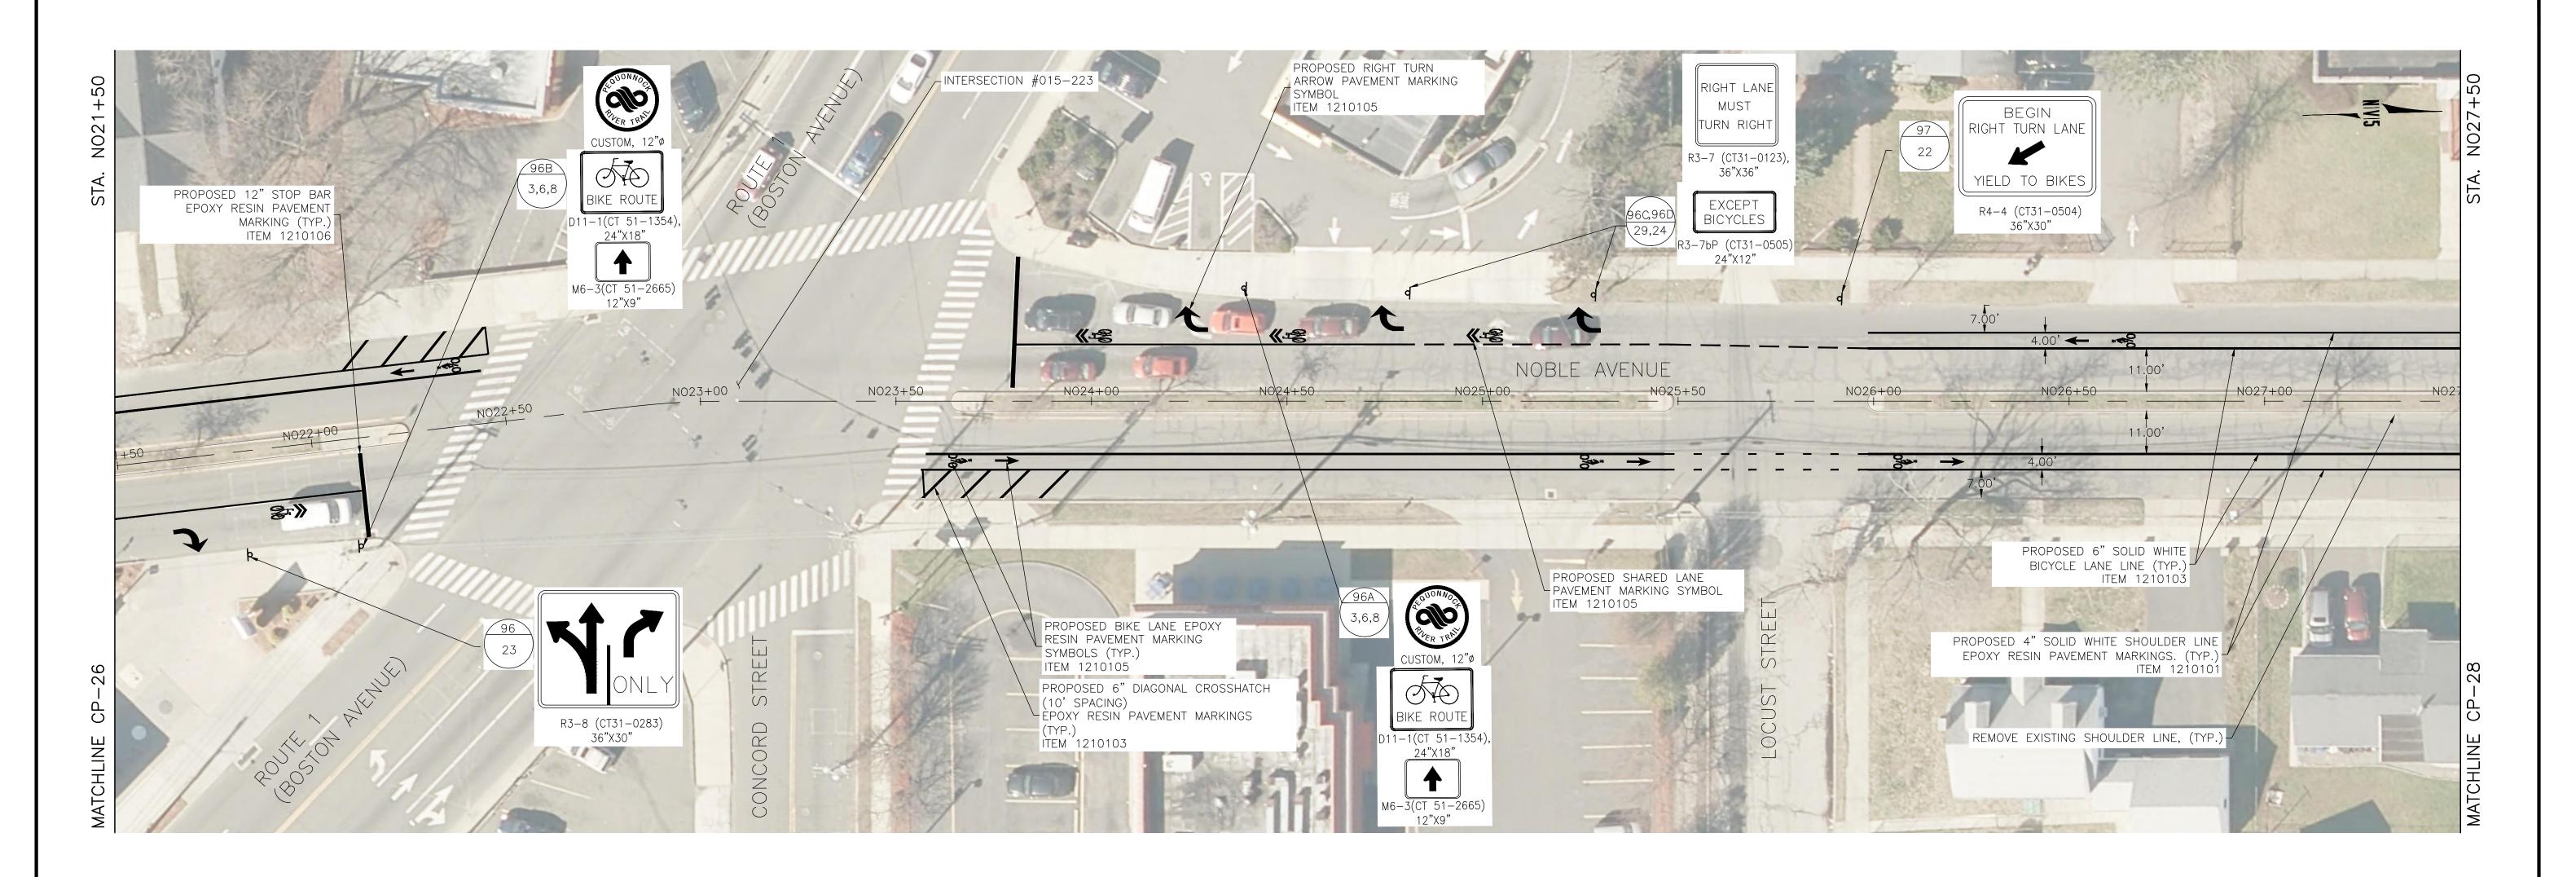

- 1. FINAL PAVEMENT MARKINGS TO BE EPOXY RESIN UNLESS OTHERWISE NOTED.
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LEGEND:

SIGN LOCATION #

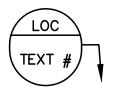

									SCALE: 1"=20'
				DESIGNER: M. BORST	CT BRIDGE FOR		ROJECT TITLE:	TOWN:	DOT PROJ: 15-374
				DRAFTER: M. BORST	CITY OF BRIDGEPOR	T OF CONNECTION WINDS	PEQUONNOCK RIVER TRAIL	CITY OF BRIDGEPORT	DRAWING NO.:
					TO PROPRIED 1858	No. 22220	EXTENSION	DRAWING TITLE:	CP-27
			2007	CHECKED BY: S. NORMANDIN	ENGINEER: NV5	CENSED THE TOTAL OF THE PROPERTY OF THE PROPER		CONSTRUCTION PLANS	SHEET NO.:
REV. D	DATE	DESCRIPTION REVISIONS	SHEET. NO.		APPROVED BY:	DATE: JUNE 3, 2020		NOBLE AVENUE-3	39




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LEGEND:

SIGN LOCATION #

SIGN #'S

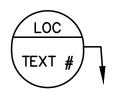

DOT PROJ: 15-374

CP-28

40

DRAWING NO.:


SHEET NO.:

CITY OF BRIDGEPORT

CONSTRUCTION PLANS

NOBLE AVENUE-4

			DESIGNER: M. BORST	OT BRIDGEFORE		a satiliza s	PR	ROJECT TITLE:	TOWN:
			DRAFTER: M. BORST	CITY OF E	BRIDGEPORT		OF CONNECTION NO. NO. NO. NO. NO. NO. NO. NO. NO. N	PEQUONNOCK RIVER TRAIL	CIT
				MCORPORATED 1838		TRANSTULT	* 150 No. 32270	EXTENSION	DRAWING TITLE:
			CHECKED BY: S. NORMANDIN	ENGINEER: NV5			X CENSED HELL		CC
REV. DATE	DESCRIPTION	SHEET. NO.		ADDOUTED DV			OVONAL ENGINEER		
	REVISIONS			APPROVED BY:	L	DATE: JUNE 3, 2020			

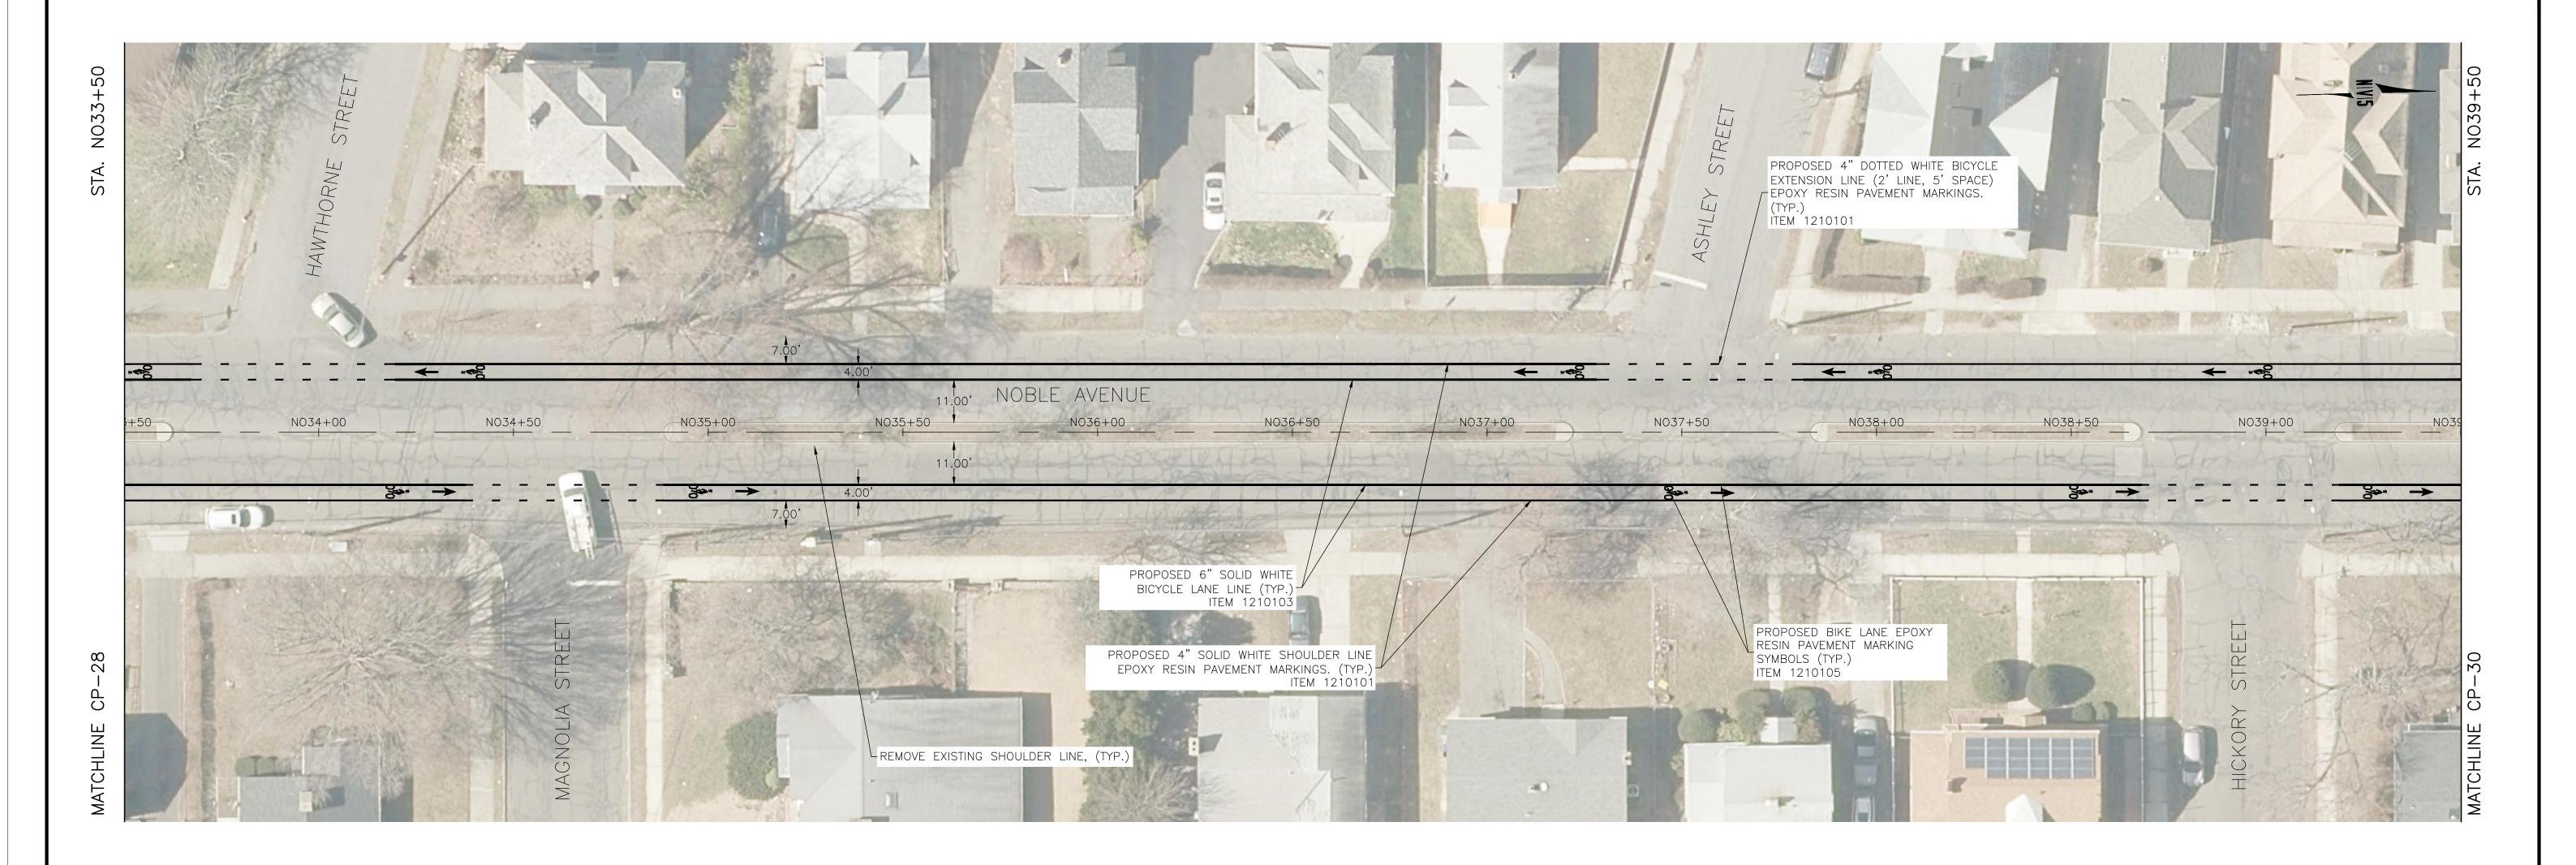


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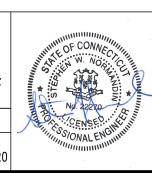
LEGEND:

SIGN LOCATION #

SIGN #'S

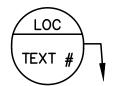

			DESIGNER: M. BORST	CT OF BRIDGE FOR	
			DRAFTER: M. BORST	CITY OF	BRIDGEPORT
			CHECKED BY: S. NORMANDIN	ENGINEER: NV5	
REV. DATE	DESCRIPTION	SHEET. NO.			
·	REVISIONS			APPROVED BY:	DATE: JUN



PEQUONNOCK RIVER TRAIL
EXTENSION

CITY OF BRIDGEPORT

CONSTRUCTION PLANS
NOBLE AVENUE-5


DOT PROJ: 15-374

DRAWING NO.:

CP-29

SHEET NO.:


41

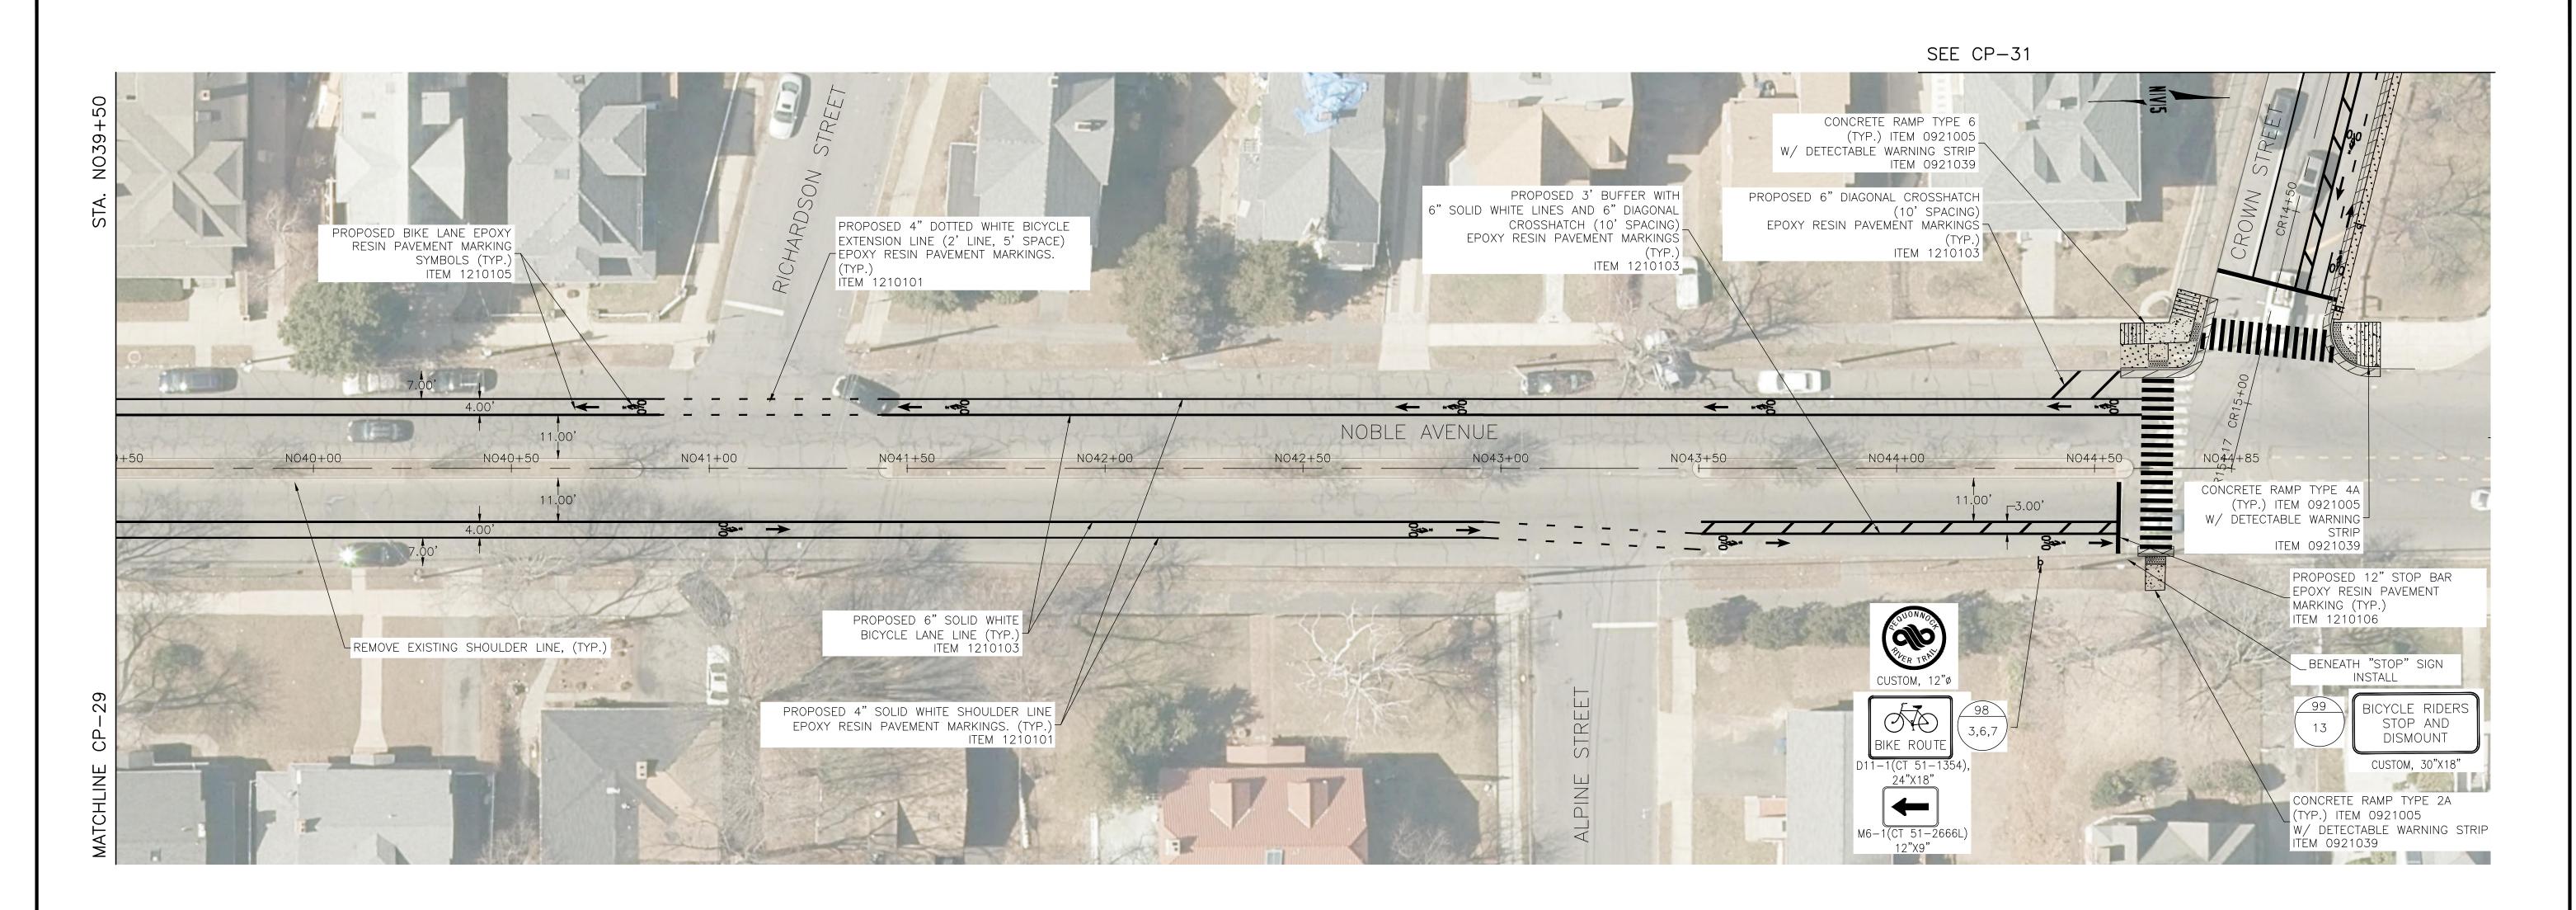

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LEGEND:

SIGN LOCATION #

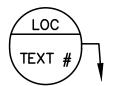

								SCALE: 1"=20'
			DESIGNER: M. BORST	OF BRIDGEPORT		ROJECT TITLE:	TOWN:	DOT PROJ: 15-374
			DRAFTER: M. BORST	CITY OF BRIDGEPOR	T PROPERTY WINDS	PEQUONNOCK RIVER TRAIL	CITY OF BRIDGEPORT	DRAWING NO.:
				MCORPORATED 1836	No. 22270	EXTENSION	DRAWING TITLE:	CP-30
			CHECKED BY: S. NORMANDIN	ENGINEER: NV5	A TO SO THE SHARE THE STATE OF		CONSTRUCTION PLANS	SHEET NO.:
EV. DATE	DESCRIPTION REVISIONS	SHEET. NO.		APPROVED BY:	DATE: JUNE 3, 2020		NOBLE AVENUE-6	42



SEE CP-30


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LEGEND:

SIGN LOCATION #

SIGN #'S



DESIGNER: M. BORST DOT PROJ: 15-374 CITY OF BRIDGEPORT CITY OF BRIDGEPORT PEQUONNOCK RIVER TRAIL DRAFTER: M. BORST DRAWING NO.: **EXTENSION** CP-31 DRAWING TITLE: CONSTRUCTION PLANS **ENGINEER: NV5** CHECKED BY: S. NORMANDIN SHEET NO.: REV. DATE DESCRIPTION SHEET. NO. 43 **CROWN STREET** APPROVED BY: DATE: JUNE 3, 2020 REVISIONS

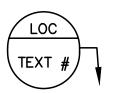*ONLY STANDARD SHEETS MARKED WITH AN "\sqrt{" ARE IN THIS PROJECT

**REVISED OR ADDED

\ *	SHEET NO.	TITLE	APPROVAL DATE**
	HW-286_01	DRAINAGE TRENCH EXCAVATION	7-15-20
	HW-506_01	ENDWALLS, SLOPE PAVED INLETS AND OUTLETS	1-26-12
	HW-506_02	TYPE "D-G" & "L" ENDWALLS	7-13-12
	HW-506_03	ENDWALLS FOR PIPE - ARCH	9-18-09
	HW-586_01	CATCH BASIN AND DROP INLET TYPES "C" AND "C-L"	7-15-20
	HW-586_02	CATCH BASIN TOPS (TYPES "C" AND "C-L") FOR DOUBLE GRATE TYPE I	7-15-20
	HW-586_03	CATCH BASIN TOPS (TYPES "C" AND "C-L") FOR DOUBLE GRATE TYPE II	7-15-20
	HW-586_04	PRECAST CATCH BASIN AND ROUND STRUCTURE	7-15-20
	HW-586_05	PRECAST CATCH BASIN TYPES FOR DOUBLE GRATE TYPE I	7-15-20
	HW-586_06	PRECAST CATCH BASIN TYPES FOR DOUBLE GRATE TYPE II	7-15-20
	HW-586_07	CATCH BASIN TOPS TYPE "C" AND "C-L"	7-15-20
	HW-586_08	CATCH BASIN FRAMES AND GRATES	7-15-20
	HW-586_09	CATCH BASIN LOCK DOWN TOPS	7-15-20
	HW-586_10a	MANHOLE FRAME AND COVER	7-15-20
	HW-586_10b	MANHOLE FRAME AND GRATE	7-15-20
	HW-586_10c	REINFORCED PRECAST CONCRETE MANHOLE	7-15-20
	HW-586_10d	MANHOLE NON-PRECAST CONCRETE UNIT	7-15-20
	HW-686_01	C.C.M. PIPE INSTALLATION	7-15-20
	HW-686_02	PIPE ENDS	7-15-20
	HW-751_01	UNDERDRAINS AND UNDERDRAIN OUTLETS	7-12-12
	HW-803_01a	PAVED APRONS	6-07-17
	HW-803_01b	PAVED DITCHES AND PAVED CHANNELS	6-07-17
	HW-811_01	CONCRETE CURBING	6-07-17
	HW-813_01	GRANITE STONE TRANSITION CURBING	7-24-13
	HW-813_02	STONE CURBING	6-07-17
	HW-815_01	BITUMINOUS CONCRETE CURBING	6-07-17
	HW-821_01a	TRANSITION - 45" (1145) F-SHAPE TO 45" (1145) VERTICAL SHAPE SHEET 1	1-26-12
	HW-821_01b	TRANSITION - 45" (1145) F-SHAPE TO 45" (1145) VERTICAL SHAPE SHEET 2	10-18-10
	HW-821_01c	TRANSITION - 45" (1145) F-SHAPE TO 45" (1145) VERTICAL SHAPE SHEET 3	1-26-12
	HW-821_02a	45" F-SHAPE PRECAST CONCRETE BARRIER CURB SHEET 1	1-27-20
	HW-821_02b	45" F-SHAPE PRECAST CONCRETE BARRIER CURB SHEET 2	1-27-20
	HW-821_03a	TRANSITION - 32" (813) JERSEY SHAPE TO 45" (1145) VERTICAL SHAPE SHEET 1	1-26-12

OFFICE OF ENGINEERING 2800 BERLIN TURNPIKE NEWINGTON, CT 06111

NOT TO SCALE

\ *	SHEET NO.	TITLE	APPROVAL DATE**
	HW-821_03b	TRANSITION - 32" (813) JERSEY SHAPE TO 45" (1145) VERTICAL SHAPE SHEET 2	10-18-10
	HW-821_03c	TRANSITION - 32" (813) JERSEY SHAPE TO 45" (1145) VERTICAL SHAPE SHEET 3	10-18-10
	HW-821_03d	TRANSITION - 32" (813) JERSEY SHAPE TO 45" (1145) VERTICAL SHAPE SHEET 4	10-18-10
	HW-821_03e	TRANSITION - 32" (813) JERSEY SHAPE TO 45" (1145) F-SHAPE	7-24-13
	HW-821_04a	MERRITT PARKWAY NARROW MEDIAN BARRIER	6-09-11
	HW-821_04b	MERRITT PARKWAY - 2'(610) WIDE MEDIAN BARRIER AND ROADSIDE BARRIER	7-24-13
	HW-821_05a	TRANSITION - 45" (1145) F-SHAPE TO 54" (1372) VERTICAL SHAPE SHEET 1	1-26-12
	HW-821_05b	TRANSITION - 45" (1145) F-SHAPE TO 54" (1372) VERTICAL SHAPE SHEET 2	1-26-12
	HW-821_06	54" (1372) VERTICAL SHAPE BARRIER	2-06-12
	HW-821_07	MISCELLANOUS DETAILS FOR BARRIER TRANSITIONS	7-12-12
	HW-821_08a	F-SHAPE CONC. BARRIER CURB (21"x45") TRANSITION FOR THRIE-BEAM	1-09-20
	HW-821_08b	F-SHAPE CONC. BARRIER CURB (21"x45") TRANSITION FOR THRIE-BEAM - REINF.	1-09-20
	HW-821_09a	SINGLE SLOPE CONC. BARRIER CURB (20"x42") TRANS. FOR THRIE-BEAM	1-09-20
	HW-821_09b	SINGLE SLOPE CONC. BARRIER CURB (20"x42") TRANS. FOR THRIE-BEAM - REINF.	1-09-20
	HW-821_10a	VERTICAL FACE CONC. (21"x54") TRANSITION FOR THRIE-BEAM	1-09-20
	HW-821_10b	VERTICAL FACE CONC. (21"x54") TRANSITION FOR THRIE-BEAM - REINF.	1-09-20
	HW-821_11a	42" SINGLE SLOPE PRECAST CONCRETE BARRIER CURB -SHEET 1	1-27-20
	HW-821_11b	42" SINGLE SLOPE PRECAST CONCRETE BARRIER CURB -SHEET 2	1-27-20
	HW-822_01	TEMPORARY PRECAST CONCRETE BARRIER CURB	7-24-13
	HW-905_01	STONE WALL FENCE	1-25-19
	HW-906_01	WIRE FENCE	1-25-19
	HW-910_01	W-BEAM METAL BEAM RAIL HARDWARE	6-09-11
	HW-910_02	METAL BEAM RAIL (TYPE R-B 350) GUIDERAIL	6-09-11
	HW-910_03	METAL BEAM RAIL (TYPE MD-B 350) GUIDERAIL	6-09-11
	HW-910_04	METAL BEAM RAIL (TYPE R-B 350) SYSTEMS 5, 5A, & 6	6-09-11
	HW-910_05	METAL BEAM RAIL R-B 350 SPAN TYPE I, II, III SECTIONS	7-24-13
	HW-910_06	R-B 350 BRIDGE ATTACHMENT SAFETY SHAPE PARAPET	6-09-11
	HW-910_07	R-B 350 BRIDGE ATTACHMENT VERTICAL SHAPE PARAPET	1-25-19
	HW-910_08	R-B 350 BRIDGE ATTACHMENT TRAILING END	6-09-11
	HW-910_09a	MISCELLANEOUS GUIDERAIL TRANSITIONS SHEET 1	1-26-12
	HW-910_09b	MISCELLANEOUS GUIDERAIL TRANSITIONS SHEET 2	7-25-12
	HW-910_10	METAL BEAM RAIL 8" (203) X 6" (152) BOX BEAM	7-24-13
	HW-910_11	CURVED GUIDERAIL TREATMENT DETAIL	7-25-12

STATE OF CONNECTICUT

DEPARTMENT

OF

TRANSPORTATION

*ONLY STANDARD SHEETS MARKED WITH AN "√" ARE IN THIS PROJECT # **REVISED OR ADDED

SHEET NO.	TITLE	APPROVAL DATE**	SHEET NO.	TITLE	APPROVAL DATE**
HW-910_12a	MERRITT PARKWAY GUIDERAIL LEADING END ATTACHMENTS AND SYSTEMS 2&3	7-24-13	HW-921_01	DRIVEWAY RAMPS AND SIDEWALKS	6-07-17
HW-910_12b	MERRITT PARKWAY GUIDERAIL HARDWARE DETAILS	7-24-13	HW-949_01a	LANDSCAPE PLANTING	6-15-19
HW-910_12c	MERRITT PARKWAY GUIDERAIL TRAILING END ATTACHMENTS	7-24-13	HW-949_01b	TREE STAKING	6-15-19
HW-910_12d	MERRITT PARKWAY MEDIAN GUIDERAIL AND END ANCHOR	6-09-11	HW-1800_01	GRADING PLAN FOR IMPACT ATTENUATION SYSTEMS (FLARED AND TANGENTIAL)	1-25-19
HW-910_13a	THRIE-BEAM METAL BEAM RAIL HARDWARE	7-24-13	HW-1800 02	GRADING PLAN FOR IMPACT ATTENUATION SYSTEMS (MEDIAN/GORE)	1-25-20
HW-910_13b	THRIE-BEAM TRANSITIONS	7-24-13			
HW-910_14a	THRIE-BEAM 350 BRIDGE ATTACHMENT	6-09-11			
HW-910_14b	THRIE-BEAM 350 GUIDERAIL TRANSITION TO R-B 350 GUIDERAIL	6-09-11			
HW-910_15	MD-B 350 MEDIAN BARRIER SAFETY SHAPE ATTACHMENT TYPE I	6-09-11			
HW-910_16	MD-B 350 MEDIAN BARRIER SAFETY SHAPE ATTACHMENT TYPE II	6-09-11			
HW-910_17	R-B TERMINAL SECTION	7-24-13			
HW-910_18	METAL BEAM RAIL (TYPE MD-I) GUIDERAIL	10-18-10			
HW-910_19a	METAL BEAM RAIL (MODIFIED TYPE R-I) AND END ANCHORAGE TYPE I	7-24-13			
HW-910_19b	METAL BEAM RAIL (MODIFIED TYPE R-I) AND END ANCHORAGE TYPE II	7-24-13			
HW-910_19c	METAL BEAM RAIL (MODIFIED TYPE R-I) SYSTEMS 2 AND 3	7-24-13			
HW-910_20	MASH W-BEAM HARDWARE	1-05-18			
HW-910_21	METAL BEAM RAIL (R-B MASH) GUIDERAIL	1-25-19			
HW-910_22	METAL BEAM RAIL (MD-B MASH) GUIDERAIL	1-05-18			
HW-910_23	METAL BEAM RAIL (R-B MASH) HALF & QUARTER POST SPACING GUIDERAIL	1-05-18			
HW-910_24	METAL BEAM RAIL SPAN SECTION TYPES II AND III	1-05-18			
HW-910_25	METAL BEAM RAIL TRANSITION 350 TO MASH	1-05-18			
HW-910_26	THRIE-BEAM ATTACHMENT HARDWARE	1-09-20			
HW-910_27	THRIE-BEAM ATTACHMENT	1-09-20			
HW-911_01	R-B END ANCHORAGE TYPE I AND II	1-25-19			
HW-911_02	MD-B END ANCHORAGE TYPE I	1-05-18			
HW-911_03	ANCHOR IN EARTH CUT SLOPE & ANCHOR IN ROCK CUT SLOPE	10-18-10			
HW-911_05	MERRITT PARKWAY GUIDERAIL END ANCHORS	7-24-13			
HW-913_01a	CHAIN LINK FENCE	5-06-19			
HW-913_01b	CHAIN LINK FENCE HARDWARE	5-06-19			
HW-913_02	CHAIN LINK FENCE GATES	5-06-19			
HW-918_01a	THREE CABLE GUIDERAIL (I-BEAM POSTS) SHEET 1	7-24-13			
HW-918_01b	THREE CABLE GUIDERAIL (I-BEAM POSTS) SHEET 2	1-26-12			
HW-918_01c	THREE CABLE GUIDERAIL (I-BEAM POSTS) SHEET 3	7-24-13			

DEPARTMENT

OF
TRANSPORTATION

OFFICE OF ENGINEERING 2800 BERLIN TURNPIKE NEWINGTON, CT 06111

NOT TO SCALE

ONLY STANDARD SHEETS MARKED WITH AN "V" ARE IN THIS PROJECT

SHEET NO.	TITLE	APPROVA DATE
TR-1000_01	GENERAL CLAUSES (TEST PROCEDURES)	1/2014
TR-1001_01	TRENCHING & BACKFILLING, ELECTRICAL CONDUIT	4/2012
TR-1002_01	TRAFFIC CONTROL FOUNDATIONS	1/2014
TR-1010_01	CONCRETE HANDHOLE	4/2014
TR-1102_01	PEDESTALS, PEDESTRIAN SIGNALS	4/2012
TR-1105_01	TRAFFIC SIGNALS AND CABLE ASSIGNMENTS	8/2018
TR-1107_01	PEDESTRIAN PUSH BUTTON	8/2018
TR-1108_01	CONTROLLERS	5/2013
TR-1111_01	LOOP VEHICLE DETECTOR AND SAWCUT	4/2014
TR-1113_01	CONTROL CABLE	4/2014
TR-1114_01	BONDING & UTILITY POLE ATTACHMENT DETAILS, SIGN HANGER, "Y" CLAMP DETAILS	8/2018

TR-1210_02 PAVEMENT MARKINGS (DURABLE MARKINGS) FOR DIVIDED HIGHWAYS OBS TR-1210_03 SPECIAL DETAILS & TYPICAL PAVEMENT MARKINGS FOR TWO-WAY HIGHWAYS OBS TR-1210_04 PAVEMENT MARKING LINES AND SYMBOLS 8/20	ROVAL ATE
TR-1208_02 METAL SIGN POSTS AND SIGN MOUNTING DETAILS TR-1210_01 PAVEMENT MARKINGS (DURABLE MARKINGS) FOR DIVIDED HIGHWAYS OBS TR-1210_02 PAVEMENT MARKINGS (DURABLE MARKINGS) FOR DIVIDED HIGHWAYS OBS TR-1210_03 SPECIAL DETAILS & TYPICAL PAVEMENT MARKINGS FOR TWO-WAY HIGHWAYS OBS TR-1210_04 PAVEMENT MARKING LINES AND SYMBOLS 8/20	018
TR-1210_01 PAVEMENT MARKINGS (DURABLE MARKINGS) FOR DIVIDED HIGHWAYS OBS TR-1210_02 PAVEMENT MARKINGS (DURABLE MARKINGS) FOR DIVIDED HIGHWAYS OBS TR-1210_03 SPECIAL DETAILS & TYPICAL PAVEMENT MARKINGS FOR TWO-WAY HIGHWAYS OBS TR-1210_04 PAVEMENT MARKING LINES AND SYMBOLS 8/20	018
TR-1210_02 PAVEMENT MARKINGS (DURABLE MARKINGS) FOR DIVIDED HIGHWAYS OBS TR-1210_03 SPECIAL DETAILS & TYPICAL PAVEMENT MARKINGS FOR TWO-WAY HIGHWAYS OBS TR-1210_04 PAVEMENT MARKING LINES AND SYMBOLS 8/20)17
TR-1210_03 SPECIAL DETAILS & TYPICAL PAVEMENT MARKINGS FOR TWO-WAY HIGHWAYS OBS TR-1210_04 PAVEMENT MARKING LINES AND SYMBOLS 8/20	OLETE
TR-1210_04 PAVEMENT MARKING LINES AND SYMBOLS 8/20	OLETE
	OLETE
TD 1210 OF DAVEMENT MADICINICS FOR DIVIDED LITCUMANS	018
TR-1210_05 PAVEMENT MARKINGS FOR DIVIDED HIGHWAYS 4/20)17
TR-1210_06 PAVEMENT MARKINGS FOR DIVIDED HIGHWAYS 8/20	018
TR-1210_07 PAVEMENT MARKINGS FOR EXIT RAMPS 4/20)17
TR-1210_08 PAVEMENT MARKINGS FOR NON FREEWAYS 8/20	018
TR-1210_09 PAVEMENT MARKINGS FOR BICYCLE LANES, PARKING STALLS, AND RR CROSSINGS 4/20	017
TR-1220_01 SIGNS FOR CONSTRUCTION AND PERMIT OPERATIONS 8/20	018
TR-1220_02 CONSTRUCTION SIGN SUPPORTS AND CHANNELIZING DEVICES 8/20	018

STANDARD SHEETS SHALL BE USED WITH STANDARD SPECIFICATIONS

			THE INFORMATION, INCLUDING ESTIMATED
			QUANTITIES OF WORK, SHOWN ON THESE SHEETS IS BASED ON LIMITED
4	4-2017	REMOVED TR-1210_01 TO TR-1210_03. ADDED TR-1210_04 TO TR-1210_09	INVESTIGATIONS BY THE STATE AND IS IN NO WAY WARRANTED TO INDICATE
3	4-2014	REMOVED TR-1111_02.	THE CONDITIONS OF ACTUAL QUANTITIES
2	1-2014	REMOVED TR-1103_01.	OF WORK WHICH WILL BE REQUIRED.
1	4-2012	RENUMBERED TR-1107_02 TO TR-1114_01. REMOVED TR-1116_01.	

REVISION DESCRIPTION

REV. DATE


Plotted Date: 8/16/2018


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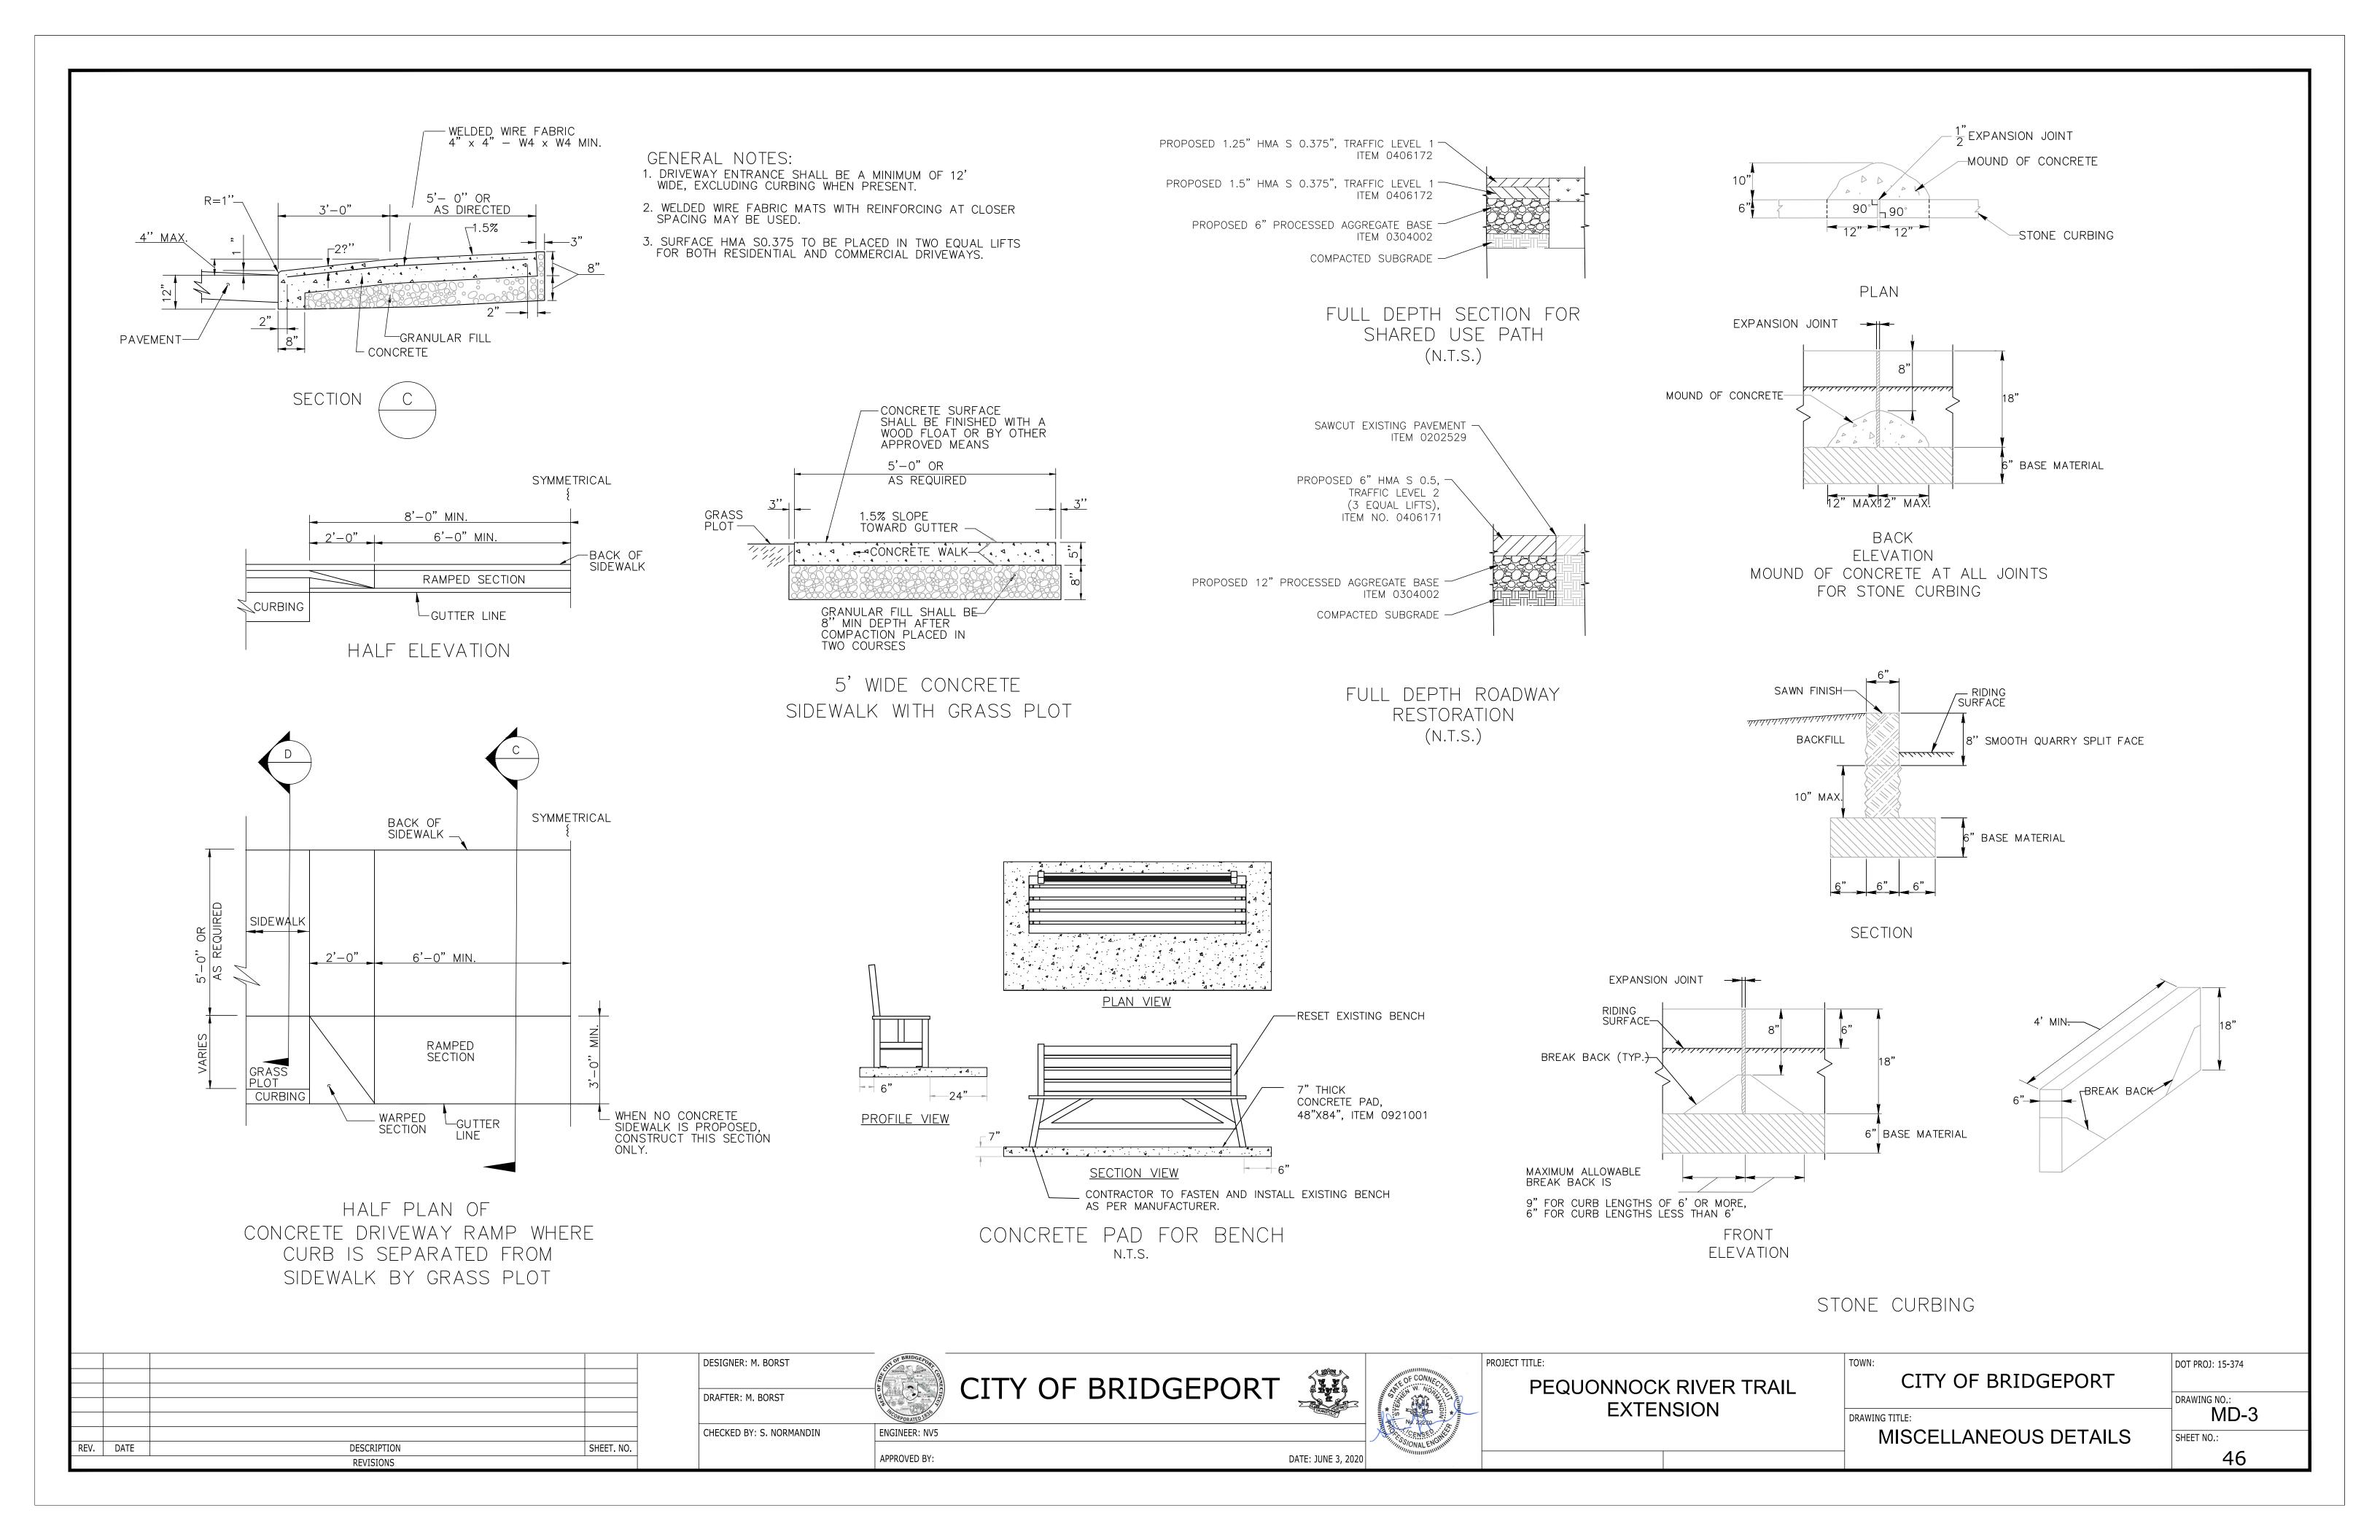
STATE OF CONNECTICUT **DEPARTMENT OF TRANSPORTATION** Filename: CTDOT_TRAFFIC_STD_DGN.DGN Model: TR-01-STD_INDEX


NAME/DATE/TIME: **CTDOT** STANDARD SHEET OFFICE OF ENGINEERING


TRAFFIC STANDARD SHEET INDEX




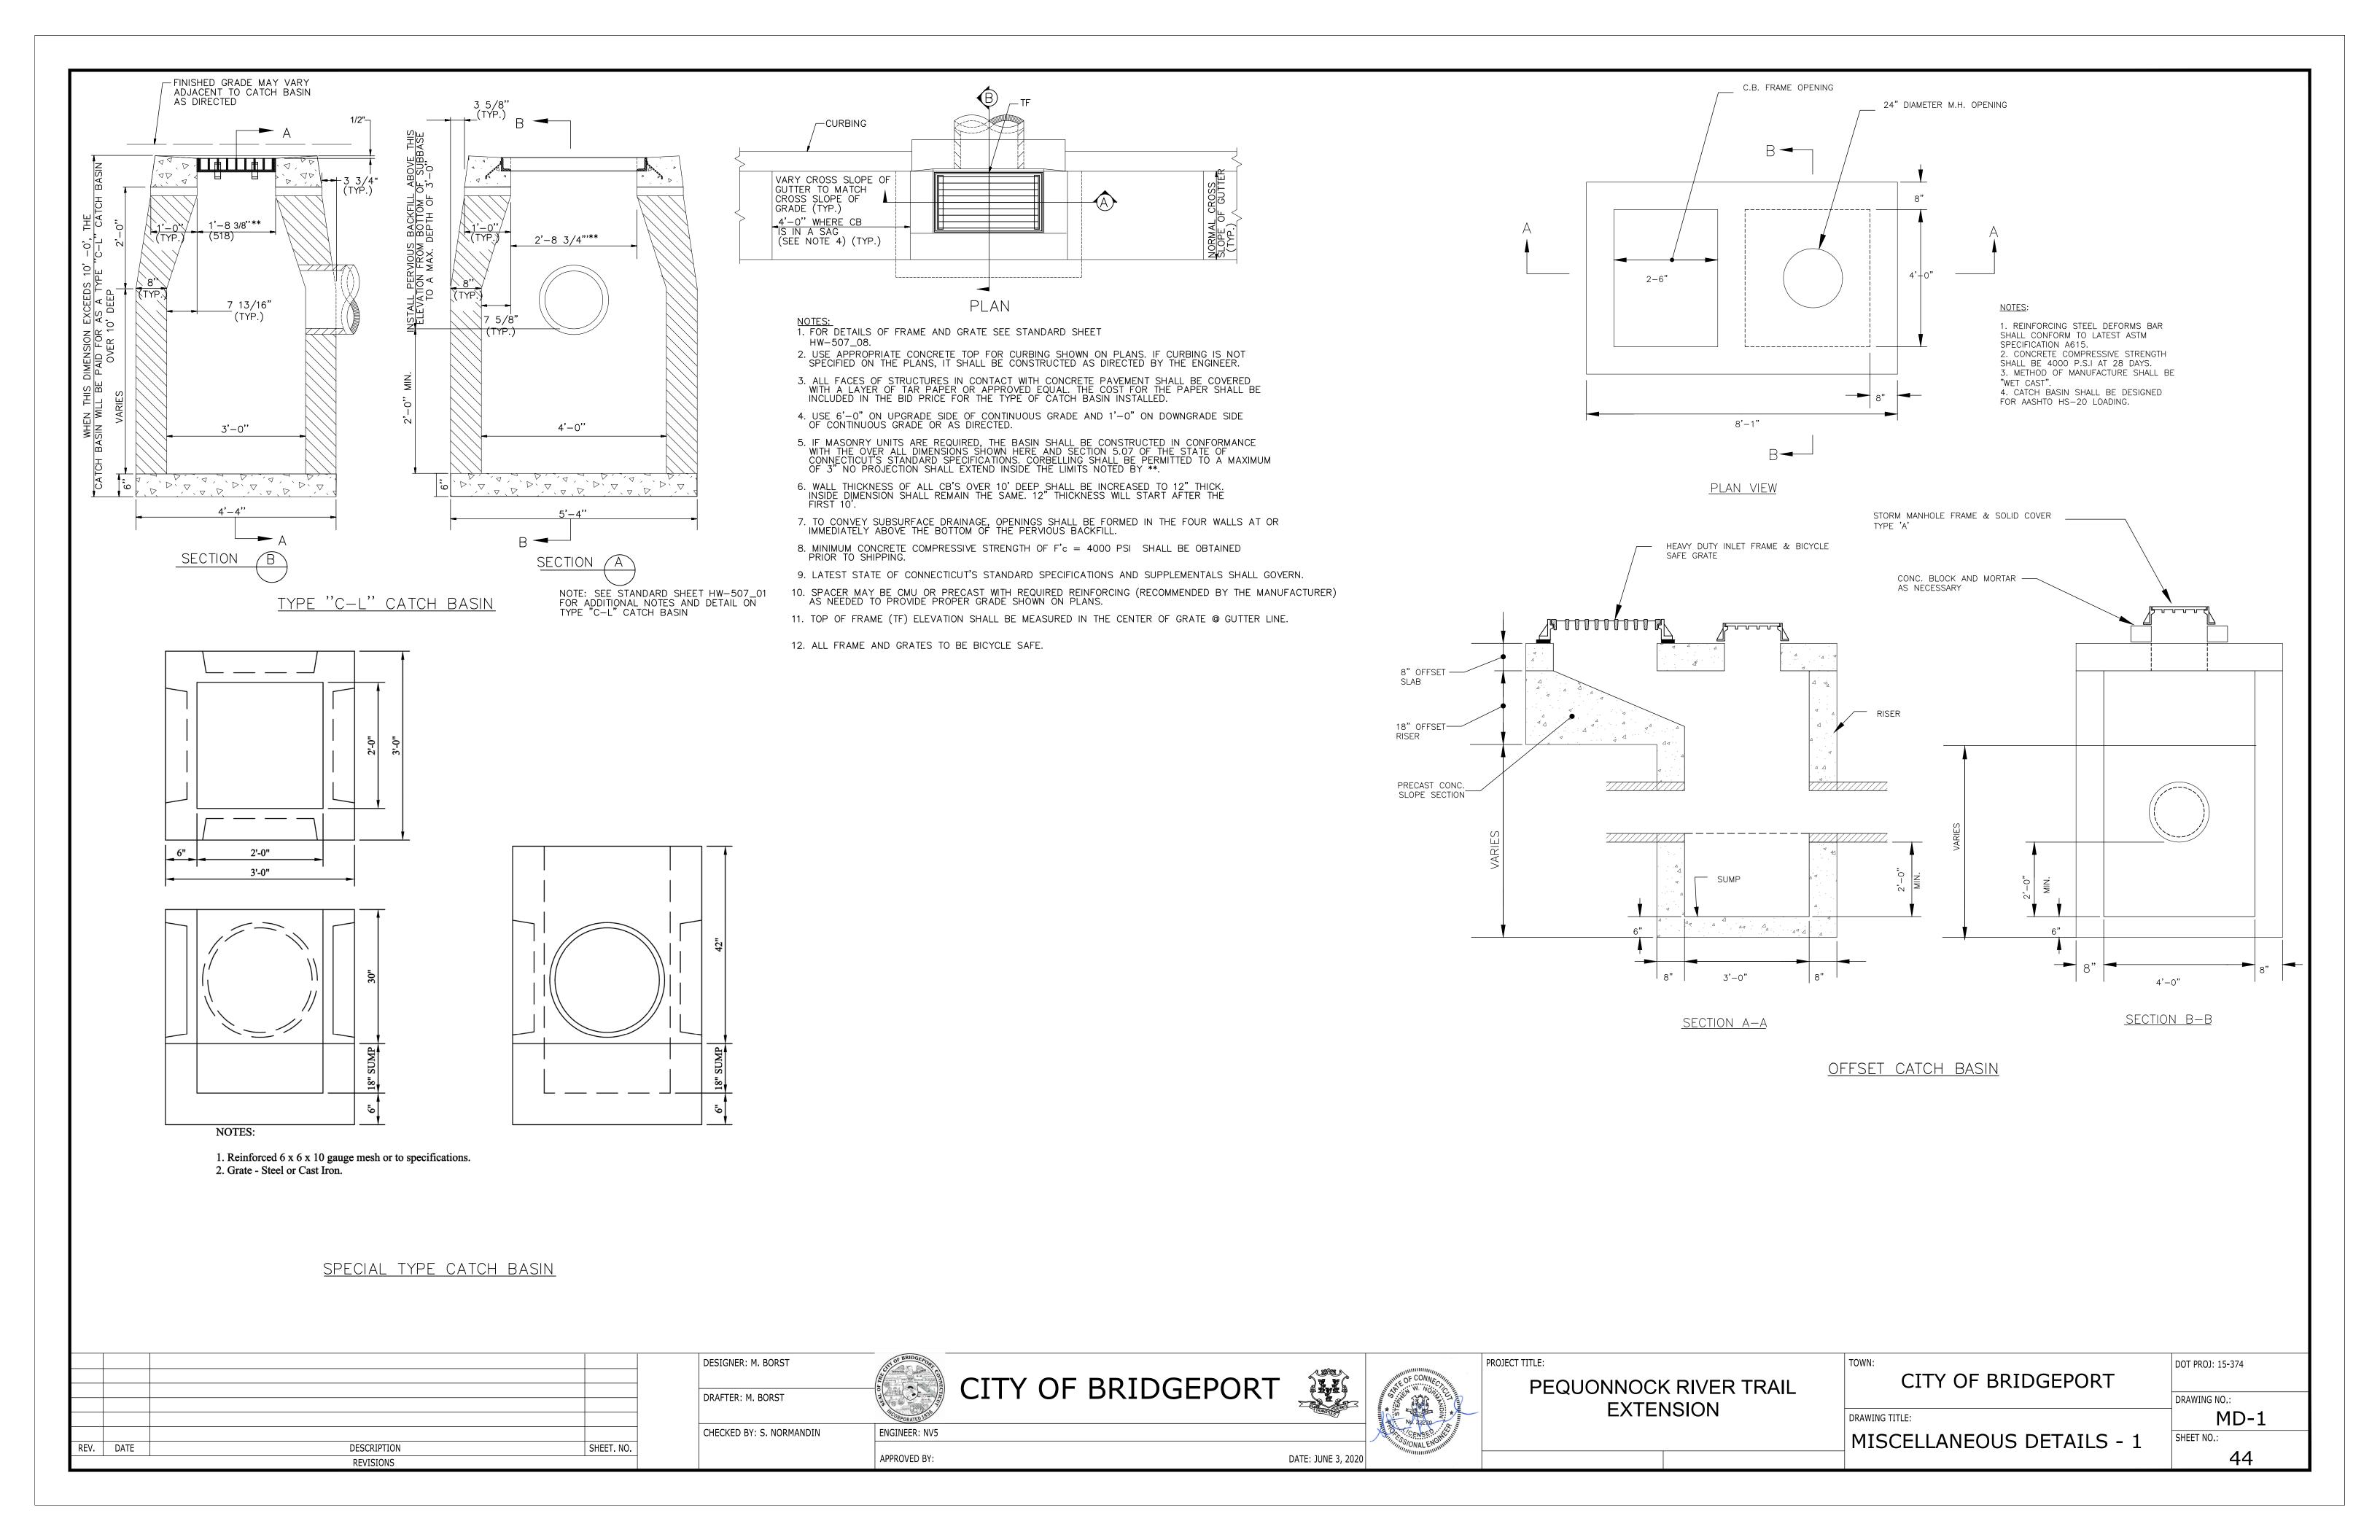


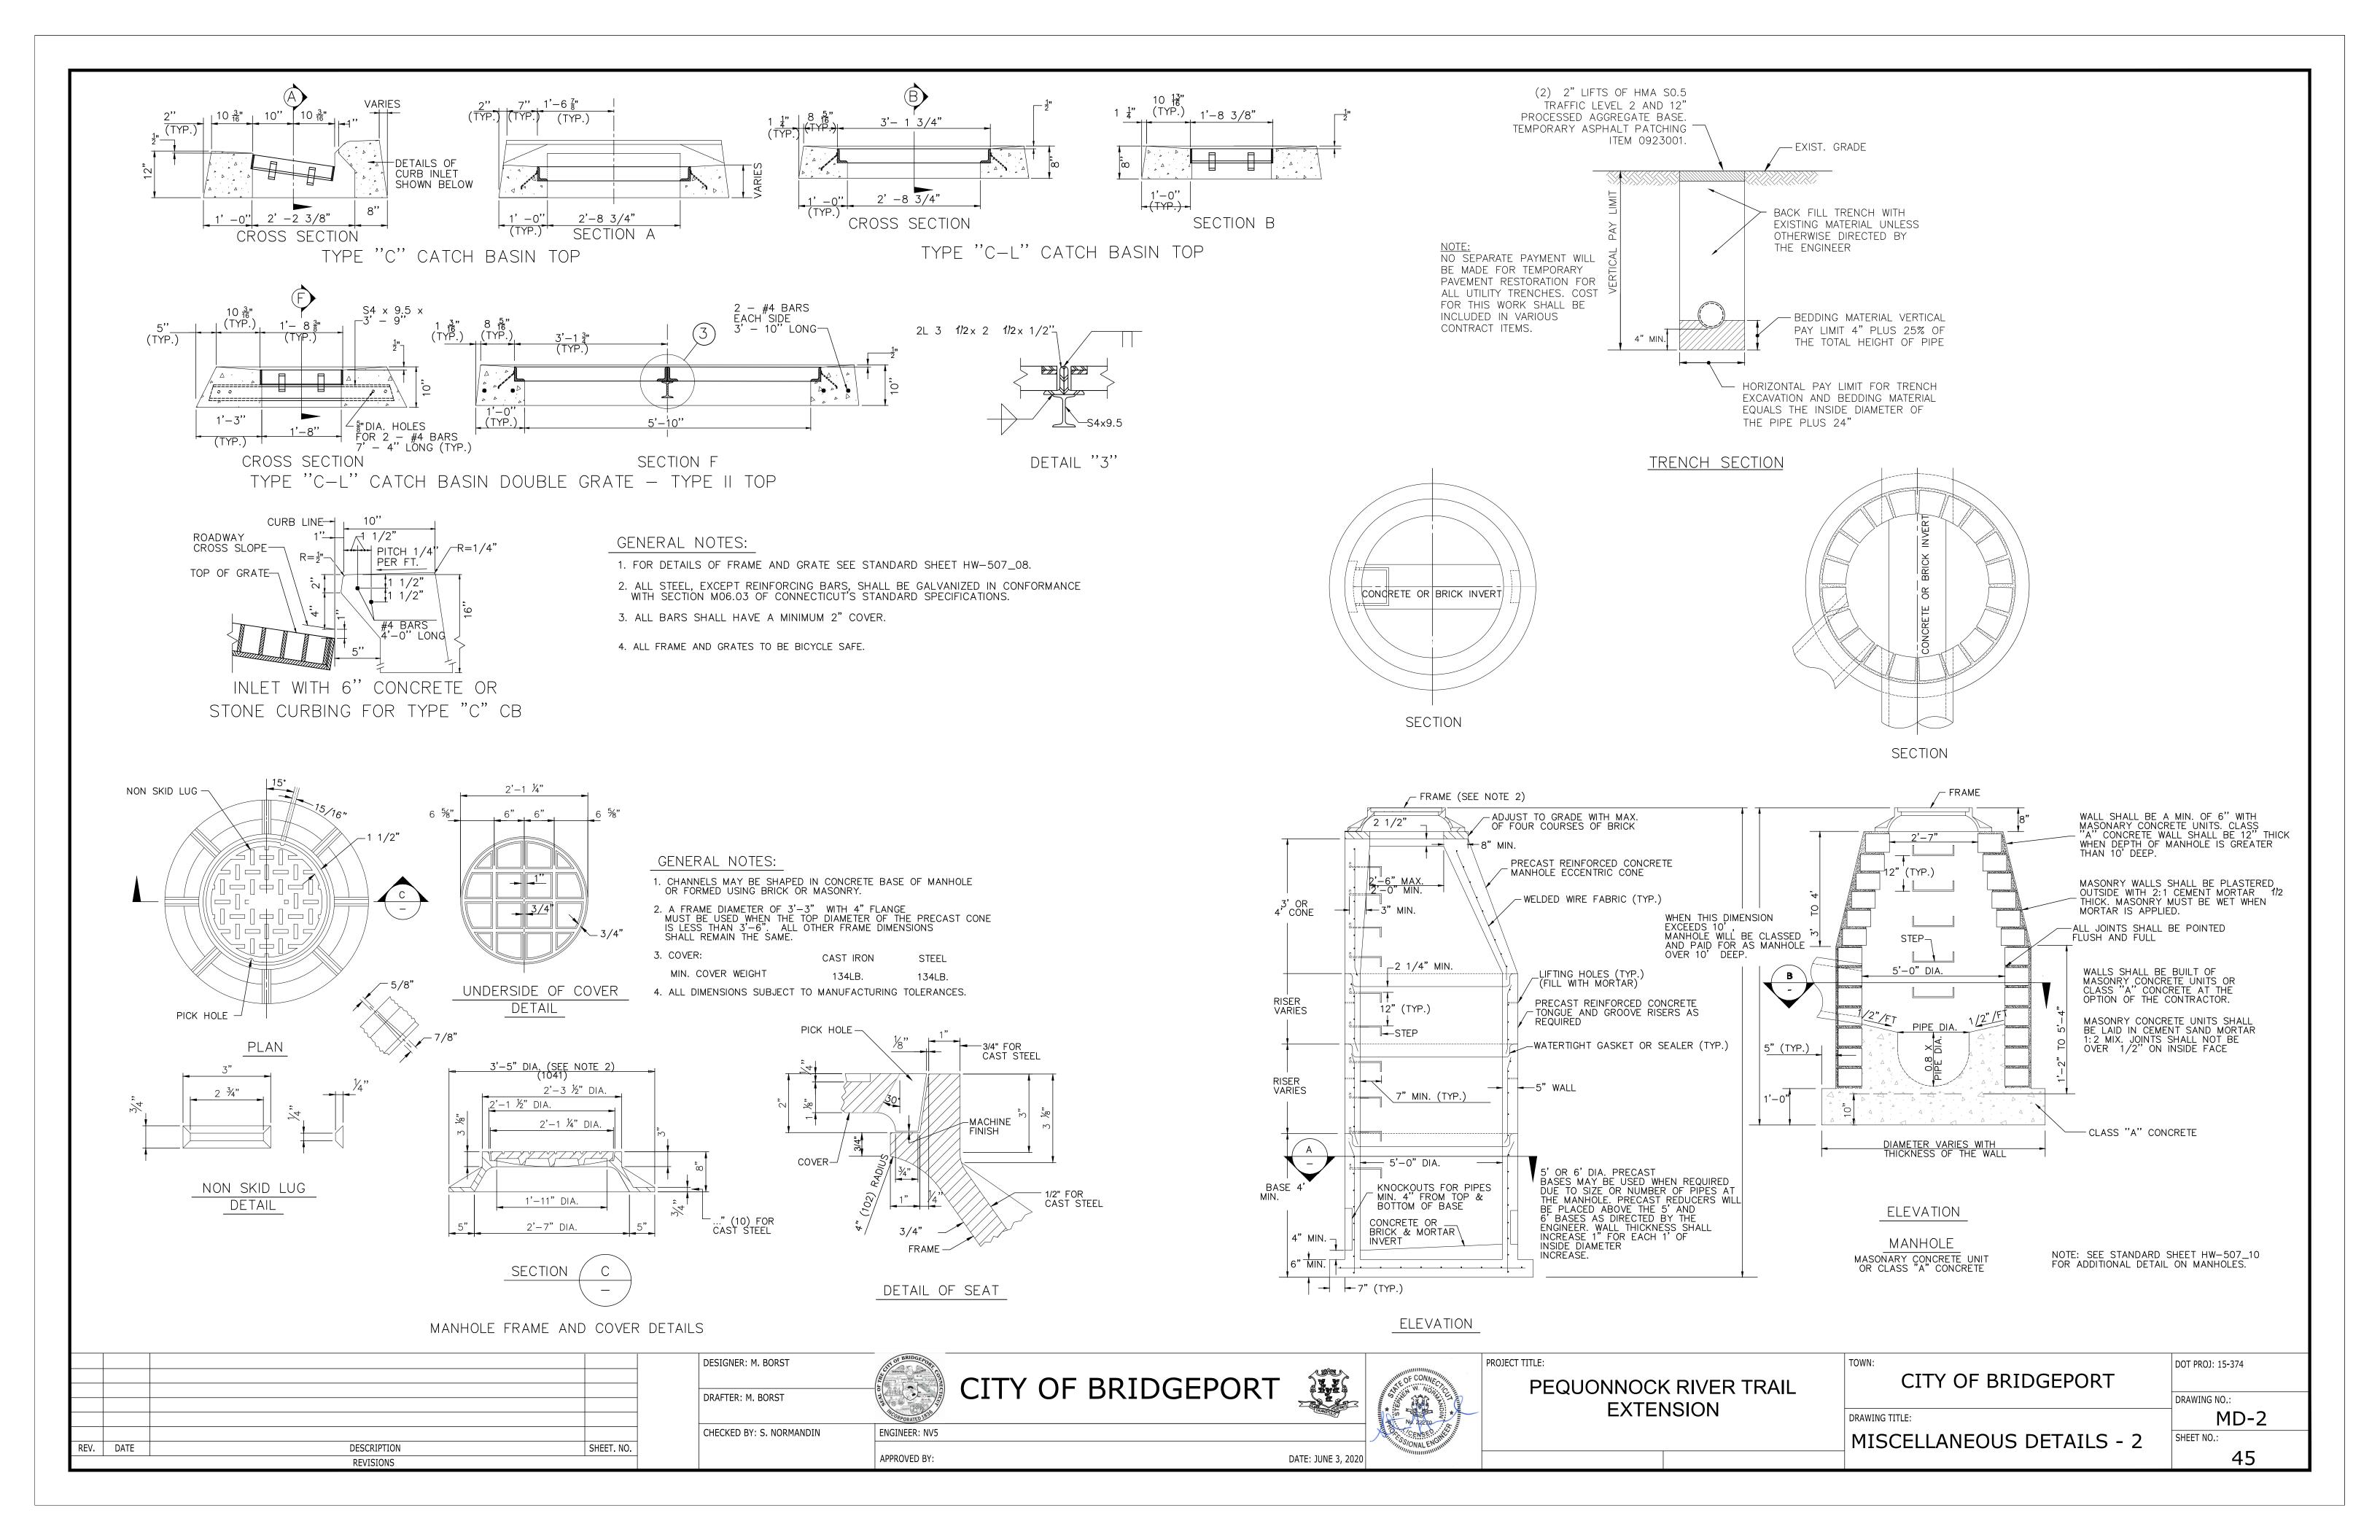


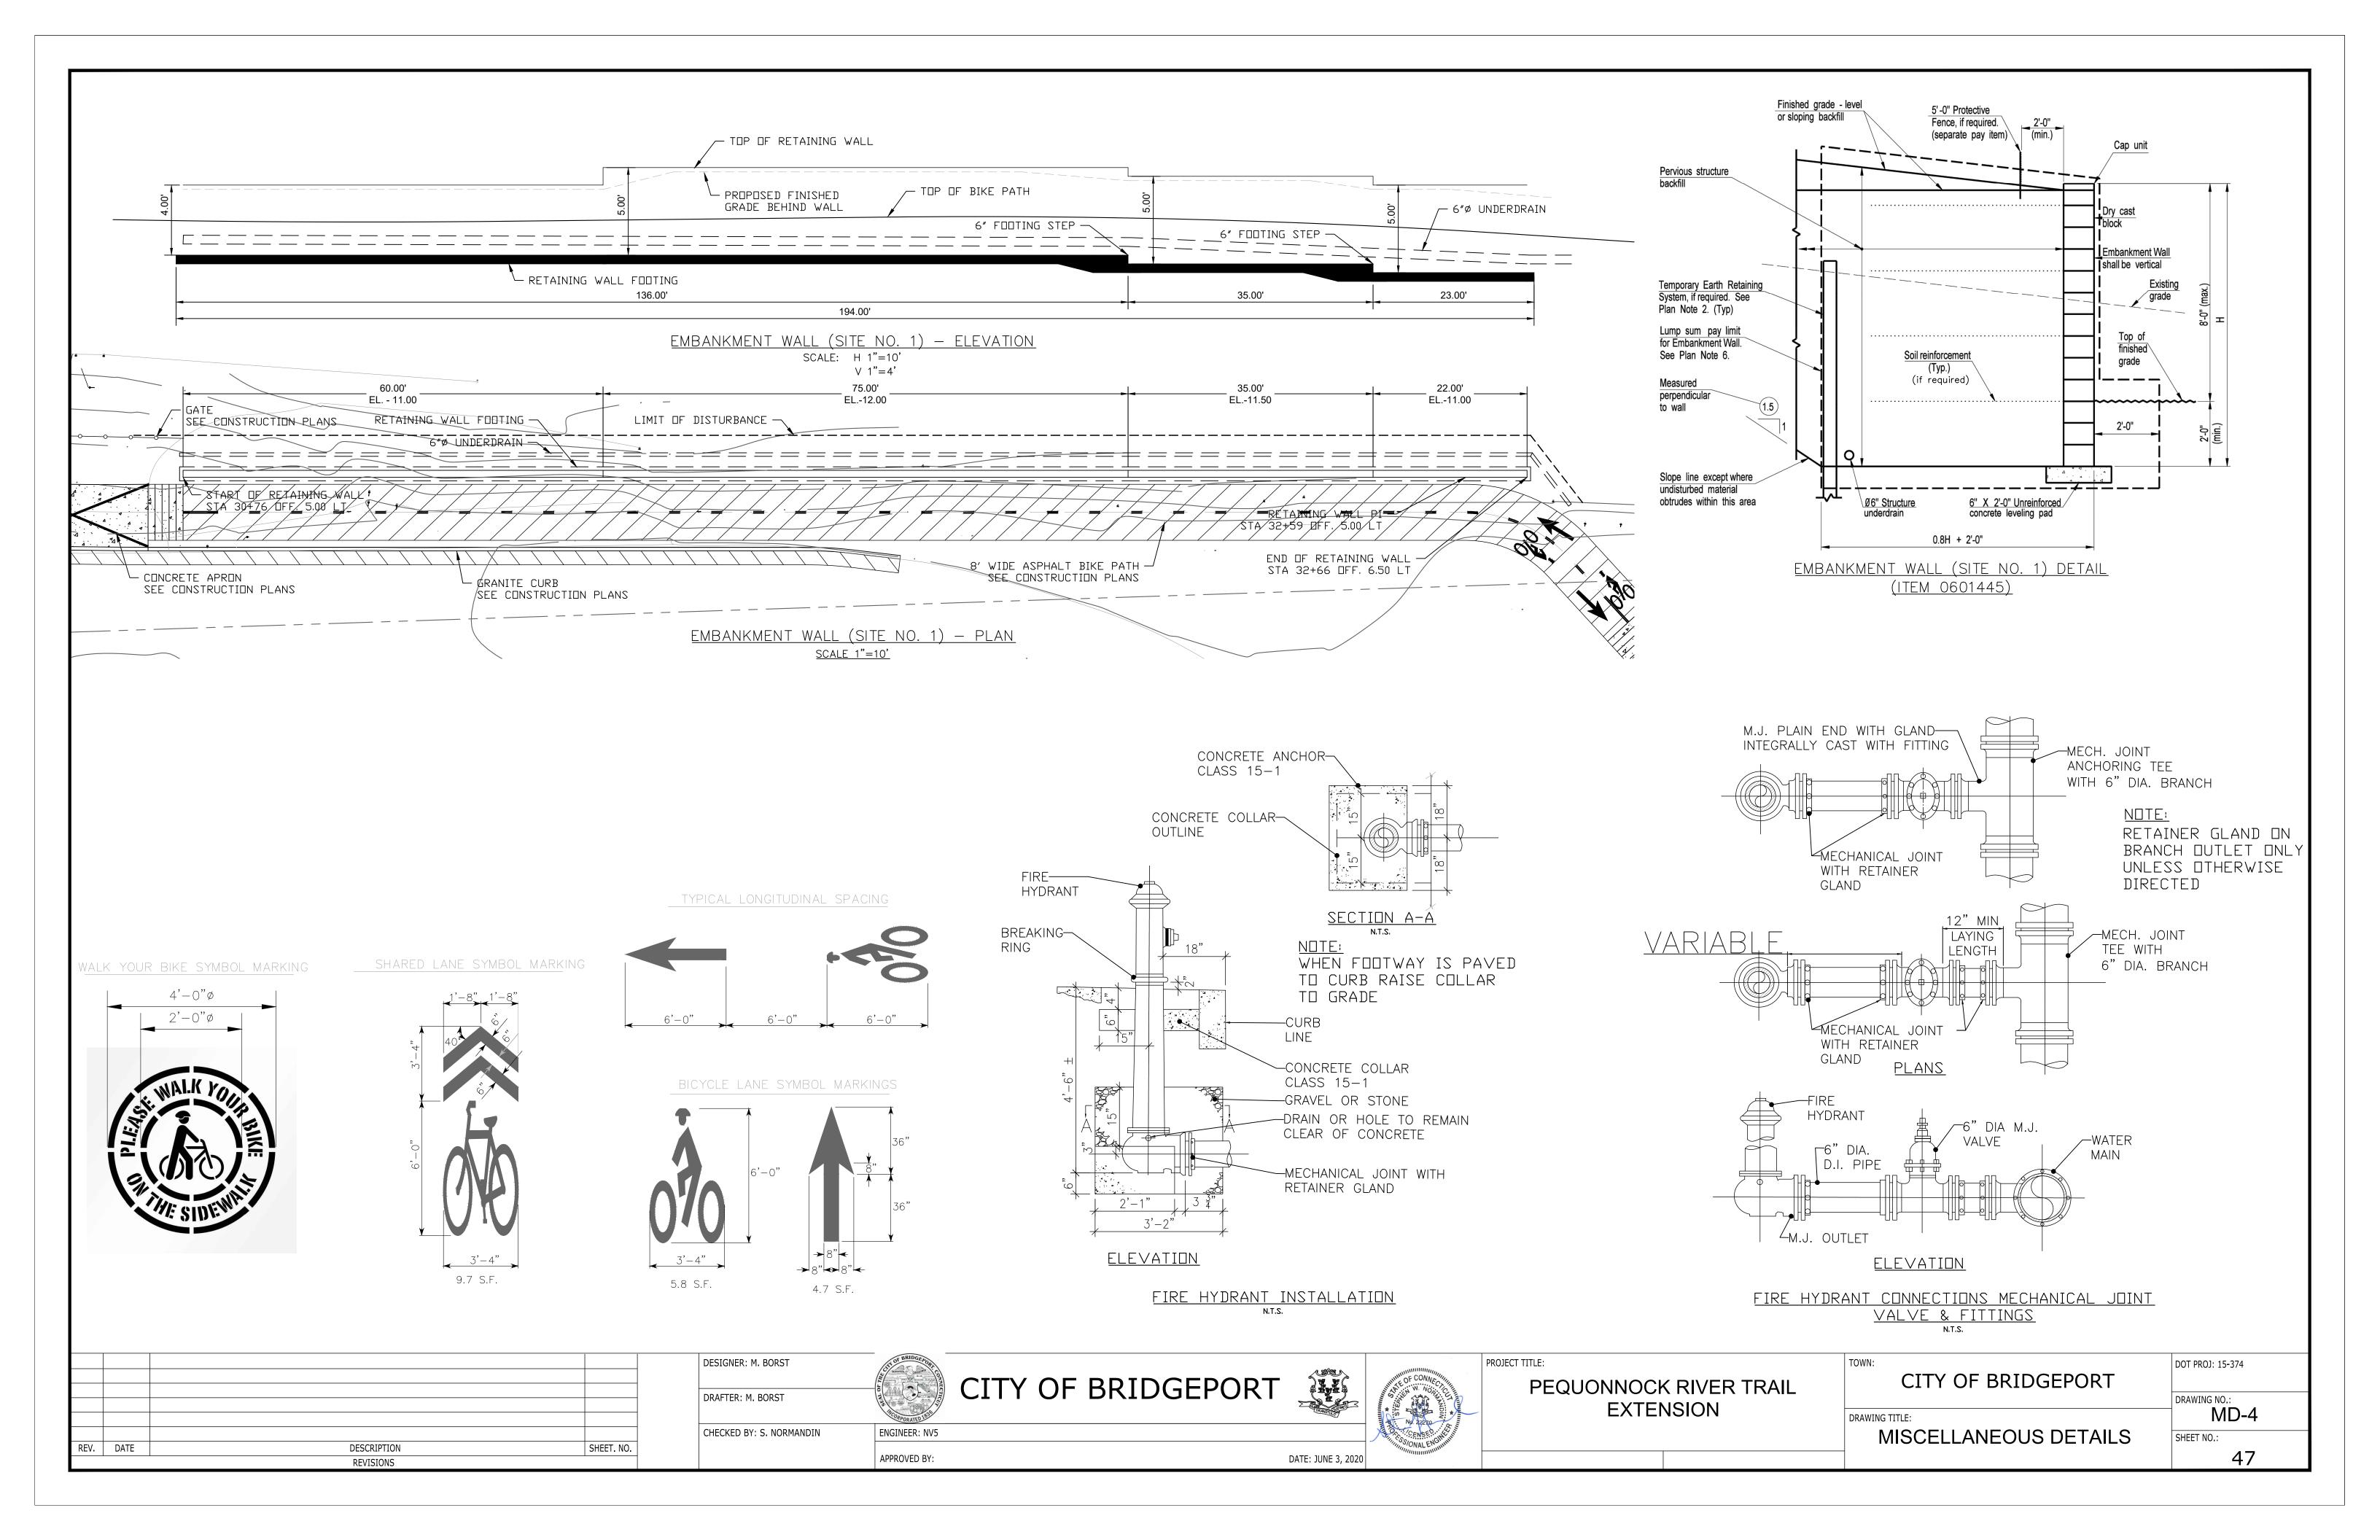


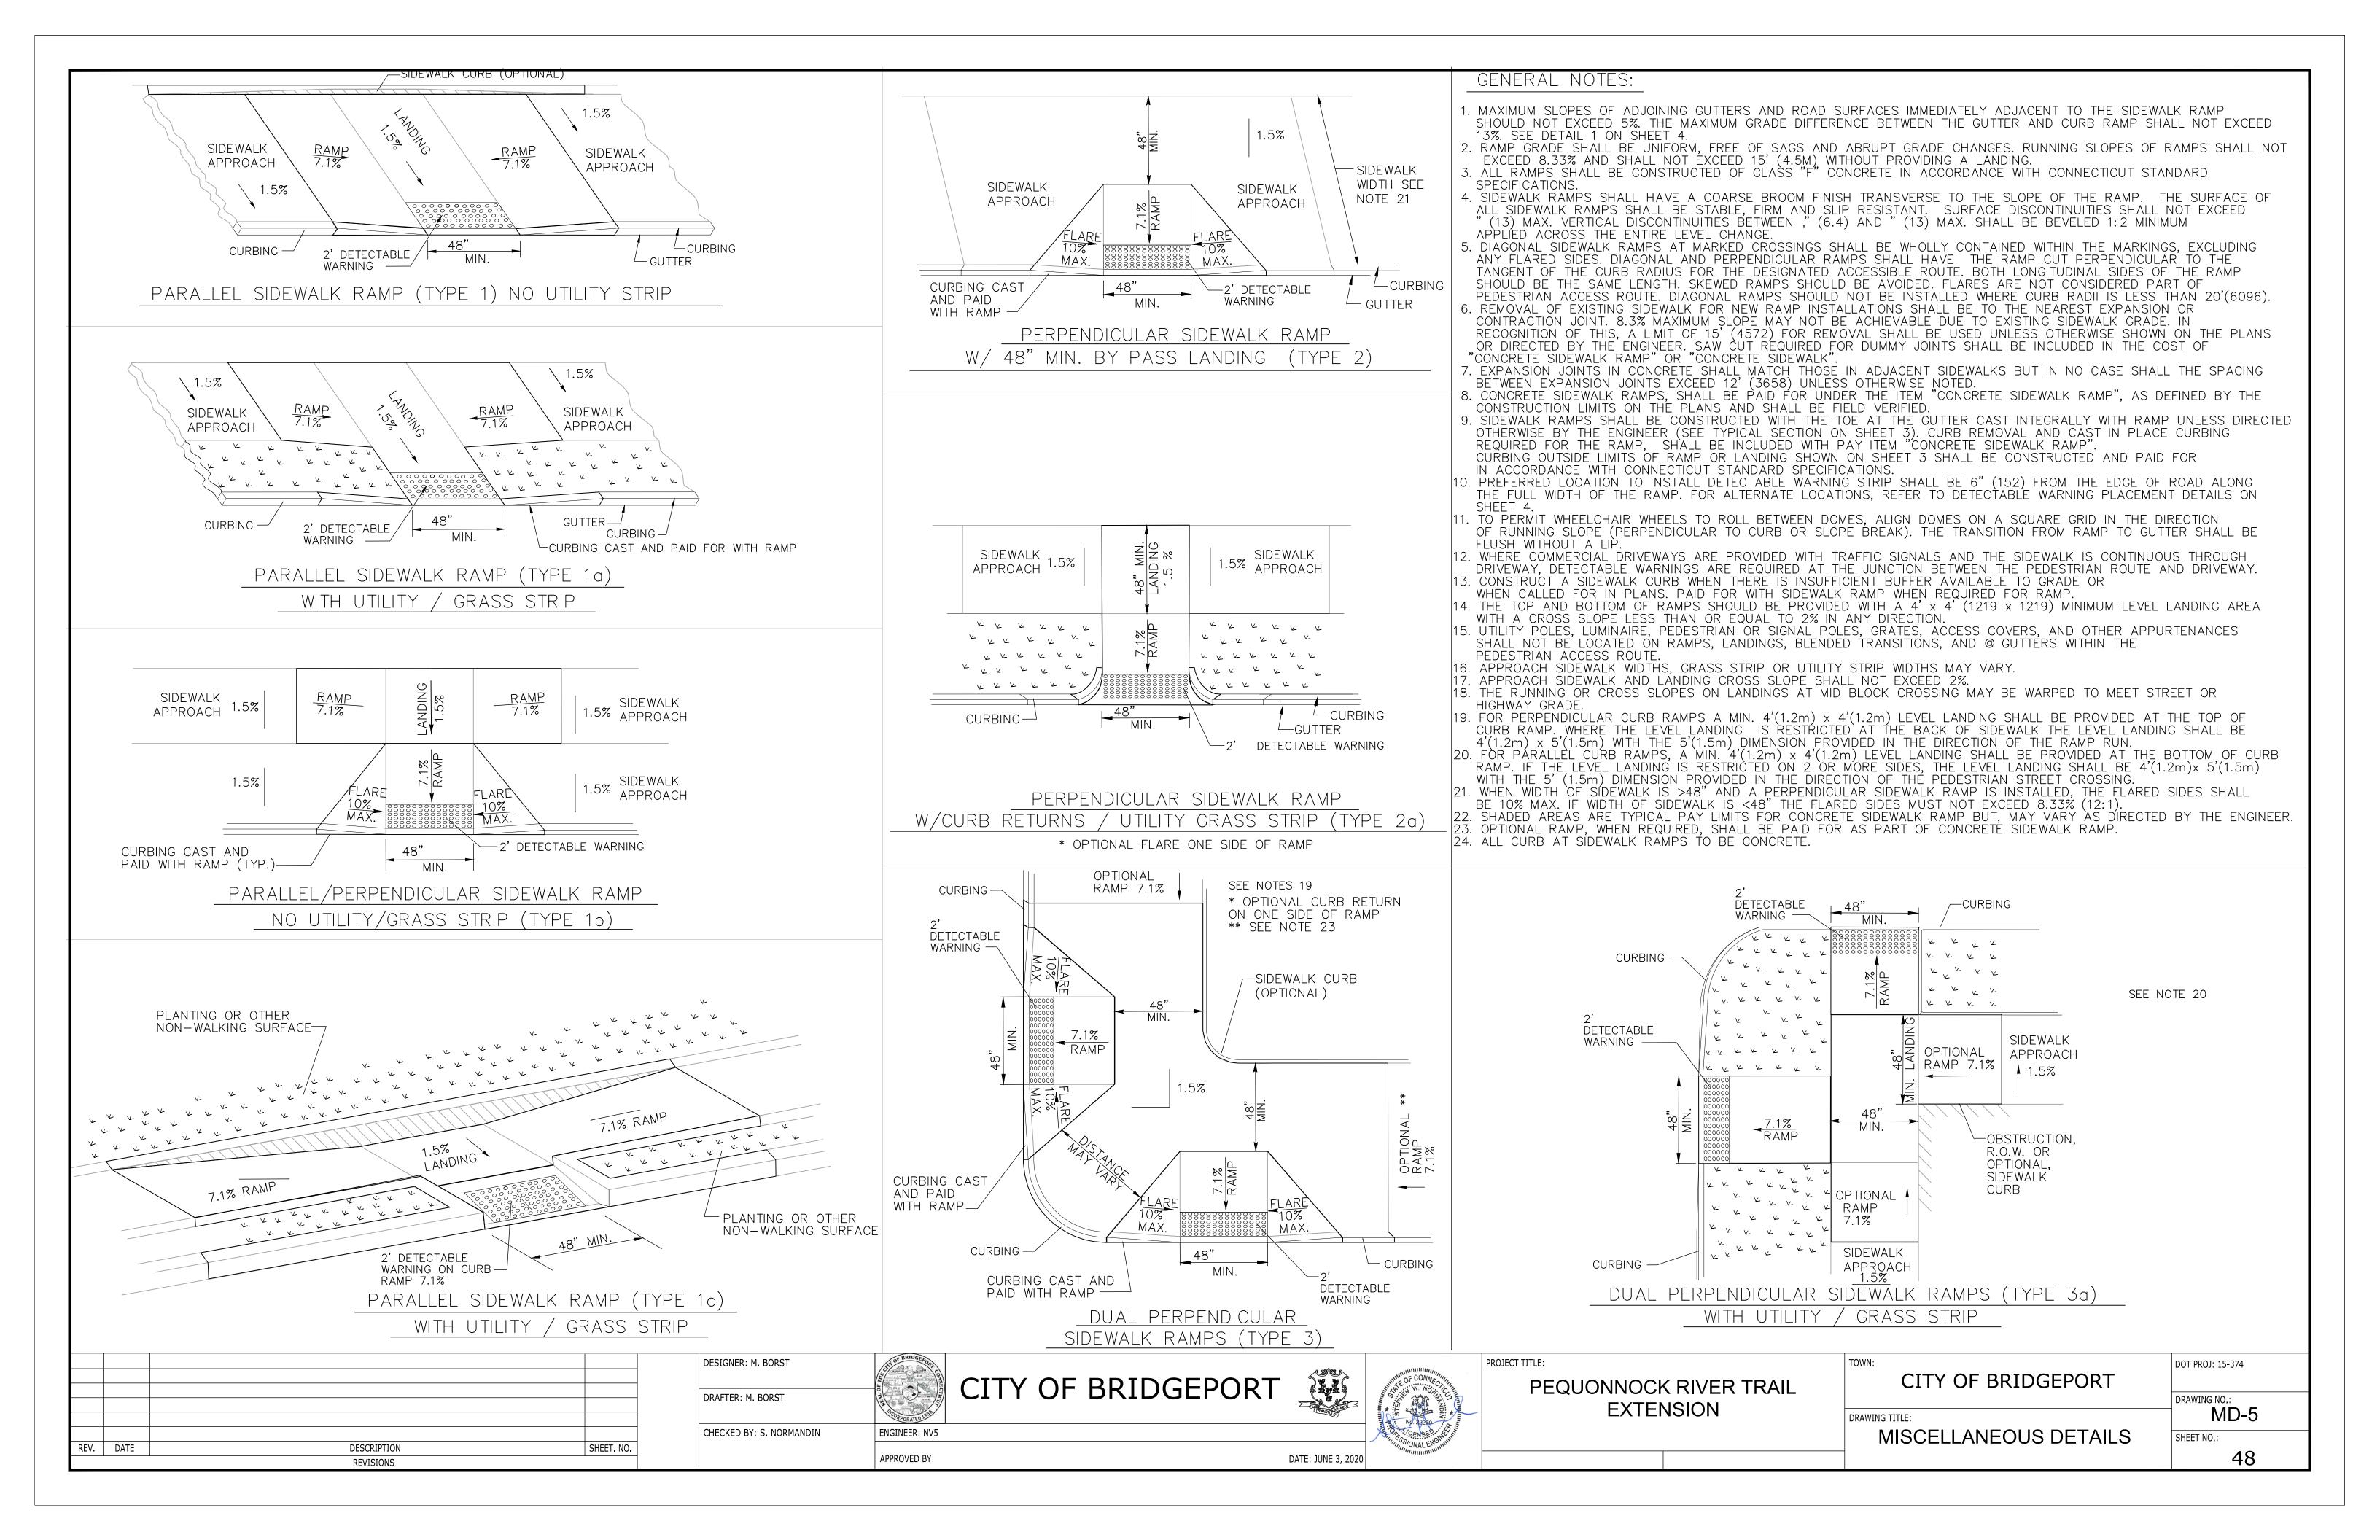

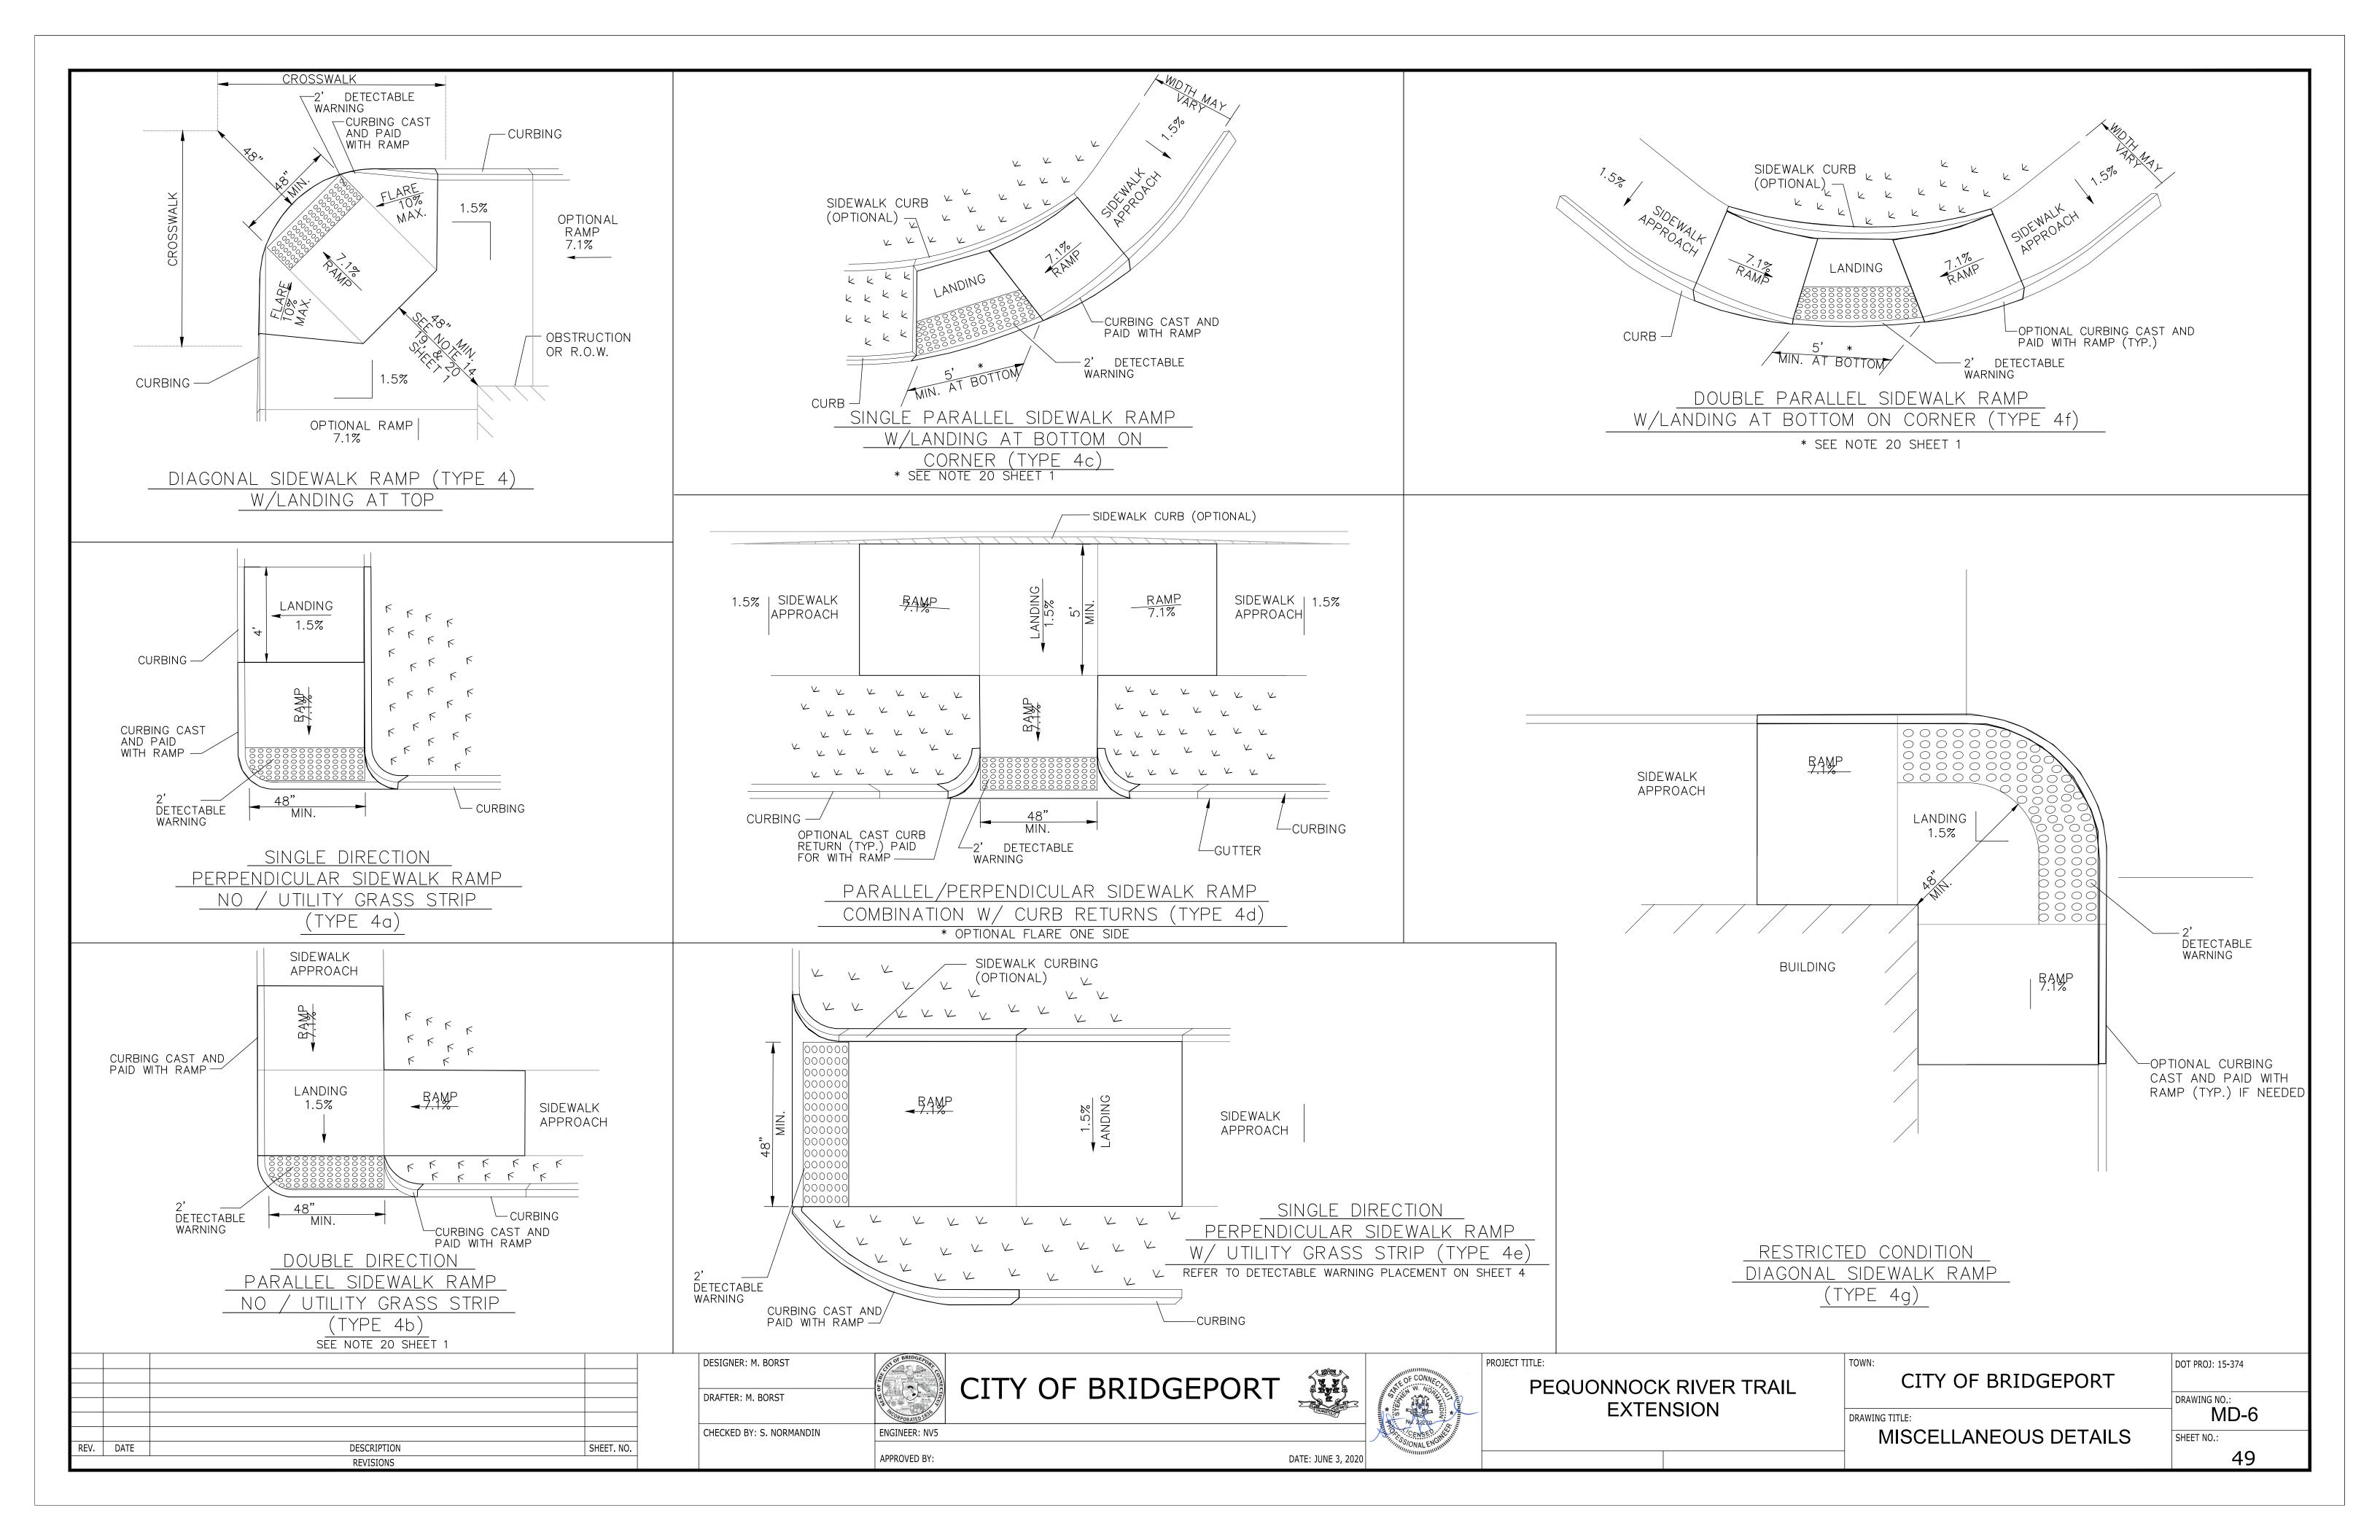


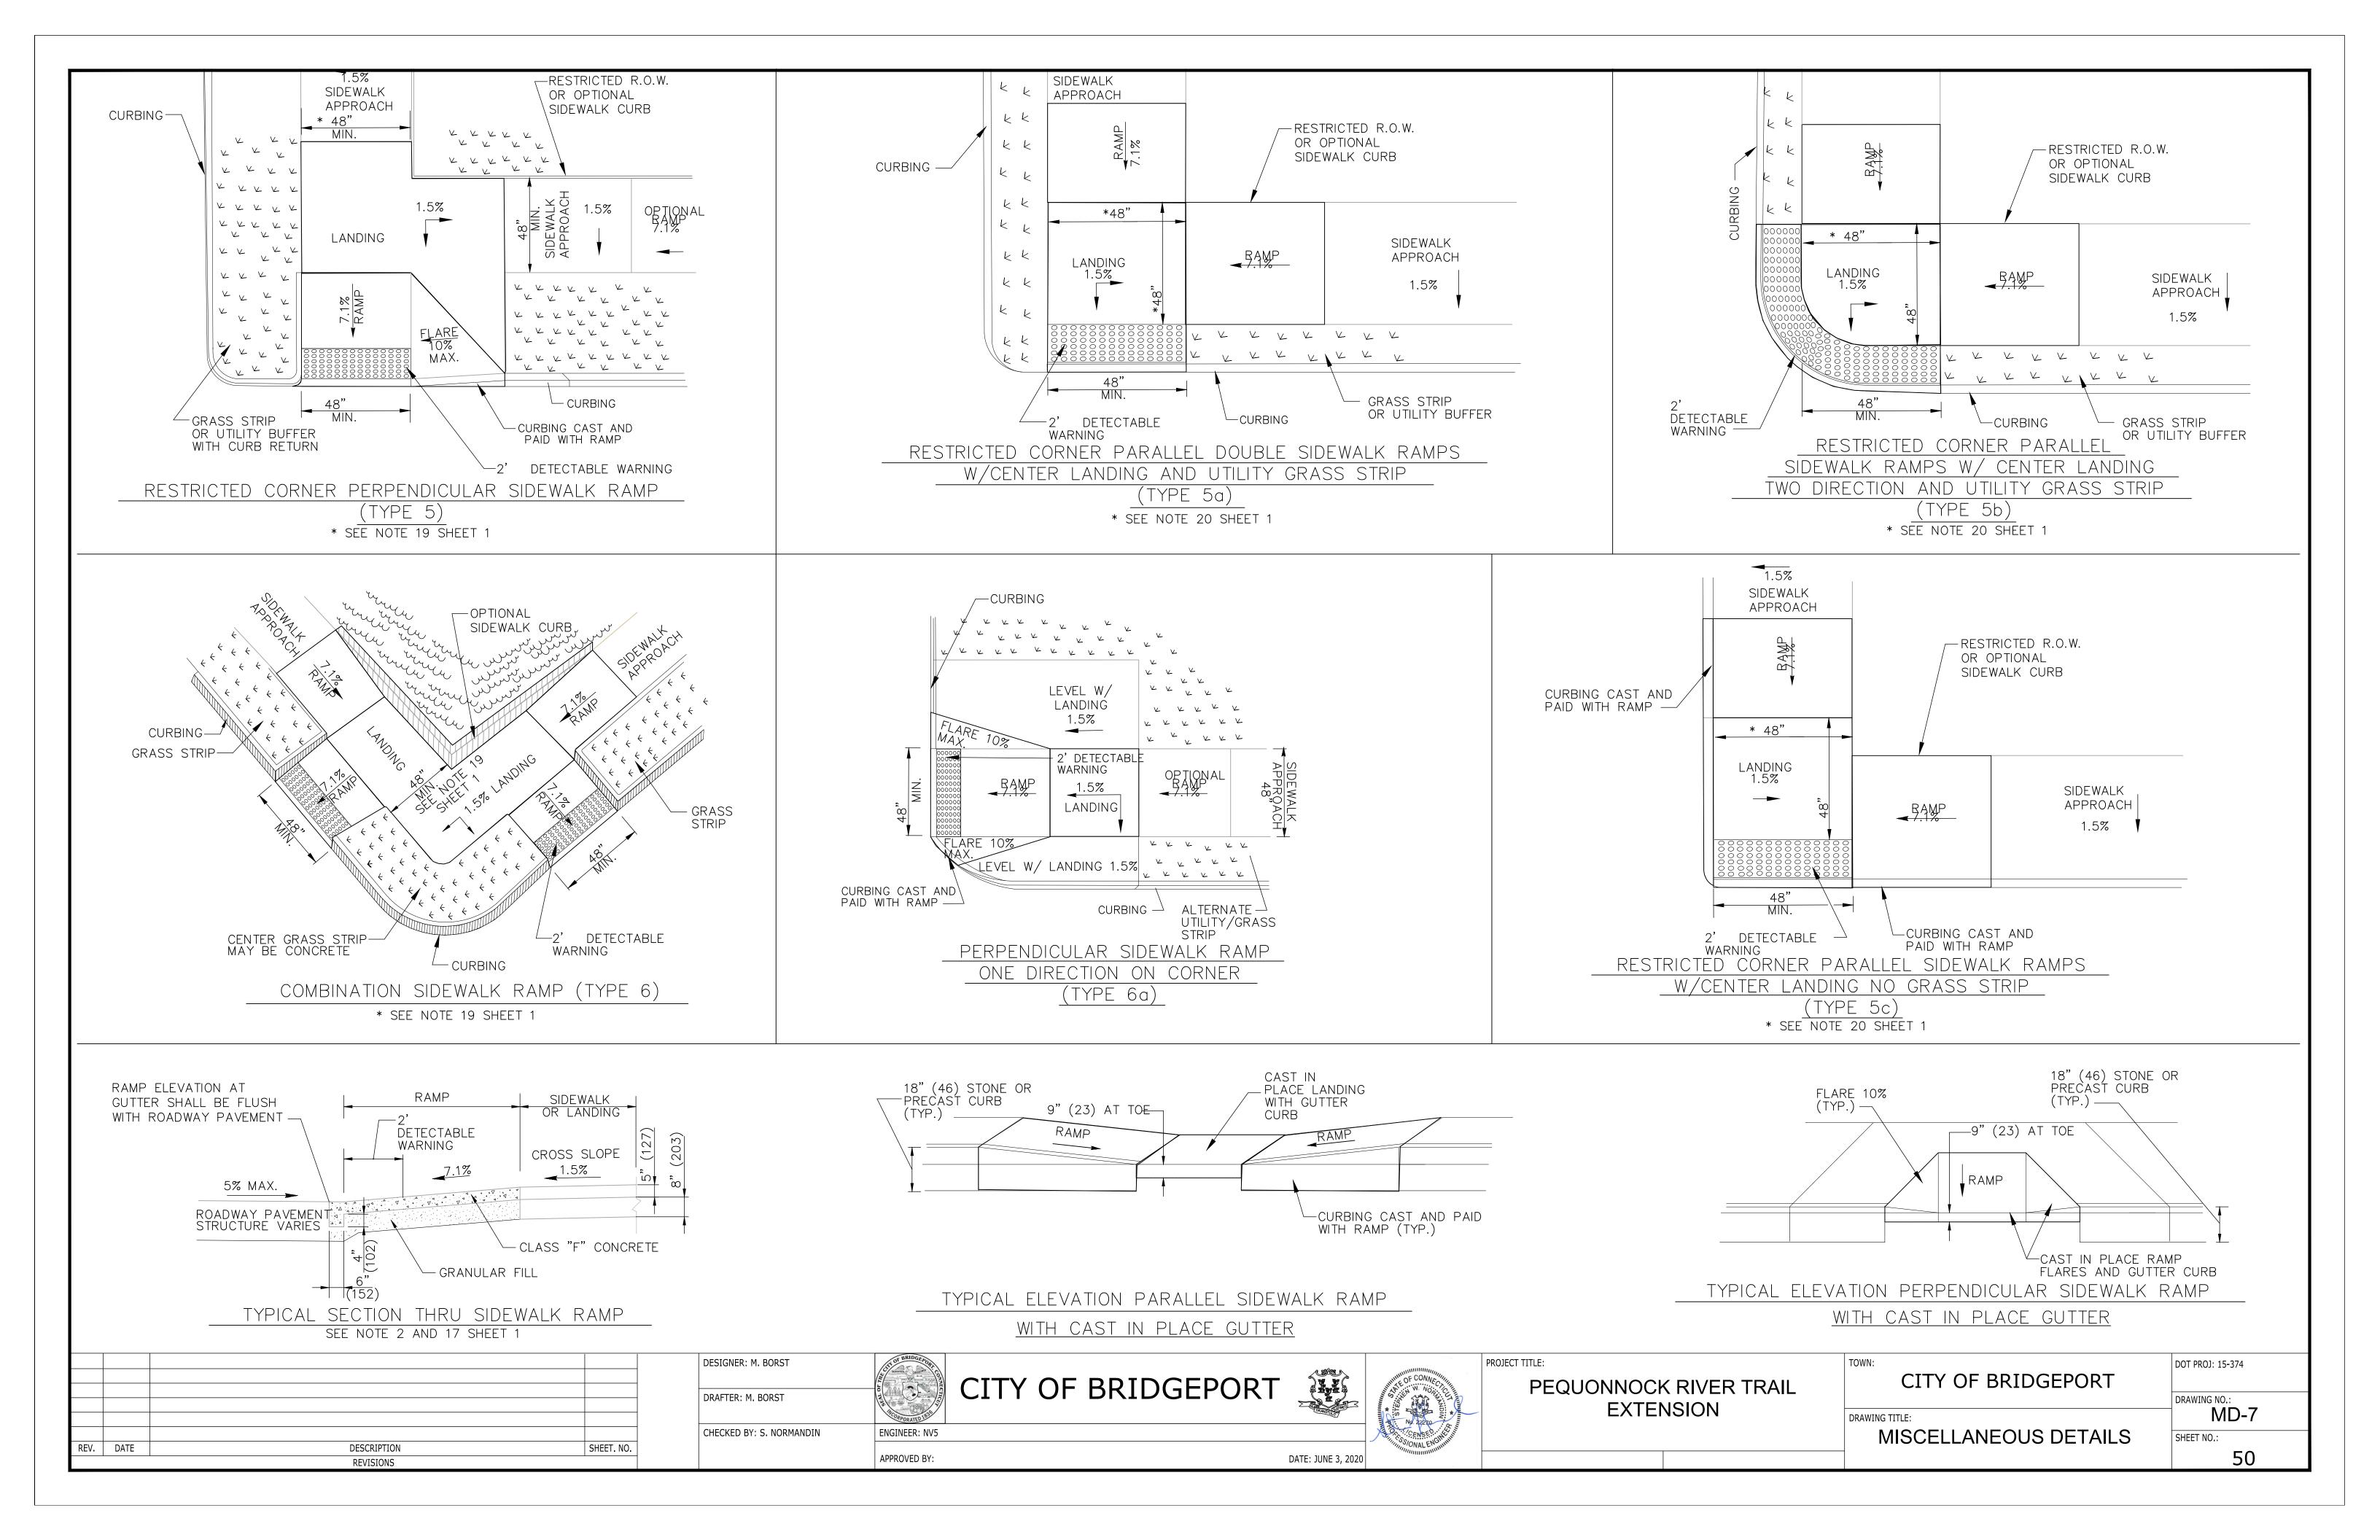

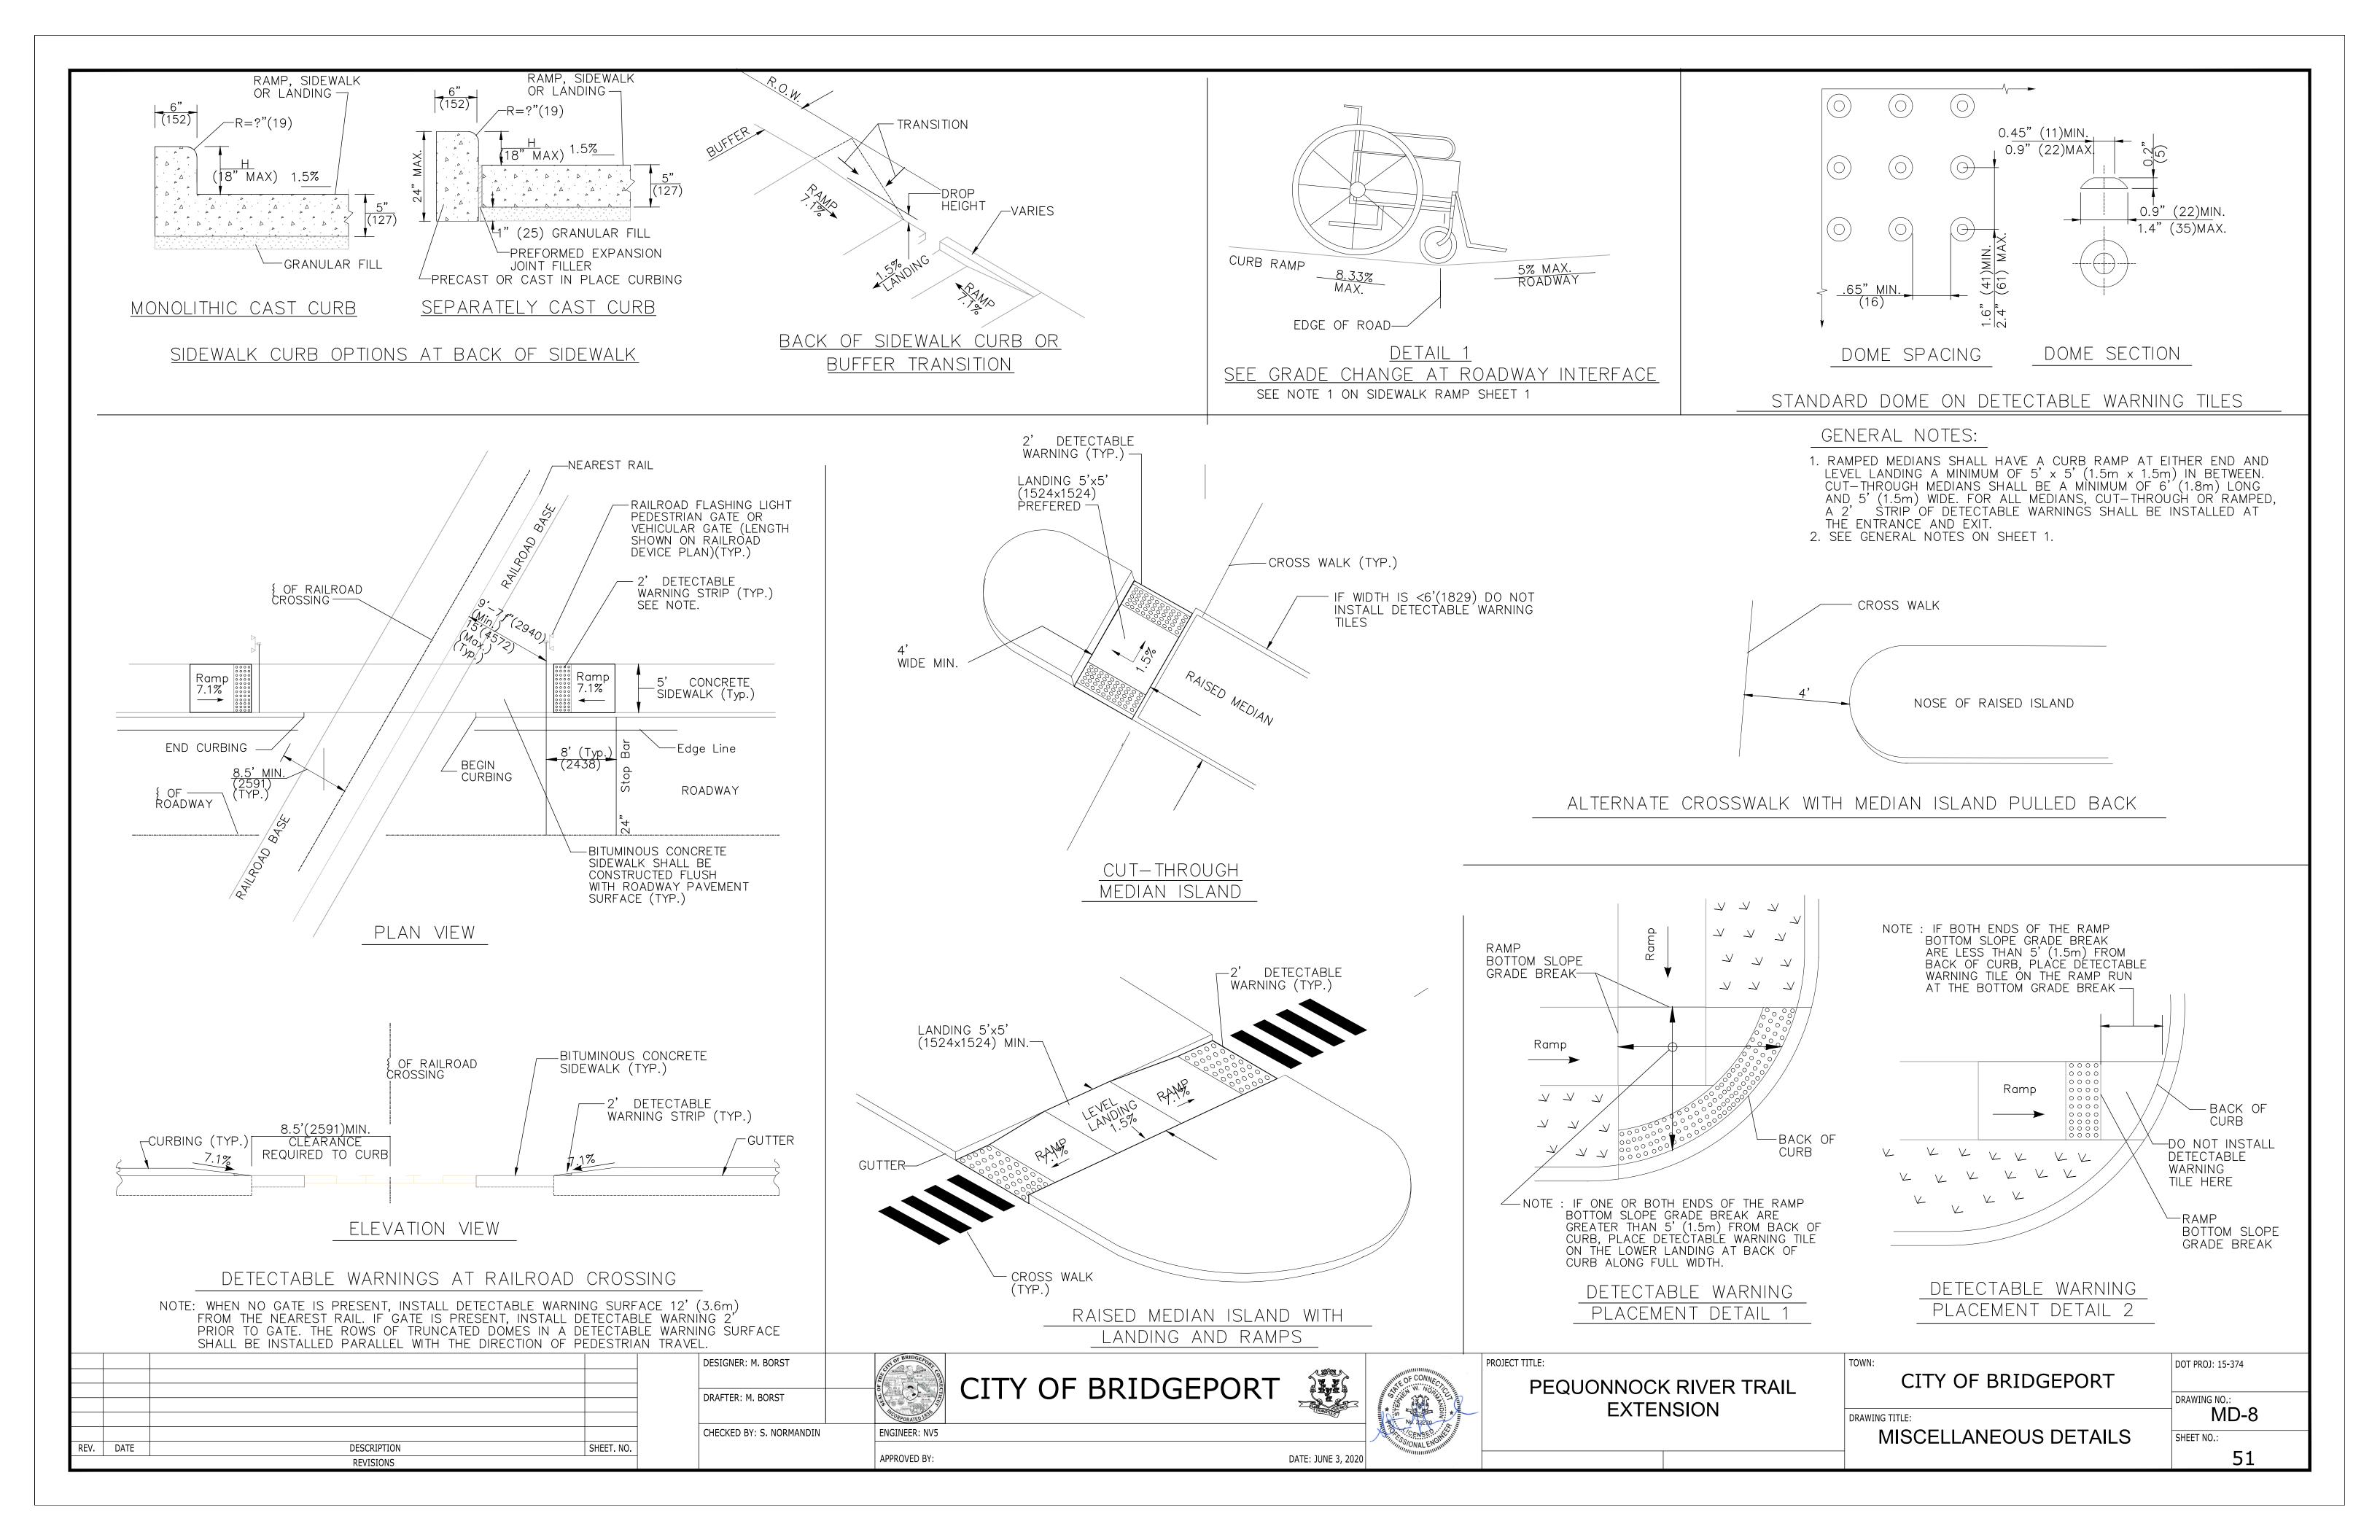

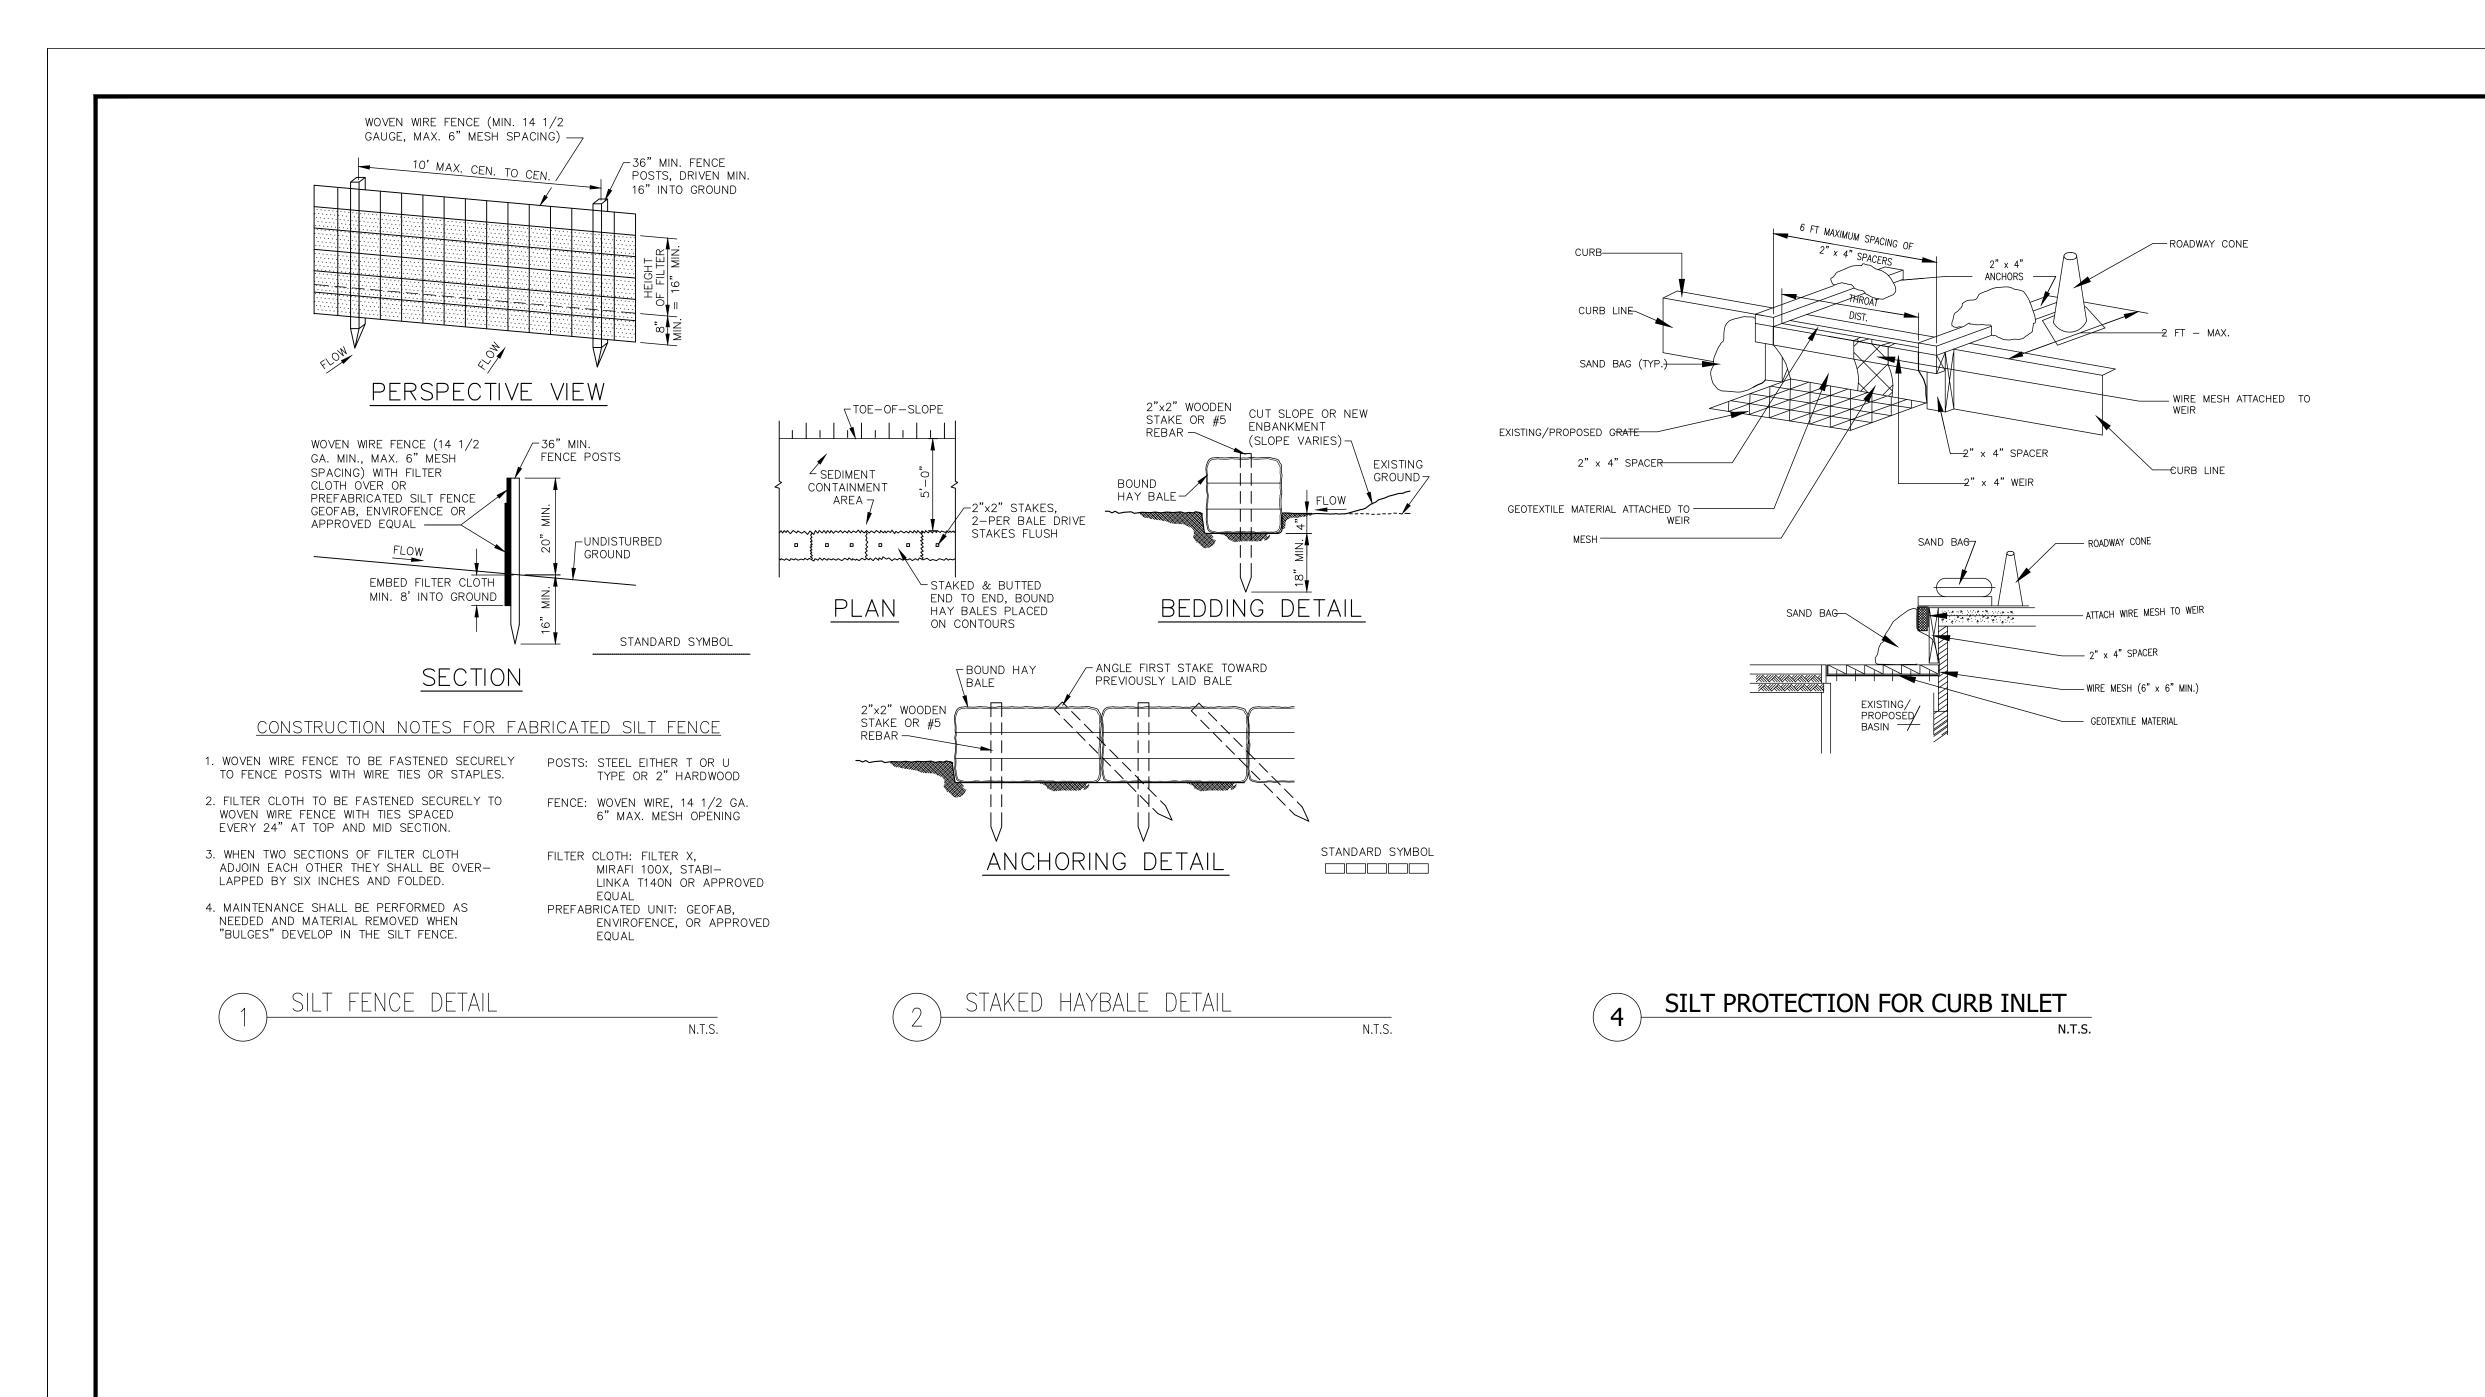


REV.	DATE	DESCRIPTION	SHEET. NO.	
		REVISIONS		

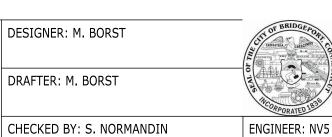

APPROVED BY:

CITY OF BRIDGEPORT

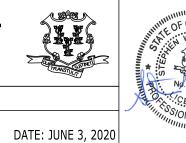



PEQUONNOCK RIVER TRAIL EXTENSION

:NWC		DOT PROJ:							
	CITY OF BRIDGEPORT								
		DRAWING N							
RAWING									
SEDIMENTATION AND EROSION									

CONTROL - 1

DOT PROJ: 15-374

DRAWING NO.:

SEC-1

SHEET NO.:

52

SIGN	LOCATION NUMBER	ITEM	TOTAL	AREA	GN DATA TA		M.U.T.C.D.	CTDOT	COLO	R OF	TYPE OF
NUMBER	LOCATION NUMBER		NUMBER	(SF)	QUANTITY	(IN)	NUMBER	NUMBER	BACKGROUND	LEGEND	MOUNTING
1	1,3,4,5,6,8,9,10,11,14,15,16,17,18,19,20,2 4,35,41,42,44,47,48,49,50,52,53,86,87,88, 89,90,91	1208931A	33	6.25 SF	206.25 SF	30 x 30	W11-1	41-4840	FLUORESCENT YELLOW/GREEN	BLACK	GROUND MOUNTED SINGLE POST
2	1,3,4,5,6,8,9,10,11,14,15,16,17,18,19,35,4 1,42,44,47,48,49,50,52,53,86,87,88,89,90, 91	1208931A	31	2.00 SF	62.00 SF	24 x 12	W16-1P(CT)	41-4849	FLUORESCENT YELLOW/GREEN	BLACK	GROUND MOUNTED SINGLE POST
3	2,7,12,13,21,22,23,25,26,30,32,33,36,55,5 6,58,62,63,72,74,75,80,83,85,92,94,96a,96 b,98,100,101,103	1208931A	32	3.00 SF	96.00 SF	24 x 18	D11-1	51-1354	GREEN	WHITE	GROUND MOUNTED SINGLE POST
4	2,21	1208931A	2	0.75 SF	1.50 SF	12 x 9	M6-2L	51-2668L	GREEN	WHITE	GROUND MOUNTED SINGLE POST
5	7,12,32,58,72,75,85,94,100,103	1208931A	10	0.75 SF	7.50 SF	12 x 9	M6-1R	51-2666R	GREEN	WHITE	GROUND MOUNTED SINGLE POST
6	2,7,12,13,21,22,32,33,36,55,56,58,62,63,7 2,74,75,80,83,85,92,94,96a,96b,98,100,10 1,103	1208931A	28	0.79 SF	21.98 SF	12 DIA.	CUSTOM		BLUE	WHITE	GROUND MOUNTED SINGLE POST
7	13,33,36,56,74,80,83,92,98,101	1208931A	10	0.75 SF	7.50 SF	12 x 9	M6-1L	51-2666L	GREEN	WHITE	GROUND MOUNTED SINGLE POS
8	22,55,62,63,96a,96b	1208931A	6	0.75 SF	4.50 SF	12 x 9	M6-3	51-2665	GREEN	WHITE	GROUND MOUNTED SINGLE POST
9	23,25,26,30,57,61,71,78	1208931A	8	4.00 SF	32.00 SF	24 x 24	R5-3	31-1727	WHITE	BLACK	GROUND MOUNTED SINGLE POS
10	27,81,82	1208931A	3	1.50 SF	4.50 SF	12 x 18	R7-9A		WHITE	RED/BLACK	GROUND MOUNTED SINGLE POS
11	25b,28,74b,74c,74d,74e,74f,74g,74h,74i,7 4j,74k,74l,74m,79a,79b	1208931A	16	1.50 SF	24.00 SF	12 x 18	R7-1	31-0630	WHITE	RED	GROUND MOUNTED SINGLE POS
12	29,59,60,73,77,102	1208931A	6	2.25 SF	13.50 SF	18 x 18	R1-1	31-0532	RED	WHITE	GROUND MOUNTED SINGLE POS
13	12b,29,39,59,60,73,77,79,84,93,99,105	1208931A	12	3.75 SF	45.00 SF	30 x 18	CUSTOM		WHITE	BLACK	GROUND MOUNTED SINGLE POS
14	31	1208931A	1	6.75 SF	6.75 SF	54 x 18	R6-1R	31-1178	WHITE	BLACK	GROUND MOUNTED SINGLE POS
15	31	1208931A	1	6.75 SF	6.75 SF	54 x 18	R6-1L	31-1189	WHITE	BLACK	GROUND MOUNTED SINGLE POS
16	31	1208931A	1	6.25 SF	6.25 SF	30 x 30	R5-1	31-1119	RED	WHITE	GROUND MOUNTED SINGLE POS
20	57,61,71,78	1208931A	4	3.00 SF	12.00 SF	24 x 18	CUSTOM		GREEN	WHITE	GROUND MOUNTED SINGLE POS
21	76	1208931A	1	6.25 SF	6.25 SF	30 x 30	R1-1	31-0552	RED	WHITE	GROUND MOUNTED SINGLE POS
22	95,97	1208931A	2	7.50 SF	15.00 SF	36 x 30	R4-4	31-0504	WHITE	BLACK	GROUND MOUNTED SINGLE POS
23	96	1208931A	1	7.50 SF	7.50 SF	36 x 30	R3-8	31-0283	WHITE	BLACK	GROUND MOUNTED SINGLE POS
24	95a,96c,96d,104	1208931A	4	2.00 SF	8.00 SF	24 x 12	R3-7BP	31-0505	WHITE	BLACK	GROUND MOUNTED SINGLE POS
25	20,24	1208931A	2	2.00 SF	4.00 SF	24 x 12	W11-15P	41-4839	FLUORESCENT YELLOW/GREEN	BLACK	GROUND MOUNTED SINGLE POS
26	30a, 35a, 52b, 56b, 59b, 61b,62b,62c	1208931A	8	6.25 SF	50.00 SF	30 x 30	W11-1	41-4840	FLUORESCENT YELLOW/GREEN	BLACK	GROUND MOUNTED SINGLE POS
27	30a, 35a, 52b, 56b, 59b, 62b	1208931A	6	2.00 SF	12.00 SF	24 x 12	W16-9P	41-6126	FLUORESCENT YELLOW/GREEN	BLACK	GROUND MOUNTED SINGLE POS
28	61b,62c	1208931A	2	2.00 SF	4.00 SF	24 x 12	W16-7P	41-2617	FLUORESCENT YELLOW/GREEN	BLACK	GROUND MOUNTED SINGLE POS
29	95a,96c,96d	1208931A	3	9.00 SF	27.00 SF	36 x 36	R3-7	31-0123	WHITE	BLACK	GROUND MOUNTED SINGLE POS

DRAINAGE STRUCTURE #	STA	OFF	RIM		ITEM 0507006 TYPE "C" CATCH BASIN TOP (EA)	ITEM 0507010 TYPE "C-L" CATCH BASIN FRAME AND GRATE (EA)	TYPE "C" CATCH	ITEM 0507094 SPECIAL TYPE CATCH BASIN (EA)	TYPE 'C-L' CATCH	ITEM 0507224 TYPE "C-L" CATCH BASIN TOP (EA)	ITEM 0507316 TYPE "C-L" CATCH BASIN DOUBLE GRATE - TYPE II TOP (MODIFIED) (EA)	ITEM 0507567 MANHOLE FRAME	ITEM 0507682 MANHOLE - 5' DIAMETER	ITEM 0507701 RESET TYPE "C" CATCH BASIN	ITEM 0507721 RESET TYPE "C-L" CATCH BASIN	ITEM 0507748 RESET TYPE "C-L" CATCH BASIN DOUBLE GRATE - TYPE III	ITEM 0507758 RESET MANHOLE (STORM) (EA)	ITEM 0507899 OFFSET CATCH BASIN (EA)	ITEM 0651010 10" CONCRETE PIPE (LF)	ITEM 0651051 12" R.C. PIPE CLASS V (LF)	12" DUCTILE
1	FE33+91.86	1.70'R	MATCH EXIST. EL. 4.65	N/A		1				1					1						
2	FE34+92.53	2.75'R	MATCH EXIST. EL 4.44	N/A		2					1					1					
3	NW10+43.48	11.0'R	EL. 26.21	MATCH EXIST. INVERTS					1											8	
4	NW11+05.43	11.0'R	EL. 27.85	MATCH EXIST. INVERTS														1		8	
5	NW19+21.66	11.0'R	EL 23.21	MATCH EXIST. INVERTS				1											4	4	
6	NW22+35.11	11.0'R	EXISTING STRUCTURE TO REMAIN	N/A																	
7	NW25+68.75	11.0'R	EL. 17.25	MATCH EXIST. INVERTS														1		8	
8	NW25+97.26	13.65'R	EL. 17.27	N/A								1					1				
9	NW28+40.81	17.0'R	EL. 12.68	MATCH EXIST. INVERTS									1							8	
10	NW28+54.70	12.0'R		11.35 (ABOVE TELE. DUCT)					1												12
11	RI12+15.09	16.0'R	MATCH EXIST.	N/A	1		1							1							
12	RI12+15.09	16.0'L	MATCH EXIST.	N/A	1		1							1							

NOTE: EXISTING PIPES AND PIPE INVERTS TO BE VERIFIED IN FIELD.

]			
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REV.	DATE	DESCRIPTION	SHEET. NO.]			
REVISIONS							

DESIGNER: M. BORST


DRAFTER: M. BORST

CHECKED BY: S. NORMANDIN

ENGINEER: NV5

APPROVED BY:

CITY OF BRIDGEPORT

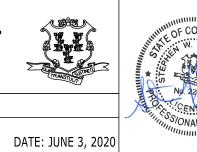

PEQUONNOCK RIVER TRAIL EXTENSION

CITY OF BRIDGEPORT

DRAWING TITLE:

DOT PROJ: 15-374

DRAWING NO.:

MT-1

SHEET NO:

MISCELLANEOUS TABLES - 1

53

GENERAL NOTES APPLICABLE TO ALL STAGES

- 1. THE CONTRACTOR SHALL NOTIFY THE CITY OF BRIDGEPORT AT LEAST 20 DAYS BEFORE THE START OF CONSTRUCTION TO SCHEDULE A PRE-CONSTRUCTION MEETING.
- 2. PRIOR TO ANY WORK PERMITS BEING ISSUED, A PRE-CONSTRUCTION MEETING WILL BE HELD TWENTY (20) DAYS IN ADVANCE BY CONSTRUCTION DIVISION. AT THAT TIME, THE CONTRACTOR SHALL PROVIDE A CONSTRUCTION SCHEDULE TO THE ENGINEER. ARRANGEMENTS FOR THE MEETING WILL BE COORDINATED BY THE CITY OF BRIDGEPORT.
- 3. CONSTRUCTION SEQUENCE: UNLESS OTHERWISE DIRECTED OR APPROVED BY THE ENGINEER, THE CONSTRUCTION SHALL BE COMPLETED IN THE FOLLOWING SEQUENCE:
 - CONSTRUCTION OF CATCH BASIN AND BASIN CONNECTIONS

CONSTRUCTION OF NEW CURBS

CONSTRUCTION OF NEW SIDEWALKS

RECONSTRUCTION OF ROADWAY PAVEMENTS

PAVEMENT MARKINGS

THE CONTRACTOR WILL BE PERMITTED TO MODIFY, ADJUST AND/OR COMBINE STAGES SUBJECT TO THE APPROVAL OF THE ENGÎNEER.

- 4. SUBSEQUENT STAGES MUST COMMENCE WITHIN SEVEN (7) CALENDAR DAYS OF THE COMPLETION OF THE PREVIOUS STAGE WITHIN EACH BLOCK, UNLESS OTHERWISE APPROVED BY THE CITY.
- 5. PROVISIONS FOR MULTIPLE WORK LOCATIONS:
 - a) AFTER A SATISFACTORY START OF THE WORK AT ONE LOCATION, AS APPROVED BY THE ENGINEER, THE CONTRACTOR WILL BE PERMITTED TO ESTABLISH MULTIPLE WORK AREAS WITH MULTIPLE CREWS AS APPROVED BY THE ENGINEER
 - b) THE WORK AREA IS NOT LIMITED TO ONE LOCATION. THE CONTRACTOR ONCE APPROVED IS EXPECTED TO WORK IN MULTIPLE LOCATIONS USING MULTIPLE CREWS AT ANY ONE TIME, AS APPROVED BY THE ENGINEER.
- 6. FOR ANY WORK PROCEEDING THROUGH AN INTERSECTION, THE CONTRACTOR MAY CLOSE ONE (1) CROSSWALK AT A TIME WHILE DIVERTING PEDESTRIANS TO OTHER AVAILABLE CROSSWALKS OR AS OTHERWISE DIRECTED BY THE ENGINEER. PEDESTRIANS SHALL BE PROTECTED FROM ALL EXCAVATION AREAS, THROUGH THE USE OF AN APPROVED BARRIER. FENCING OR OTHER TEMPORARY DEVICE, AND IN A MANNER APPROVED BY THE ENGINEER. STEEL PLATES IN PEDESTRIAN WALKWAYS SHALL BE EPOXY COATED, WITH FINISH, THAT ADHERES TO METAL. THIS NON-SLIP COATING SHALL HAVE RESISTANCE TO FIRE, GASOLINE, OIL, ACIDS, ALKALIS AND ASPHALTIC SOLVENTS. PRIOR TO INSTALLATION, THE CONTRACTOR SHALL SUBMIT THE TYPE OF EPOXY COATING ON STEEL PLATE TO THE ENGINEER FOR APPROVAL (NO SEPARATE PAYMENT).
- 7. TO PERMIT ADEQUATE VISIBILITY AT INTERSECTION AREAS ALL BARRICADES SHALL BE PLACED SO AS NOT TO HINDER PEDESTRIAN OR VEHICULAR SIGHT LINES. SIMILARLY, NO SHEETING SHALL EXTEND HIGHER THAN 24" ABOVE PAVEMENT LEVEL WITHIN 50 FEET OF AN INTERSECTION.
- 8. EXCAVATIONS SHALL BE COMPLETELY ENCLOSED WITH TIMBER CURBS, LIGHTED BARRICADES, TEMPORARY FENCE AND PLASTIC BARRELS UNLESS OTHERWISE SHOWN HEREIN OR DIRECTED BY THE ENGINEER. ALL BOUNDARIES BETWEEN CONSTRUCTION WORK AREAS AND PEDESTRIAN ROUTES ALONG SIDEWALKS SHALL BE CLEARLY AND CONTINUOUSLY DELINEATED WITH PEDESTRIAN STEEL BARRICADES AS SHOWN ON THE MAINTENANCE AND PROTECTION PLANS AND AS APPROVED OR DIRECTED BY THE ENGINEER. THIS WORK TO BE PAID UNDER THE MAINTENANCE AND PROTECTION OF TRAFFIC ITEM.


- 9. PEDESTRIAN CROSSING OVER EXCAVATIONS, WHEN REQUIRED, SHALL BE CONSTRUCTED WITH STEEL PLATES LINED WITH TEMPORARY FENCE ATTACHED ON BOTH SIDES. (NO DIRECT PAYMENT).
- 10. THE CONTRACTOR SHALL WORK IN ONE-HALF THE WIDTH OF INTERSECTING STREETS AT A TIME AND MAINTAIN THE OTHER HALF OPEN FOR VEHICULAR TRAFFIC UNLESS OTHERWISE INDICATED HEREIN, OR DIRECTED OR APPROVED BY THE ENGINEER.
- 11. ALL INTERSECTIONS SHALL BE OPEN TO TRAFFIC AFTER WORKING HOURS.
- 12. CONTRACTOR SHALL PROVIDE, PLACE, AND REMOVE STEEL PLATES TO MAINTAIN TRAFFIC OVER EXCAVATIONS AS REQUIRED. THERE WILL BE NO SEPARATE PAYMENT FOR PROVIDING, PLACING AND REMOVING STEEL PLATES OVER EXCAVATIONS TO MAINTAIN VEHICULAR AND PEDESTRIAN TRAFFIC. COST SHALL BE DEEMED INCLUDED IN THE PRICES BID FOR ALL SCHEDULED ITEMS.
- 13. MAINTENANCE OF PEDESTRIAN ACCESS TO ALL ABUTTING PROPERTIES, ENTRANCES, AND EXITS FROM DWELLINGS, EMERGENCY EXITS AND PEDESTRIAN USAGE OF CROSSWALK AND SIDEWALK AREAS BOTH NEW AND EXISTING SHALL BE CONTINUOUS AT ALL TIMES.
- 14. CONTRACTOR SHALL PROVIDE ACCESS FOR EMERGENCY TRAFFIC AT ALL TIMES UPON DEMAND. THE CONTRACTOR SHALL BE REQUIRED TO MOVE AND RESTORE BARRICADES AS ORDERED BY THE ENGINEER FOR EMERGENCY ACCESS AT NO DIRECT PAYMENT.
- 15. THE CONTRACTOR MUST PROVIDE ACCESS TO SCHOOL FOR SCHOOL BUSES AS DIRECTED BY ENGINEER.
- 16. THE CONTRACTOR SHALL SUPPLY, INSTALL, RELOCATE AND MAINTAIN SIGNS AND OTHER APPROVED DEVICES FOR WARNING, CONTROLLING, ROUTING, DIRECTING AND DETOURING TRAFFIC AS INDICATED AND AS DIRECTED BY THE ENGINEER AND IN ACCORDANCE WITH "MANUAL ON UNIFORM TRAFFIC CONTROL DEVICES". THE EXACT LOCATION, SIZE, WORKING AND DETAILS OF THE SIGN, PLANTS AND MOUNTINGS, AND OTHER DEVICES SHALL BE SUBJECT TO APPROVAL BY THE ENGINEER.
- 17. ALL SIGNS AND BARRICADES SHALL CONFORM TO STANDARDS SPECIFIED IN THE NATIONAL "MANUAL OF UNIFORM TRAFFIC CONTROL DEVICES" (EXCEPT WHERE OTHERWISE REQUIRED HEREIN) WHERE APPLICABLE AND APPROVED BY THE ENGINEER
- 18. ALL ADVANCE WARNING SIGNS SHALL BE INSTALLED BETWEEN 150 AND 200 FEET BEFORE THE CONSTRUCTION. ALL "END ROAD WORK" SIGNS SHALL BE INSTALLED 200 FEET AFTER THE CONSTRUCTION. TWO (2) 24"X24" ORANGE FLEXIBLE PLASTIC FLAGS SHALL BE ATTACHED TO THE TWO SIDE CORNERS OF EACH DIAMOND SHAPED ADVANCE WARNING SIGN.
- 19. ALL IDENTIFICATION MARKINGS ON BARRELS MUST NOT FACE TRAFFIC AND MUST BE BELOW THE BOTTOM REFLECTORIZED
- 20. THE CONTRACTOR SHALL EMPLOY AND ASSIGN TRAFFIC PERSONS AT LOCATIONS SPECIFIED BY THE ENGINEER TO ASSIST IN CONTROLLING THE FLOW OF TRAFFIC AS REQUIRED AND DIRECTED BY THE ENGINEER.
- 21. ALL CONTRACTOR'S VEHICLES, EQUIPMENT AND PERSONNEL MUST BE KEPT WITHIN THE DESIGNATED WORK AREAS.
- 22. NOTWITHSTANDING PROVISIONS HEREIN CONTAINED, IT REMAINS THE CONTRACTOR'S RESPONSIBILITY TO IMPLEMENT MINOR ADDITIONAL MEASURES THAT ARE NECESSARY TO PROVIDE FOR AND MAINTAIN THE SAFETY OF VEHICULAR TRAFFIC AND PEDESTRIANS DURING CONSTRUCTION. THE PROVISION AND USE OF SUPPLIES SUCH AS TRAFFIC CONES, HIGH VISIBILITY RIBBONS, AND FLAGS WHERE NECESSARY OR DIRECTED BY THE

ENGINEER: NV5


APPROVED BY:

ENGINEER, SHALL BE CONSIDERED AS MINOR AND INCIDENTAL ITEMS. PAYMENT TO BE INCLUDED IN THE PRICE BID FOR ALL SCHEDULED ITEMS.

- 24. IT IS THE CONTRACTOR'S RESPONSIBILITY TO COOPERATE WITH OTHER CONTRACTORS WHO HAVE AN ON-GOING STREET IMPROVEMENT CONSTRUCTION IN THE AREA AND/OR WITHIN THE PROJECT LIMITS AND SHALL SO ACCORDINGLY ARRANGE HIS OWN SCHEDULE OF CONSTRUCTION IN SUCH A TIME FRAME AS NOT TO DISRUPT OR INTERFERE WITH THE WORKABILITY OF EITHER MAINTENANCE OF TRAFFIC PLAN.
- 25. NO DEVIATION OR DEPARTURE FROM THESE STIPULATIONS WILL BE PERMITTED WITHOUT THE PRIOR WRITTEN APPROVAL FROM THE CITY OF BRIDGEPORT.
- 26. THE CONTRACTOR SHALL PROVIDE STORAGE AREAS OFF THE JOB SITE AS REQUIRED. (NO SEPARATE PAYMENT).
- 27. PROVISIONS FOR BUSES AND PASSENGERS:
 - a) THE CONTRACTOR SHALL MAINTAIN ACCESS TO AND EGRESS FROM BUSES AT ALL TIMES DURING EXECUTION OF THE WORK BY TEMPORARILY RELOCATING BUS STOPS AS DIRECTED AND APPROVED BY THE ENGINEER.
 - b) THE CONTRACTOR SHALL NOT COMMENCE WORKING IN THE AREA OF ANY EXISTING BUS STOP UNTIL IT HAS BEEN TEMPORARILY RELOCATED AS DIRECTED AND APPROVED BY THE ENGINEER.
 - c) THE CONTRACTOR SHALL KEEP THE AREA TO WHICH A BUS STOP IS RELOCATED FREE FROM AND UNDISTURBED BY ANY CONSTRUCTION ACTIVITY OR OTHER IMPEDIMENT DURING THE PERIOD OF IT'S USE AS A BUS STOP.
 - TEMPORARY RELOCATION OF BUS STOPS SHALL INCLUDE:
 - THE REMOVAL AND/OR BAGGING OF AFFECTED BUS STOP SIGNS, NO SEPARATE PAYMENT. (DO NOT REMOVE AND/OR BAG EXISTING BUS STOP ROUTE MAPS.)
 - THE INSTALLATION OF ONE "BUS STOP RELOCATED" SIGN (BLACK LETTERS ON ORANGE BACKGROUND) ON EXISTING POST, WITH THE FOLLOWING LEGEND:

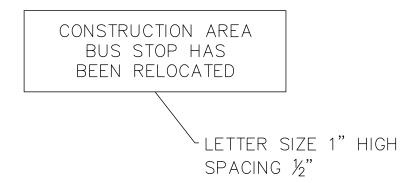


- THE INSTALLATION OF ONE "BUS STOP RELOCATION" SIGN (BLACK LETTERS ON ORANGE BACKGROUND) WITH THE FOLLOWING LEGEND:

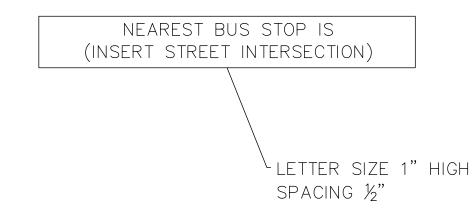

- CONTRACTOR SHALL FURNISH AND INSTALL TEMPORARY BUS STOP SIGN AS SHOWN BELOW

THE WORD TEMPORARY MUST BE ON BLACK LETTERS AND ON ORANGE BACKGROUND

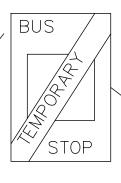

> STANDARD BUS STOP SIGN WITH WORD TEMPORARY ACROSS IT

- e) THE CONTRACTOR SHALL NOT WORK WITHIN AN AREA IN WHICH A BUS STOP HAS BEEN TEMPORARILY RELOCATED UNTIL REQUIRED WORK WITHIN THE AREA OF THE PERMANENT BUS STOP THEREOF HAS BEEN SUBSTANTIALLY COMPLETED INCLUDING TEMPORARY PAVEMENT RESTORATION, AND UNTIL THE AREA OF THE PERMANENT BUS STOP HAS BEEN RESTORED TO PUBLIC USE TO THE SATISFACTION AND APPROVAL OF THE ENGINEER.
- 28. AS THE WORK PROGRESSES, TEMPORARY TRAFFIC CONTROL DEVICES SHALL BE RELOCATED AND THE CONTRACTOR SHOULD REMOVE OR COVER ALL UNUSED SIGNS OR SIGNS NOT APPLICABLE FOR CURRENT OPERATIONS.
- 29. FOR ADDITIONAL INFORMATION SEE: " CONNECTICUT DEPARTMENT OF TRANSPORTATION SPECIAL PROVISIONS 0971001A-MAINTENANCE AND PROTECTION OF TRAFFIC".

LEGEND

TIMBER CURB

CONSTRUCTION WORK AREA

FLASHING ARROW BOARD

ONE WAY TRAFFIC (EXISTING)




TWO-WAY TRAFFIC (EXISTING)



NEW TRAFFIC DIRECTION DURI CONSTRUCTION

LIGHTED TIMBER BARRICADE

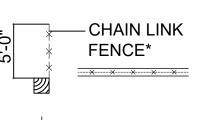

TIMBER CURB WITH FENCE


 \vdash

PEDESTRIAN STEEL BARRICADI

TEMPORARY SIGN WITH TEXT

PLASTIC BARRELS

JERSEY BARRIER OR TYPE III B.

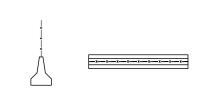

TEMPORARY CONCRETE BARR TEMPORARY CHAIN LINK FENCI

REV. DATE DESCRIPTION SHEET. NO. REVISIONS


DESIGNER: M. BORST

CHECKED BY: S. NORMANDIN

DRAFTER: M. BORST

CITY OF BRIDGEPORT



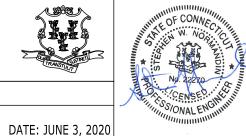

PEQUONNOCK RIVER TRAIL **EXTENSION**

CITY OF BRIDGEPORT

DRAWING NO.: MPT-1

DOT PROJ: 15-374

DRAWING TITLE MAINTENANCE AND PROTECTION OF SHEET NO.: TRAFFIC -1

54

CONSTRUCTION OF CATCH BASINS AND BASIN CONNECTIONS

- 1. THE CONTRACTOR SHALL UTILIZE THE BARRELS CONFIGURATION FOR BASIN EXCAVATION AND FOR THE BASIN CONNECTION PIPE AS INDICATED IN M.P.T. DETAIL FOR THIS STAGE.
- 2. THE CATCH BASINS SHALL NOT BE CONSTRUCTED ON BOTH SIDES OF THE STREET SIMULTANEOUSLY.
- 3. MAINTAIN ONE PEDESTRIAN CROSSING AT CORNERS AND MAINTAIN PEDESTRIAN TRAFFIC ON SIDEWALK AT ALL TIMES. A MINIMUM WIDTH OF FIVE (5) FEET OF SIDEWALK SHALL REMAIN CLEAR AT ALL TIMES.
- 4. AT THE END OF EACH DAY'S WORK, THE CONTRACTOR SHALL BACKFILL ALL TRENCHES AND PLACE TEMPORARY PAVEMENT OF BINDER MIXTURE (NO SEPARATE PAYMENT) TO MEET EXISTING PAVEMENT, OR PROVIDE STEEL PLATES AS APPROVED BY THE ENGINEER TO COMPLETELY COVER THE TRENCH. PAYMENT FOR STEEL PLATES ARE TO BE INCLUDED IN PRICES BID FOR ALL SCHEDULED ITEMS.

CONSTRUCTION OF NEW CURBS

- 1. THE CONTRACTOR WILL BE PERMITTED TO OCCUPY ONE LANE OF THE ROADWAY IMMEDIATELY ADJACENT TO THE CURB LINE TO REMOVE EXISTING CURB AND CONSTRUCT NEW CURB AS APPROVED AND DIRECTED BY THE ENGINEER.
- 2. THE CONTRACTOR SHALL INITIALIZE THE CONSTRUCTION OF NEW CURBS IN A WORK AREA OF 200 FEET ONLY. AFTER A SATISFACTORY START OF THE WORK, AS APPROVED AND DIRECTED BY THE ENGINEER, THE CONTRACTOR WILL BE PERMITTED TO EXTEND THE WORK AREA TO THE MAXIMUM LENGTH OF 600 FEET.
- 3. PLACE PLASTIC BARRELS TO DELINEATE THE WORK AREA WIDTH AND PEDESTRIAN STEEL BARRICADES FOR THE PROTECTION OF PEDESTRIANS AS SHOWN IN TYPICAL PLANS AND AS DIRECTED BY THE ENGINEER.
- 4. PLACE CONSTRUCTION SIGNS AS SHOWN IN TYPICAL PLANS AND AS REQUIRED BY THE ENGINEER.
- 5. STRAIGHT CURB AND CORNER CURB SHALL NOT BE DISTURBED SIMULTANEOUSLY WITHIN THE SAME BLOCK.
- 6. MAINTAIN PEDESTRIAN CROSSING AT CORNERS AT ALL TIMES BY RELOCATION OF CROSSWALKS TO AREA OF STRAIGHT CURB ADJACENT TO CORNERS UNDER CONSTRUCTION. ONLY ONE CORNER AT A TIME, PER INTERSECTION MAY BE CONSTRUCTED, EXCEPT AS OTHERWISE APPROVED BY THE ENGINEER.
- 7. MAINTENANCE OF PEDESTRIAN ACCESS TO ALL ABUTTING PROPERTIES, ENTRANCES AND EXITS FROM DWELLINGS, EMERGENCY EXITS AREAS SHALL BE CONTINUOUS AT ALL TIMES.
- 8. UPON COMPLETION OF CURB WORK AT EACH LOCATION THE CONTRACTOR SHALL BACKFILL AROUND CURB AND PLACE 4" ASPHALTIC CONCRETE MIXTURE TO RESTORE STREET. RESTORE SIDEWALK WITH 2" ASPHALTIC CONCRETE MIXTURE AT CORNERS ONLY WHERE DIRECTED BY THE ENGINEER. MAINTAIN PEDESTRIAN TRAFFIC AT CROSSWALK AREAS.
- 9. UPON COMPLETION OF EACH DAYS WORK THE CONTRACTOR SHALL RELOCATE THE BARRELS AND BARRICADES ADJACENT TO THE CURB. THERE SHALL BE NO DIRECT PAYMENT FOR THE DAILY RELOCATION OF BARREL AND BARRICADES HEREUNDER.
- 10. EACH DAY THE WORK AREA MAY BE ADVANCED A MAXIMUM DISTANCE EQUAL TO THE LENGTH OF CURB SUBSTANTIALLY COMPLETED ON THAT DAY, WHICH SHALL BE DEFINED AS INCLUDING TEMPORARY PAVEMENT RESTORATION, AS APPROVED BY THE ENGINEER.
- 11. WORKING SIMULTANEOUSLY ON BOTH SIDES OF THE STREET WILL NOT BE PERMITTED.

CONSTRUCTION OF NEW SIDEWALKS

- 1. SIDEWALK CONSTRUCTION SHALL PROCEED IMMEDIATELY UPON COMPLETION OF CURB AS DIRECTED BY THE ENGINEER.
- 2. THE CONTRACTOR SHALL PROVIDE AND INSTALL BARRICADES, LIGHTS AND WARNING SIGNS TO DELINEATE THE WORK AREAS AS SHOWN ON PLAN.
- 3. THE CONTRACTOR WILL BE PERMITTED TO OCCUPY ONE LANE OF THE ROADWAY IMMEDIATELY ADJACENT TO THE CURB TO REMOVE EXISTING SIDEWALK AND CONSTRUCT NEW SIDEWALK AS APPROVED AND DIRECTED BY THE ENGINEER.
- 4. THE CONTRACTOR SHALL CLOSE THE SIDEWALK AND DIVERT PEDESTRIANS AROUND THE WORK AREA AS INDICATED ON THE PLANS OR AS DIRECTED BY THE ENGINEER.
- 5. SIDEWALK ADJACENT TO CORNER CURBS AND SIDEWALK ADJACENT TO STRAIGHT CURB SHALL NOT BE DISTURBED SIMULTANEOUSLY WITHIN THE SAME BLOCK.
- 6. THE CONTRACTOR SHALL FURNISH, INSTALL AND REMOVE TEMPORARY PEDESTRIAN PASSAGEWAY, AND PROVIDE TEMPORARY PEDESTRIAN BRIDGES IN ACCORDANCE WITH TYPICAL PLAN TO FACILITATE THE FLOW OF PEDESTRIAN TRAFFIC AND ACCESS TO PRIVATE PROPERTY AS AND WHERE DIRECTED BY THE ENGINEER.
- 7. THE CONTRACTOR SHALL LIMIT THE EXTENT OF EXISTING SIDEWALK REMOVED EACH DAY TO THE SAME AREA OF CONCRETE SIDEWALK THAT WILL BE REPLACED ON THAT DAY. NO OPEN EXCAVATION SHALL REMAIN AT THE END OF EACH DAY'S WORK.
- 8. PROVIDE SMOOTH TRANSITION WITH ASPHALTIC CONCRETE MIXTURE BETWEEN SIDEWALK COMPLETED AND WORK YET TO BE STARTED.
- 9. CONTRACTOR SHALL PROVIDE LOCAL PEDESTRIAN ACCESS AT ALL TIMES FOR NORMAL BUILDING ACTIVITY.
- 10. AFTER COMPLETING THE WORK IN THE SIDEWALK AREA THE CONTRACTOR SHALL REMOVE ALL BARRICADES, LIGHTS, TEMPORARY SIGNS AND OTHER WARNING DEVICES AND ALL SURPLUS CONSTRUCTION MATERIAL, AND SHALL REOPEN THE SIDEWALK TO PEDESTRIAN TRAFFIC AS DIRECTED BY ENGINEER.

CONSTRUCTION OF ROADWAY PAVEMENT

- 1. THE CONTRACTOR SHALL ESTABLISH A WORK ZONE AS SHOWN IN TYPICAL PLANS, FOR THE CONSTRUCTION OF ROADWAY PAVEMENT.
- 2. MAINTAIN AT LEAST ONE PEDESTRIAN CROSSWALK AT EACH CORNER. PEDESTRIAN TRAFFIC SHALL BE DETOURED AROUND WORK ZONE.
- 3. MAINTENANCE OF PEDESTRIAN ACCESS TO ALL ABUTTING PROPERTIES, ENTRANCES AND EXITS FROM DWELLINGS, AND PEDESTRIAN USAGE OF THE SIDEWALK AREAS, SHALL BE CONTINUOUS AT ALL TIMES.
- 4. AFTER THE COMPLETION OF NEW PAVEMENT BASE AND CURING, RAMP AROUND MANHOLE HEADS WITH TEMPORARY ASPHALTIC MIXTURE. REMOVE BARRICADES, BARRELS AND OTHER TEMPORARY DEVICES AND OPEN THE ROADWAY FOR TRAFFIC, AS DIRECTED BY THE ENGINEER.
- 5. AFTER COMPLETION OF PAVEMENT IN THE WORK AREA, THE CONTRACTOR SHALL REMOVE BARRICADES, BARRELS, FENCING AND CONSTRUCTION SIGNS. OPEN FULL ROADWAY TO TRAFFIC AS DIRECTED BY THE ENGINEER.

REV. DATE	DESCRIPTION	SHEET. NO.

ENGINEER: NV5

APPROVED BY:

DESIGNER: M. BORST

DRAFTER: M. BORST

CHECKED BY: S. NORMANDIN

CITY OF BRIDGEPORT



DATE: JUNE 3, 2020



PEQUONNOCK RIVER TRAIL **EXTENSION**

CITY OF BRIDGEPORT

DOT PROJ: 15-374

DRAWING TITLE MAINTENANCE AND PROTECTION OF SHEET NO.: TRAFFIC -2

MPT-2 55

DRAWING NO.:

	TEMPOR	RARY	TRA	FFIC	SIGNS TABLE
NAME	SIGN	MUTCD CODE	COLOR CODE	SIZE	DESCRIPTION
(A)	ROAD WORK AHEAD	W20-1	Α	36"X36"	ROAD WORK AHEAD
(DL)		W1-4L	Α	30"X30"	LARGE ARROW KEEP LEFT
(DR)		W1-4R	Α	30"X30"	LARGE ARROW KEEP RIGHT
(K)	SIDEWALK CLOSED AHEAD CROSS HERE SIDEWALK CLOSED AHEAD CROSS HERE	R9-11	В	24"X12"	SIDEWALK CLOSED, CROSS HERE (WITH ARROW)
(L)	SIDEWALK CLOSED USE OTHER SIDE SIDEWALK CLOSED USE OTHER SIDE	R9-10	В	24"X12"	SIDEWALK CLOSED, USE OTHER SIDE (WITH ARROW)
(O)	END ROAD WORK	G20-2	Α	36"X18"	END ROAD WORK
(X)	SIDEWALK CLOSED	R9-9	В	24"X12"	SIDEWALK CLOSED, USE WALKWAY
(Y)	LEFT LANE CLOSED AHEAD RIGHT LANE CLOSED AHEAD	W20-5	Α	36"X36"	LANE CLOSED AHEAD

	COLOR CODE LEGEND
CODE	DESCRIPTION
Α	BLACK LEGEND AND BORDER ON AN ORANGE BACKGROUND
В	BLACK LEGEND AND BORDER ON A WHITE BACKGROUND

- 1. ALL SIGNS AS PER LATEST EDITION OF THE NATIONAL "MANUAL ON UNIFORM TRAFFIC CONTROL DEVICES".
- 2. DIMENSIONS ARE SHOWN IN INCHES AND ARE SHOWN AS WIDTH x HEIGHT.
- 3. THESE TABLES ARE FOR REFERENCE PURPOSES ONLY. FOR ADDITIONAL SIGNAGE NOT SHOWN ON THESE TABLES (REFER TO THE MUTCD).

- 4. ALL SIGNS TO BE REFLECTORIZED.
 5. LETTERS ON SIGNS TO BE 5" HIGH.
 6. SIGN LOCATION TO BE DETERMINED BY THE ENGINEER.
 7. MOUNTING OF SIGNS TO BE AS DIRECTED AND APPROVED BY THE ENGINEER.


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REV.	DATE	DESCRIPTION	SHEET. NO.
•		REVISIONS	

DESIGNER: M. BORST DRAFTER: M. BORST

APPROVED BY:

CHECKED BY: S. NORMANDIN

CITY OF BRIDGEPORT ENGINEER: NV5

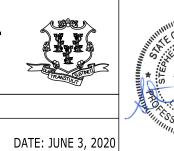





PEQUONNOCK RIVER TRAIL **EXTENSION**


CITY OF BRIDGEPORT


DOT PROJ: 15-374 DRAWING NO.: MPT-3

DRAWING TITLE: MAINTENANCE AND PROTECTION OF SHEET NO.: TRAFFIC -3

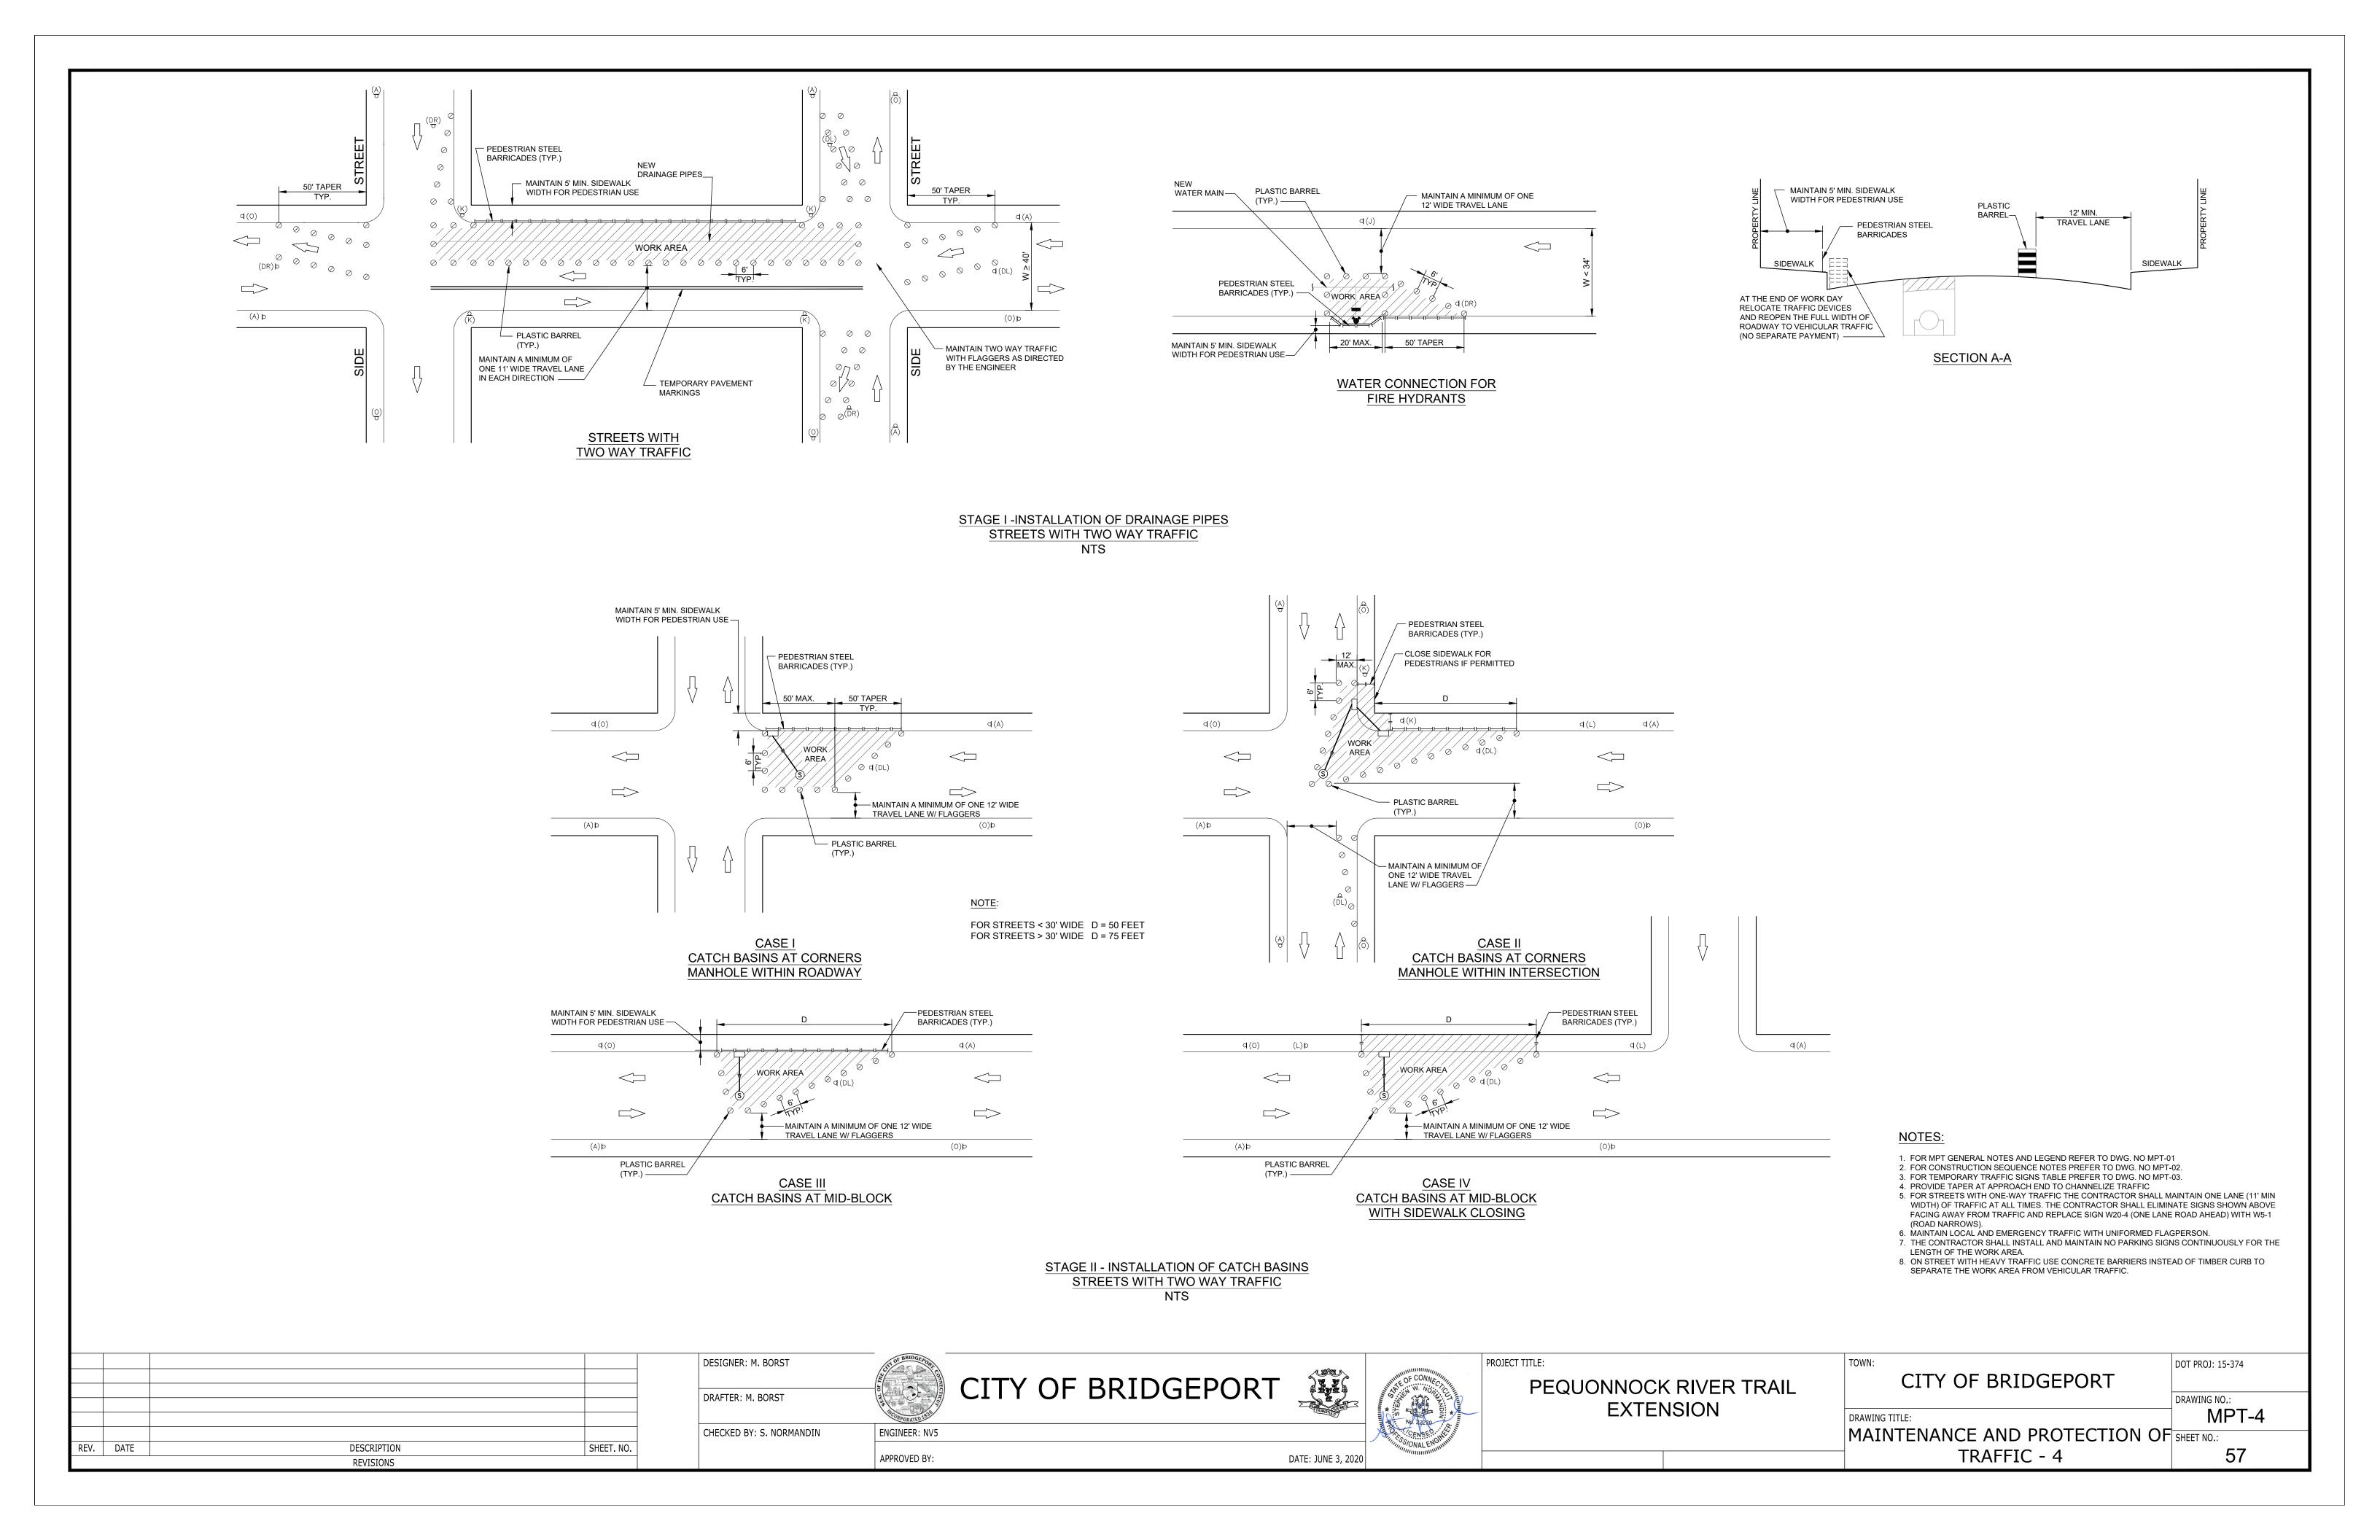


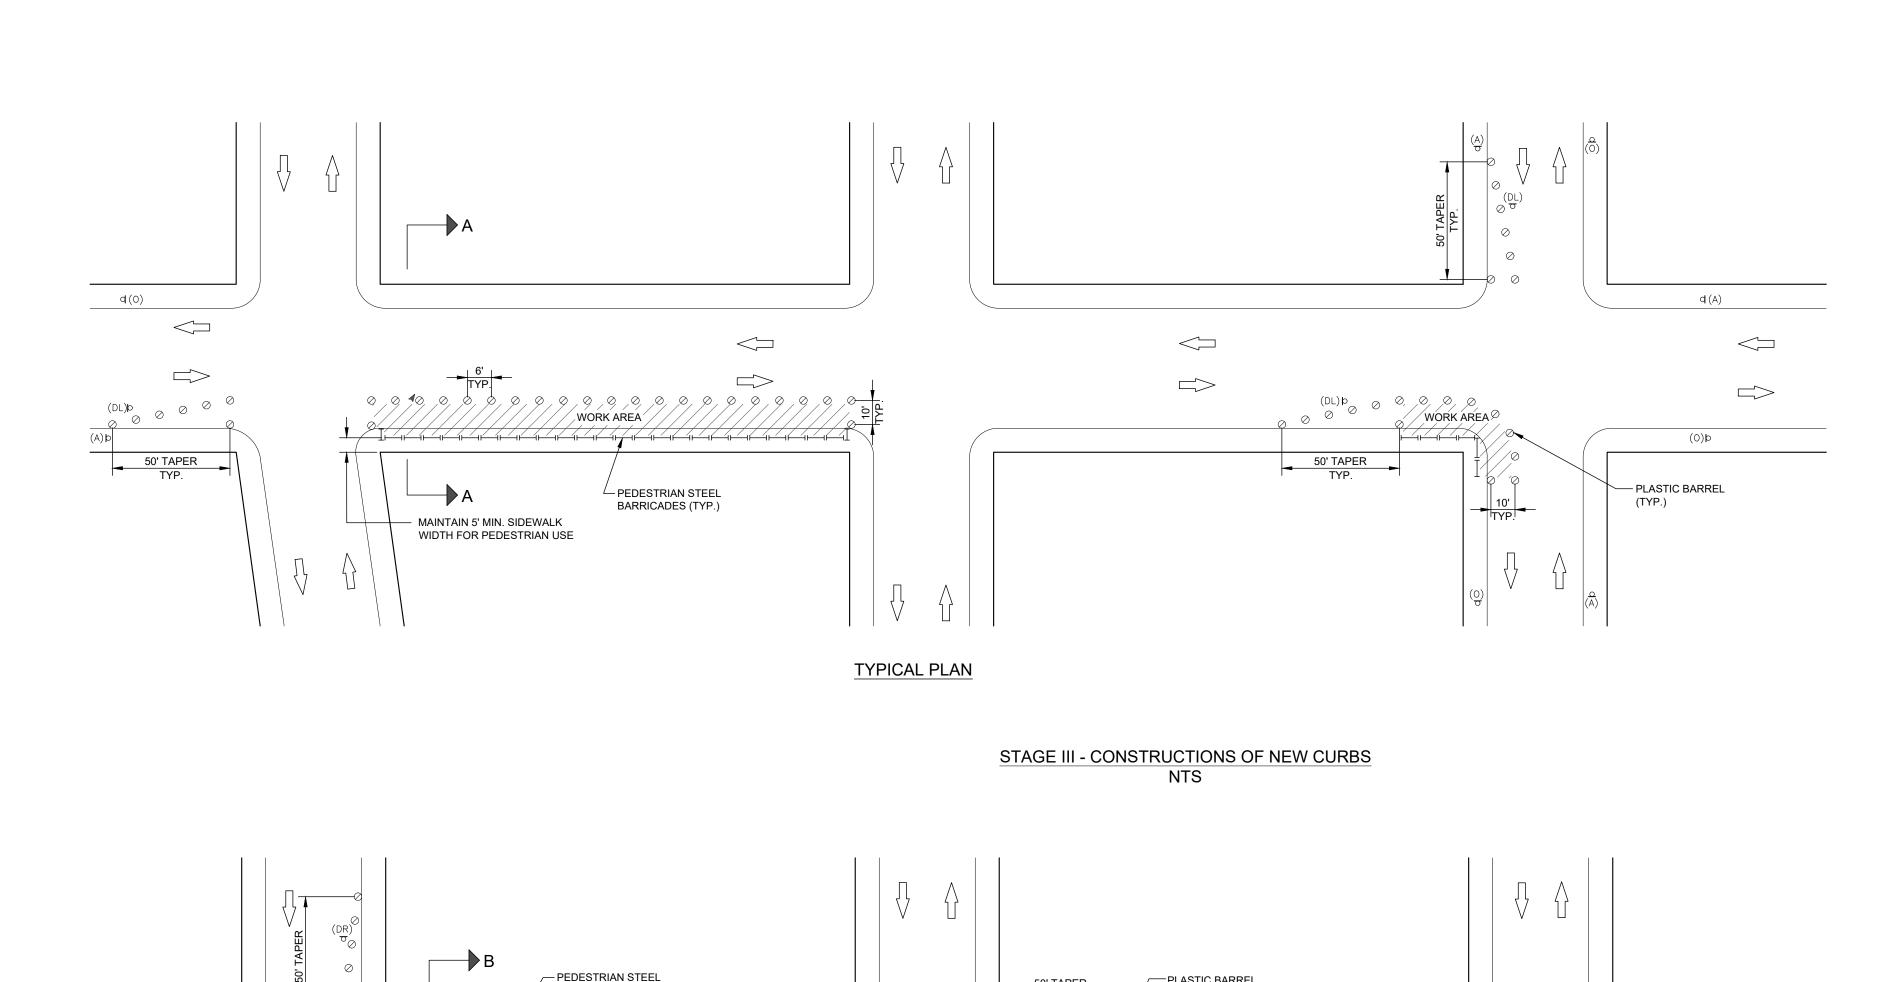

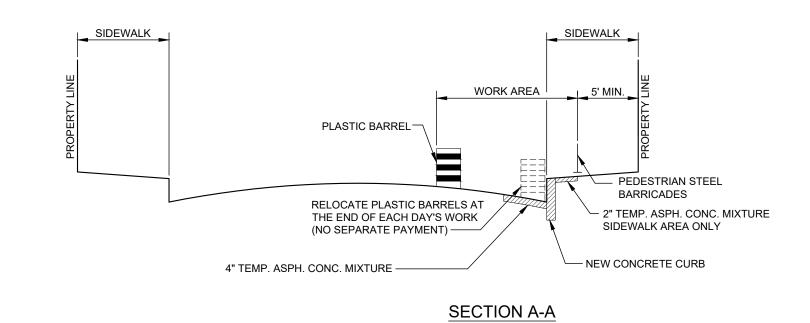

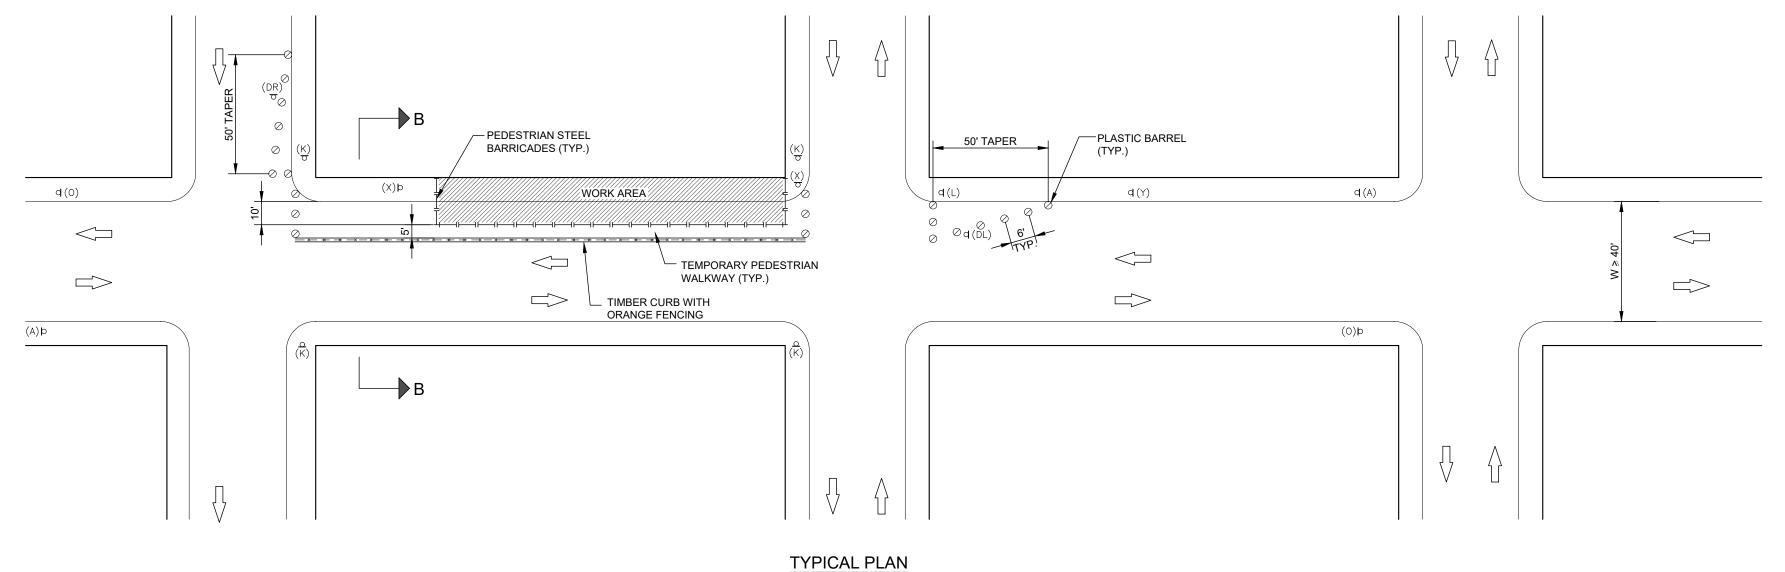

STAGE IV - CONSTRUCTIONS OF NEW SIDEWALKS

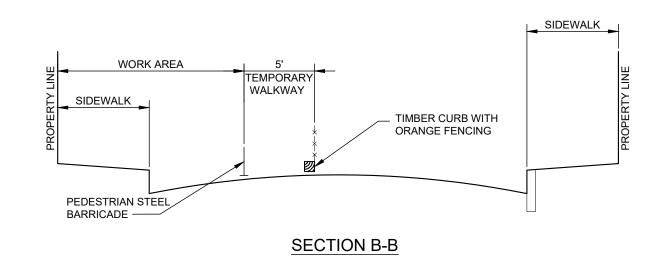


NOTES:

- FOR MPT GENERAL NOTES AND LEGEND REFER TO DWG. NO MPT-01
 FOR CONSTRUCTION SEQUENCE NOTES PREFER TO DWG. NO MPT-02.
- 3. FOR TEMPORARY TRAFFIC SIGNS TABLE PREFER TO DWG. NO MPT-03.
- 4. PROVIDE TAPER AT APPROACH END TO CHANNELIZE TRAFFIC
- 5. FOR STREETS WITH ONE-WAY TRAFFIC THE CONTRACTOR SHALL MAINTAIN ONE LANE (11' MIN WIDTH) OF TRAFFIC AT ALL TIMES. THE CONTRACTOR SHALL ELIMINATE SIGNS SHOWN ABOVE FACING AWAY FROM TRAFFIC AND REPLACE SIGN W20-4 (ONE LANE ROAD AHEAD) WITH W5-1
- MAINTAIN LOCAL AND EMERGENCY TRAFFIC WITH UNIFORMED FLAGPERSON.
 THE CONTRACTOR SHALL INSTALL AND MAINTAIN NO PARKING SIGNS CONTINUOUSLY FOR THE LENGTH OF THE WORK AREA.
- 8. ON STREET WITH HEAVY TRAFFIC USE CONCRETE BARRIERS INSTEAD OF TIMBER CURB TO SEPARATE THE WORK AREA FROM VEHICULAR TRAFFIC.

REV.	DATE	DESCRIPTION	SHEET. NO.
		REVISIONS	

DESIGNER: M. BORST DRAFTER: M. BORST CHECKED BY: S. NORMANDIN ENGINEER: NV5 APPROVED BY:


CITY OF BRIDGEPORT

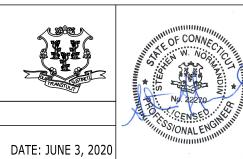


PEQUONNOCK RIVER TRAIL **EXTENSION**

DOT PROJ: 15-374 CITY OF BRIDGEPORT DRAWING NO.: MPT-5 DRAWING TITLE:

MAINTENANCE AND PROTECTION OF SHEET NO.: TRAFFIC - 5

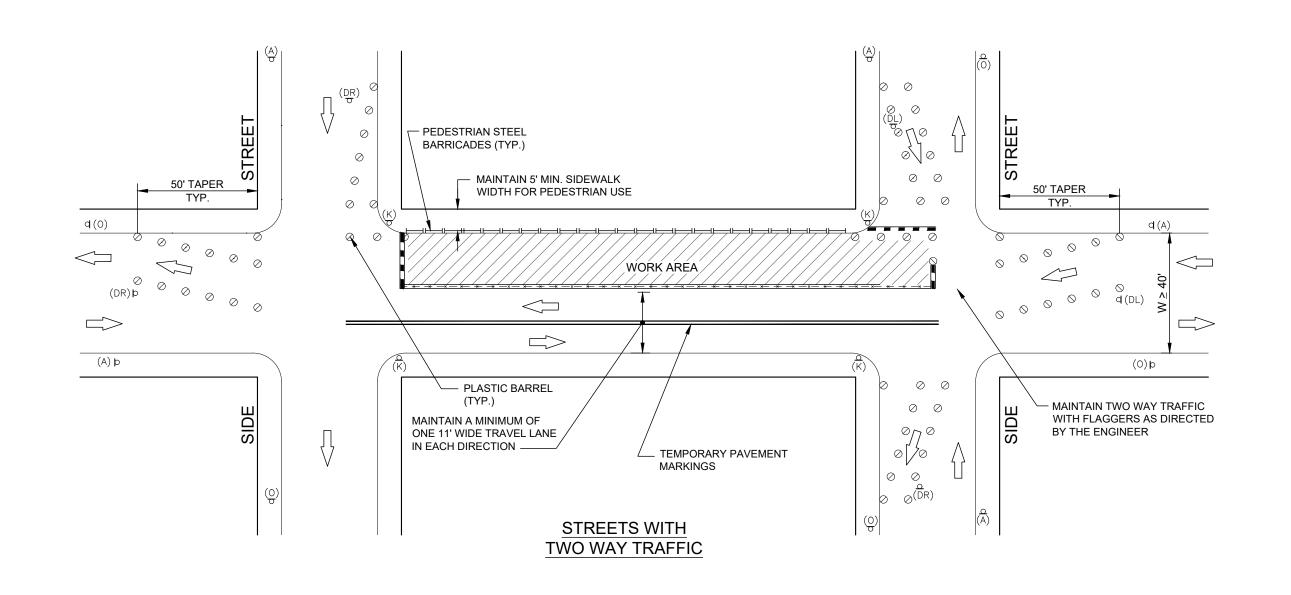

STAGE V - RECONSTRUCTIONS OF ROADWAY PAVEMENTS

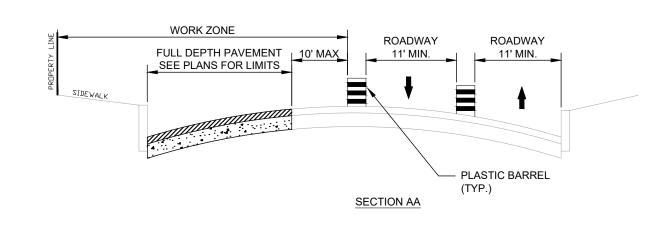

NOTES:

- 1. FOR MPT GENERAL NOTES AND LEGEND REFER TO DWG. NO MPT-01
- 2. FOR CONSTRUCTION SEQUENCE NOTES PREFER TO DWG. NO MPT-02.
 3. FOR TEMPORARY TRAFFIC SIGNS TABLE PREFER TO DWG. NO MPT-03.
- 4. PROVIDE TAPER AT APPROACH END TO CHANNELIZE TRAFFIC

 5. FOR STREETS WITH ONE-WAY TRAFFIC THE CONTRACTOR SHALL MAINTAIN ONE LANE (11' MIN WIDTH) OF TRAFFIC AT ALL TIMES. THE CONTRACTOR SHALL ELIMINATE SIGNS SHOWN ABOVE FACING AWAY FROM TRAFFIC AND REPLACE SIGN W20.4 (ONE LANE ROAD AHEAD) WITH W5-1.
- WIDTH) OF TRAFFIC AT ALL TIMES. THE CONTRACTOR SHALL ELIMINATE SIGNS SHOWN ABOVE FACING AWAY FROM TRAFFIC AND REPLACE SIGN W20-4 (ONE LANE ROAD AHEAD) WITH W5-1 (ROAD NARROWS).
- 6. MAINTAIN LOCAL AND EMERGENCY TRAFFIC WITH UNIFORMED FLAGPERSON.
 7. THE CONTRACTOR SHALL INSTALL AND MAINTAIN NO PARKING SIGNS CONTINUOUSLY FOR THE LENGTH OF THE WORK AREA.
- 8. ON STREET WITH HEAVY TRAFFIC USE CONCRETE BARRIERS INSTEAD OF TIMBER CURB TO SEPARATE THE WORK AREA FROM VEHICULAR TRAFFIC.

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REV.	DATE	DESCRIPTION	SHEET. NO.
		REVISIONS	·

DESIGNER: M. BORST


DRAFTER: M. BORST


CHECKED BY: S. NORMANDIN

ENGINEER: NV5

APPROVED BY:

CITY OF BRIDGEPORT

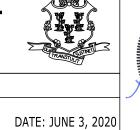

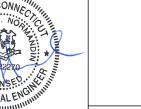

PEQUONNOCK RIVER TRAIL EXTENSION

CITY OF BRIDGEPORT	DOT PROJ: 15-374
	DRAWING NO.:
DRAWING TITLE:	MPT-

DRAWING NO.:

MPT-6

SHEET NO.:


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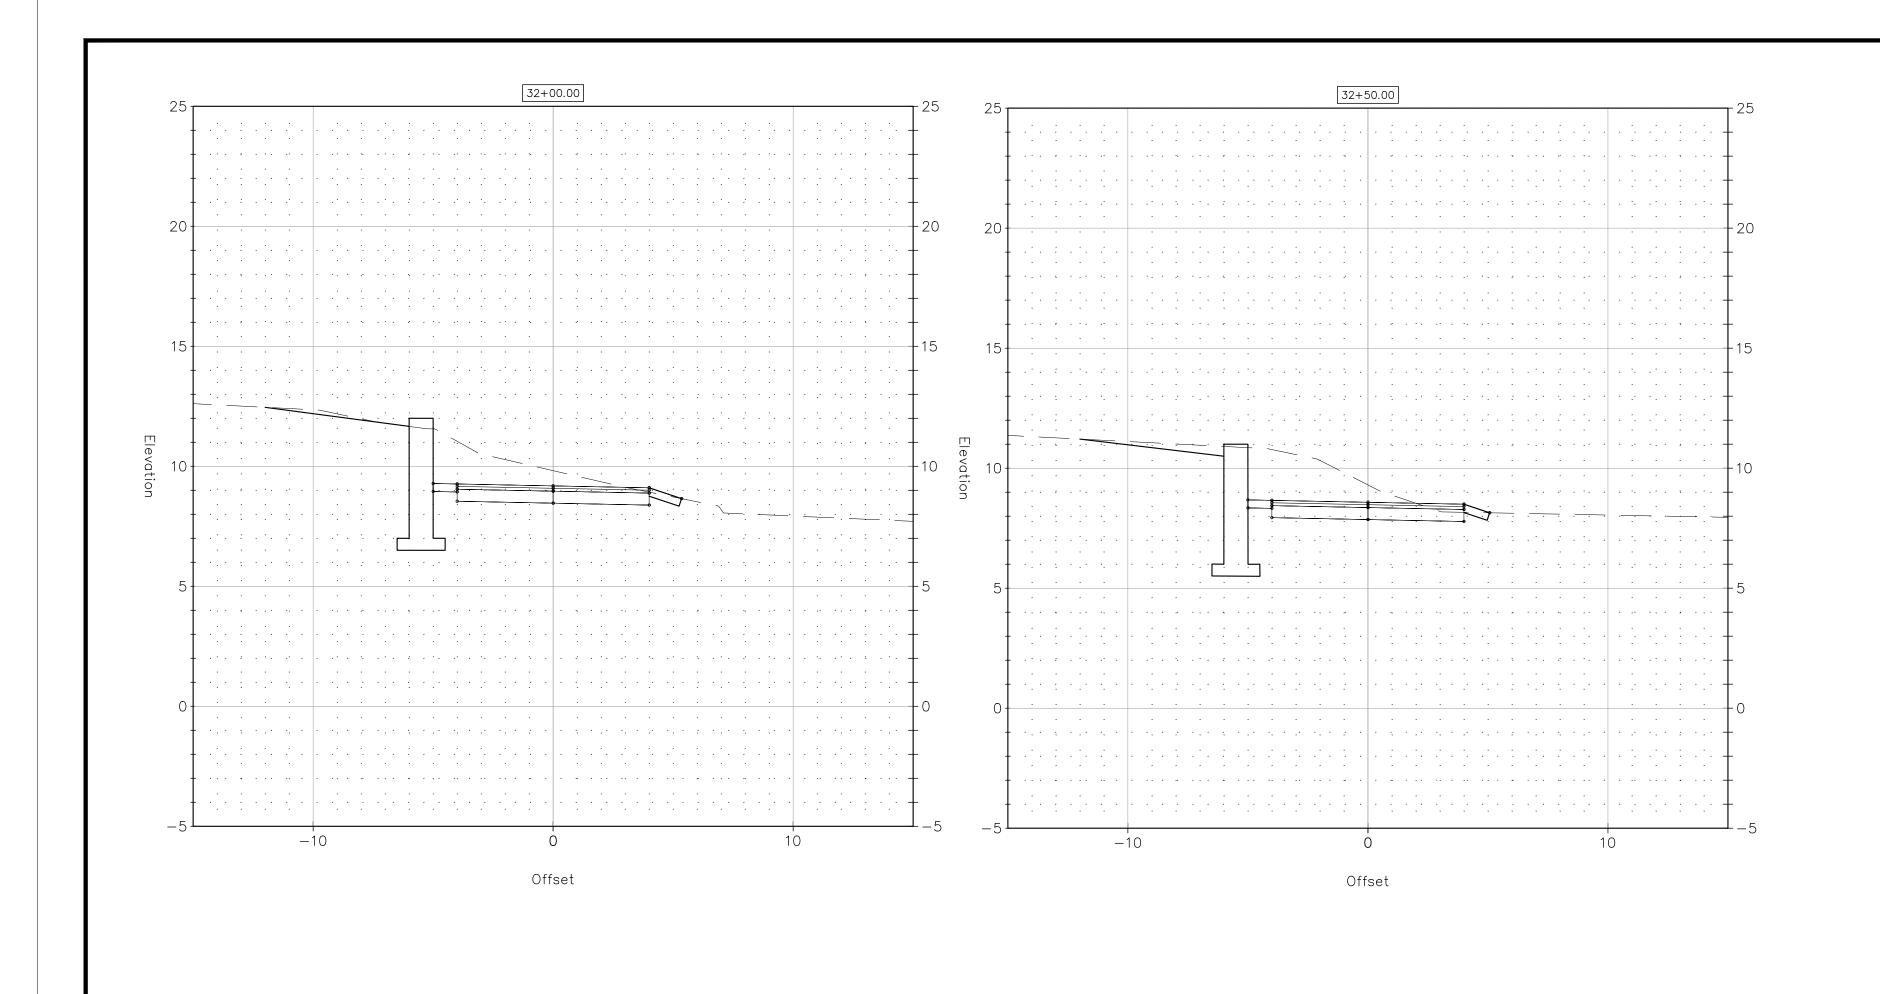
TRAFFIC - 6


TRAFFIC - 6

TOP 1 -

FERRY ALIGNMENT FULL DEPTH PROFILE Station 30+00 31+00 32+00 LENGTH: 50.000VC K-VALUE: 27.14 START ELEV.: 9.30 END ELEV.: 9.44 LENGTH: 90.000VC K-VALUE: 29.41 START ELEV.: 9.17 END ELEV.: 8.19 LENGTH: 50.000VC K-VALUE: 46.21 START ELEV.: 8.98 END ELEV.: 8.93 PROPOSED PROFILE (TYP.) EXISTING PROFILE (TYP) -EXISTING GRADE (TYP.) PROPOSED GRADE (TYP.) 29+00 30+00 31 + 0032+00 33+00 VERT. SCALE IN FEET DESIGNER: M. BORST DOT PROJ: 15-374 CITY OF BRIDGEPORT CITY OF BRIDGEPORT PEQUONNOCK RIVER TRAIL DRAFTER: M. BORST DRAWING NO.: **EXTENSION** PR-1 DRAWING TITLE: PROFILE-1 ENGINEER: NV5 CHECKED BY: S. NORMANDIN REV. DATE DESCRIPTION FERRY AREA SHEET. NO. 60 APPROVED BY: DATE: JUNE 3, 2020 REVISIONS



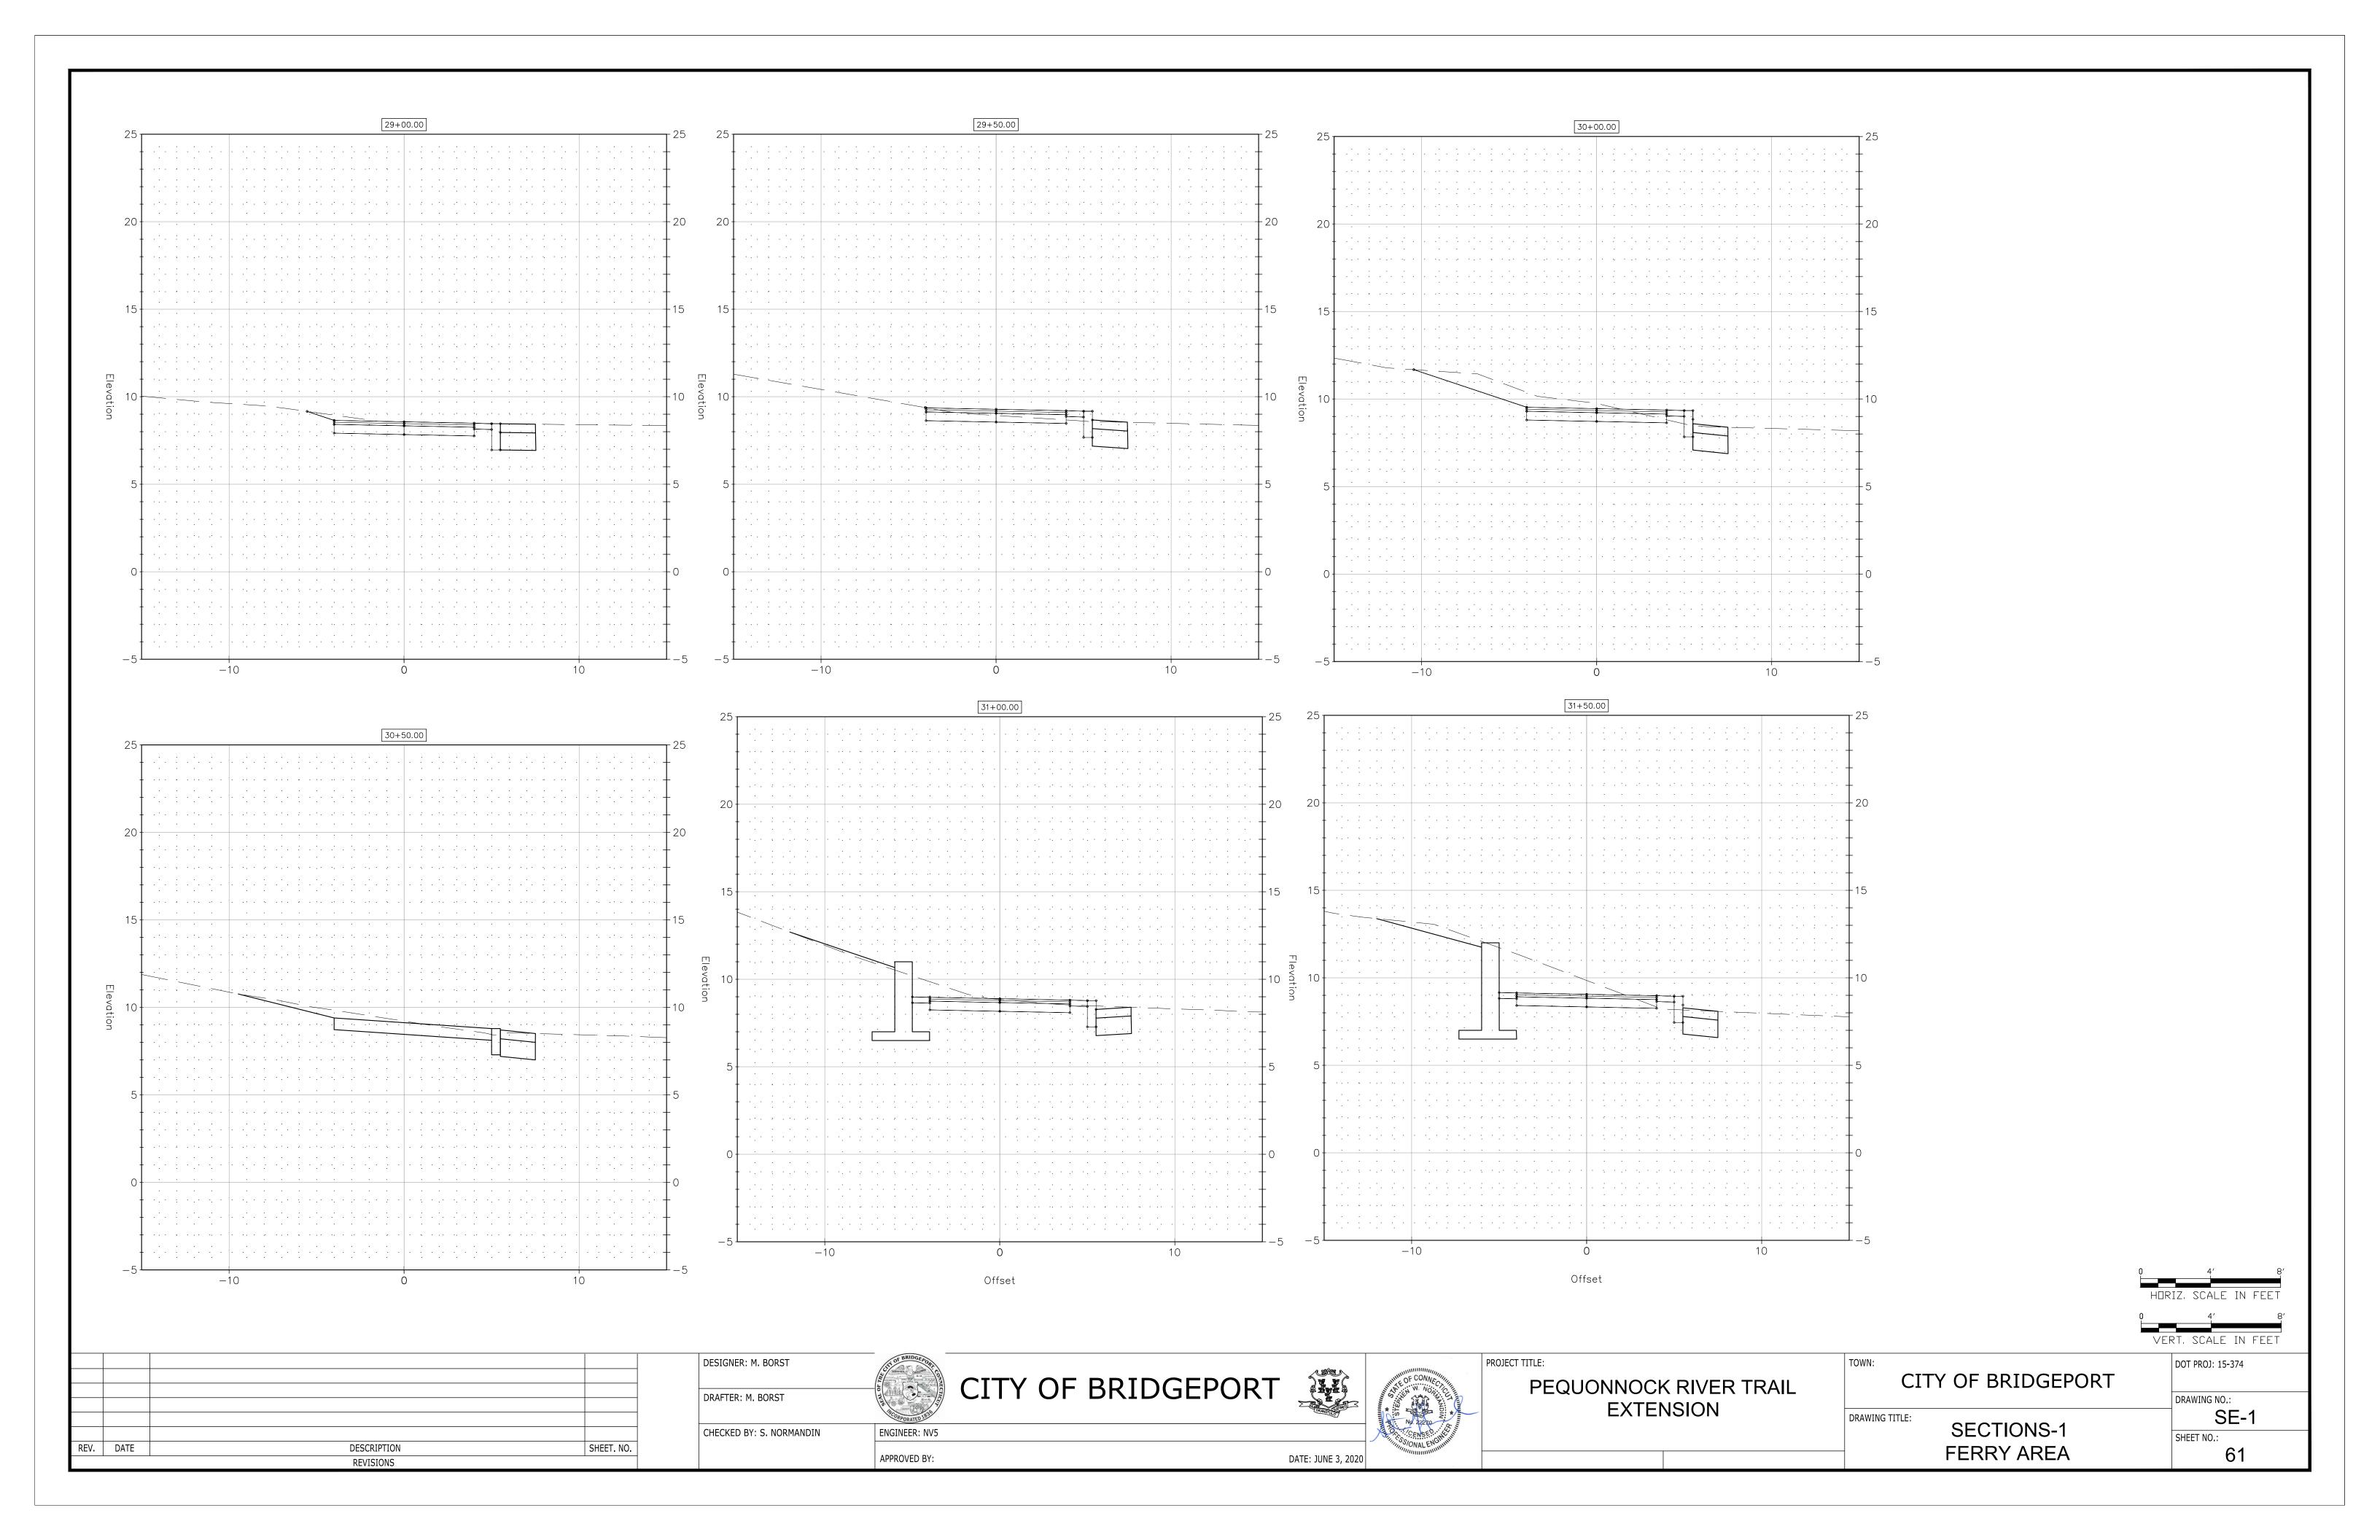

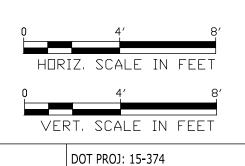

DRAWING NO.:

REV. DATE DESCRIPTION SHEET. NO.
REVISIONS

DESIGNER: M. BORST

DRAFTER: M. BORST


CHECKED BY: S. NORMANDIN

ENGINEER

ENGINEER: NV5

APPROVED BY:

CITY OF BRIDGEPORT

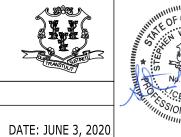

PEQUONNOCK RIVER TRAIL EXTENSION


CITY OF BRIDGEPORT


CITT OF BRIDGLPORT

DRAWING TITLE:

SECTIONS-2 FERRY AREA

SE-2
SHEET NO.:
62

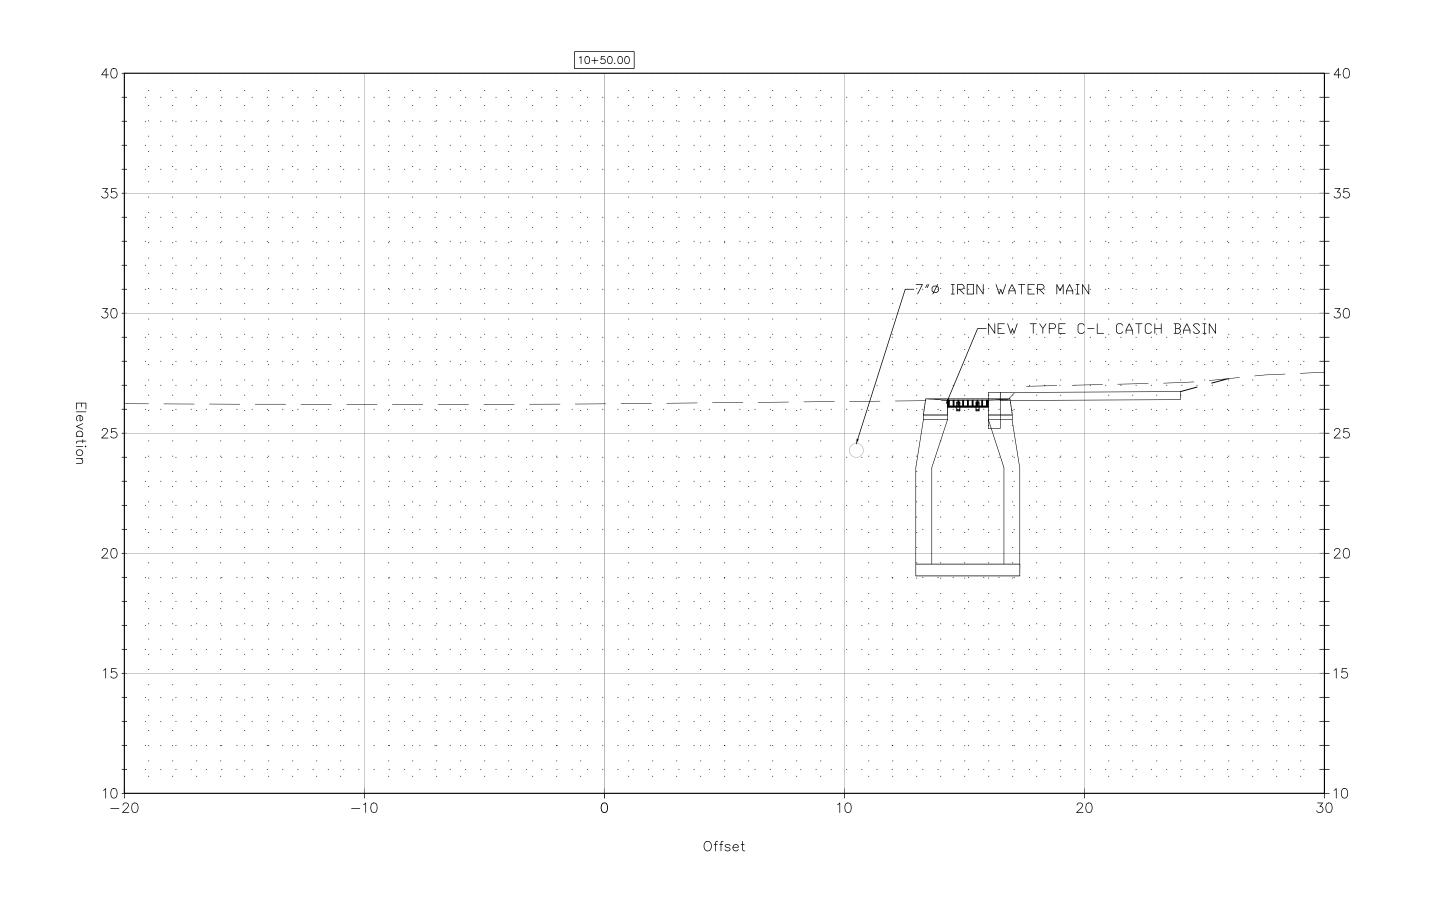

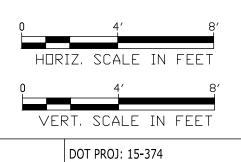

REV.	DATE	DESCRIPTION	SHEET. NO.
•		DEVICIONS	

DESIGNER: M. BORST DRAFTER: M. BORST CHECKED BY: S. NORMANDIN ENGINEER: NV5

APPROVED BY:

CITY OF BRIDGEPORT



PEQUONNOCK RIVER TRAIL **EXTENSION**

CITY OF BRIDGEPORT

DRAWING TITLE: SECTIONS-3

DRAWING NO.: SE-3 NORTH WASHINGTON AVENUE 63

